MUNICIPAL OFFICES



Town of Northfield, Vermont www.northfield-vt.gov

Phone 1-802-485-6121 Fax 1-802-485-8426

51 SOUTH MAIN STREET NORTHFIELD, VERMONT 05663

TOWN OF NORTHFIELD, VERMONT SELECT BOARD REGULAR MEETING Tuesday, August 12, 2025 COMMUNITY ROOM - 7:00 P.M.

This ZOOM meeting can be attended either in person or from your computer, tablet, or smartphone.

https://us06web.zoom.us/j/84183919223?pwd=MFTUidfSNRbVy1acDAoa2fg4ccdMZY.1

You can also dial in using your phone: 1-929-436-2866 Meeting ID: 841 8391 9223 Passcode: 942574


AGENDA

- I. ROLL CALL
- II. SET/ADJUST AGENDA
- III. PUBLIC PARTICIPATION (SCHEDULED):
 - a. Gary Laroche P.E., VTrans Project Manager: Main Street Bridge Replacement Project Update
- IV. APPROVAL OF MINUTES
 - a. July 22, 2025 (Regular Meeting)
- V. APPROVAL OF BILLS
 - a. Approval of Warrant #03-26 & #03-26A-F
 - b. Receipt of Biweekly Payroll through July 20, 2025: \$120,488.22
 - c. Receipt of Biweekly Payroll through August 3, 2025: \$115,088.87

VI. SELECT BOARD

- a. Cheney Farm Post-Construction Parking and Accessibility
- b. CVRPC Public Works Emergency Mutual Aid Agreement
- c. Northfield Ambulance Abatements
- d. Slaughterhouse Road Drainage
- e. Community Communication Policy
- f. Budget Priorities
- VII. TOWN MANAGER'S REPORT
- **VIII. BOARD MEMBERS' COMMENTS, CONCERNS, QUESTIONS**
- IX. PUBLIC PARTICIPATION (UNSCHEDULED)
- X. EXECUTIVE SESSION (IF NEEDED)
 - a. Legal/Personnel/Contracts [1 VSA 313 (a)(1)]
- XI. ADJOURNMENT



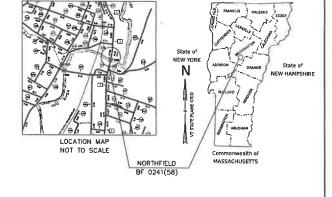

CANADA

PROPOSED IMPROVEMENT BRIDGE PROJECT TOWN OF NORTHFIELD COUNTY OF WASHINGTON

ROUTE NO: VT ROUTE 12, TH-1 MAIN ST. (CLASS 1), MAJOR COLLECTOR, BRIDGE NO: 60


PROJECT LOCATION:

LOCATED IN THE TOWN OF NORTHFIELD ON VT ROUTE 12, BRIDGE 60 OVER DOG RIVER, APPROXIMATELY 1.1 MILES NORTH OF THE JUNCTION WITH VT ROUTE 12A SOUTH.

PROJECT DESCRIPTION:

REMOVAL AND REPLACEMENT OF BRIDGE NO. 60 WITH RELATED APPROACH ROADWAY AND CHANNEL WORK.

LENGTH OF STRUCTURE: 141.66 FEET LENGTH OF ROADWAY: 133.34 FEET LENGTH OF PROJECT: 275.00 FEET

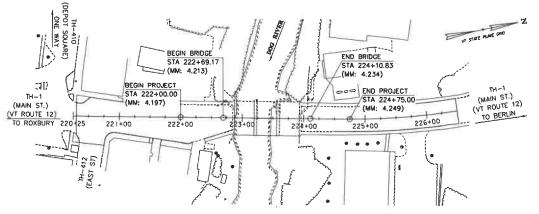

SCALE 1" = 80'-0"

CONSTRUCTION IS TO BE CARRIED ON IN ACCORDANCE WITH THESE PLANS AND THE STANDARD SPECIFICATIONS FOR CONSTRUCTION DATES 2024, AS APPROVED BY THE FEDERAL HIGHWAY ADMINISTRATION ON JUNE 27, 2023 FOR USE ON THIS PROJECT, INCLUDING ALL SUBSEQUENT REVISIONS AND SUCH REVISED SPECIFICATIONS AND SPECIAL PROVISIONS AS ARE INCORPORATED IN THESE PLANS.

1111H&H

HIGHWAY DIVISION, C	HIEF ENGINEER
APPROVED	DATE _
PROJECT MANAGER :	GARY LAROCHE, P.E.
PROJECT NAME :	NORTHFIELD
PROJECT NUMBER :	BF 0241(58)

YEAR

2024

2044

ADT

4300

4800

DHV

530

580

% O

52

52

% T

5.5

PRELIMINARY INFORMATION SHEET (BRIDGE)

AS BUILT "REBAR"

LEVEL LEVEL LEVEL

TYPE: TYPE: TYPE:

GRADE GRADE: GRADE

	2020 OF 23 15
LR	FD

INDEX OF SHEETS PLAN SHEETS STANDARDS LIST FORTLAND CEMENT CONCRETE SIDEWALK DRIVE ENTRANCES SIDEWALK PAMPS AND MEDIAN SLANDS (CHRBING PROLED EROSON CONTROL PRODUCT, TYPE I STABLEZE O CONSTRUCTION ENTRANCE NLET PROTECTION DEVICE, TYPE I SLITEROW. 1 TIDE SHEET 10-14-2005 2 PRELIMINARY INFORMATION SHEET 3 TYPICAL SECTIONS SHEET C-3B C-10 02-17-2022 4 EARTHWORK TYPICAL SECTION 6 GENERAL NOTES SHEET 8-8 QUANTITY SHEET 1-3 E-10 E-12 E-13 E-15 04-07-2020 9 EARTHWORK SHEET 10 CONVENTIONAL SYMBOLOGY LEGEND 11 SURVEYTIE SHEET 04-07-2020 E-121 E-131B G-1 G-1D STANDARD SIGN PLACEMENT - CONVENTIONAL ROAD 08-08-1995 07-25-2024 SICYCLE GUIDE SIGN DETAILS STEEL BEAM GLIARDRAIL DETAILS (POST, DELINEATOR, TYPICALS) 12 LAYOUT SHEET 03-10-2017 13 PROFILE AND BANKING DIAGRAM 14 SIDEWALK LAYOUT SHEET STEEL BEAM GUARDRAIL DETAILS (FUST, DELINEATOR, TYPICALS) STEEL BEAM GUARDRAIL DETAILS (END TERMINAL, ANCHOR, MEDU GENERIC GRADING PLANS FOR GUARDRAIL END TERMINALS BRIDGE JOINT ASPHALTIC PLUG 03-10-2017 G-10 G-19 S-400 S-500 S-501 S-601 T-1 T-2 T-10 15 TRUCK DETOUR ROUTE 04-07-2020 16 LOCAL DETOUR ROUTE 17 TRAFFIC CONTROL NOTES CONCRETE DETAILS AND NOTES 02-15-2023 CONCRETE DETAILS AND NOTES STRUCTURAL DETAILS AND NOTES 02-15-2023 18 LOCAL PEDESTRIAN DETOUR 19 - 27 LOCAL PEDESTRIAN DETOUR SHEET 1 - 9 28 ORAINAGE LAYOUT SHEET 02-15-2023 STRUCTURAL STEEL PLATE GIRDER DETAILS AND NOTES 02-15-2023 29 DRAINAGE PROFILE 04-07-2020 30 DRAINAGE DETAILS 31 DRAINAGE TABLES 32 UTILITY LAYOUT SHEET CONVENTIONAL ROADS CONSTRUCTION APPROACH SIGNING BRIDGE NUMBER PLAQUE 08-06-2012 33-35 UTILITYDUCT BANK PLAN AND PROFILE - 1 - 3 36 UTILITYDUCT BANK SECTIONS 37 - 38 LIGHTING PLAN SHEETS 1 - 2 39 SIGN AND LINE LAYOUT SHEET 40 CROSSWALK DETAILS 41 SIGN AND LINE TABLE SHEET 42 RAI LAGUESHEET 42 RAIL LAOUT SHEET 43 TEMPORARY PARKING LAYOUT 44 BORING LAYOUT SHEET 45 - 50 BORING LOG SHEET 1 - 6 51 BRIDGE DECK PLAN 52 BRIDGE DECK REINFORCING SECTION 53 BRIDGE DECK DETAILS 54 FRAMING PLAN 54 FRAMING PLAN 55 GRODER OETAILS 56 CAMBERT TABLE 57 APPROACH SUAB DETAILS SHEET 58 ABUTMENT 1 PLAN SHEET 59 ABUTMENT PILE DETAIL SHEET 60 VANGWALL PILE DETAIL SHEET 81 ABUTMENT CONNECTION DETAIL 82 ABUTMENT 1 REINFORCEMENT 83 WINGWALL 2 DETAILS 84 ABUTMENT 2 PLAN SHEET 84 ABUTMENT ZPILAN SHEET 85 ABUTMENT Z REINFORCEMENT 86 WINGWALL 3 DETALLS 67-79 SOLDER PILE WALL DETAILS 1-4 71 WINGWALLS I AND 4 72-44 BRIDGE RAIL NO DETAIL S SHEET 1-3 75 MOMENT SLAB DETAILS SHEET 1-3 76 REINFORCING STEEL SCHEDULE 77-83 ROADWAY CROSS SECTIONS SHEET 1 - 7 84 MATERIAL TRANSITION DIAGRAM 85-94 CHANNEL CROSS SECTIONS SHEET 1-10 95-96 EPSC NARRATIVE SHEET 1-2 97 EPSC EXISTING SITE PLAN 88 EPSC CONSTRUCTION SITE PLAN -101 EPSC DETAILS - 1 - 2 102 LANDSCAPE PLAN DETAIL SHEETS

TRAFFIC DATA

20 year ESAL for flexible pavement from

40 year ESAL for flexible payement from

Design Speed: 30 mph

2024 to 2044 : 571480

2024 to 2064 : 1361360

ADDT

280

470

HY	ROLOG	IC DATA	1	Date:	4/20/2022	2		PROPOSED STRUCTURE
DRANAGE AREA:	59.61	it mi.						STRUCTURE TYPE: Single Span
CHARACTER OF T	ERRAIN:	Hilly to r	nountainou	s rurad walk	ershed			
STREAM CHARACT	PERISTICS		with wide i	bodptein				CLEAR SPAN(NORMAL TO STREAM):
		Cobble						VERTICAL CLEARANCE ABOVE STREAMBED: WATERWAY OF FULL OPENING:
PEAK FLOW DATA		EXCEED						WATER SURFACE ELEVATIONS AT:
43% = 2,20 10% = 3,80		_	2% = 1% =		000 cfs 100 cfs		-	
4% = 5,00		_	0.2%=		300 cfs		-	43% AEP = 713.4 ft. VEL 10% AEP = 714.7 ft.
478- 3,00	J G15	_	0.270-	9	SUU CIS		-	4M AED - 715.78
DATE OF FLOOD O	F RECOR	0:8/28/20	11					4% AEP = 715.7 ft 2% AEP = 716.5 ft 1% AEP = 717.2 ft
ESTIMATED DISCH	ARGE:	Unknow						1% AEP = 717.2 ft
WATER SURFACE		721.7 ft.						
NATURAL STREAM	VELOCIT	r: 面 2% A	EF = 10.1	fpe*				IS THE ROADWAY OVERTOPPED BELOW 1% AI
ICE CONDITIONS:		Modera						FREQUENCY: N/A
OEBRIS:			te to Heavy					RELIEF ELEVATION: N/A
DOES THE STREAM				ER ELEV.	RAPIOLY?	Unkno	MD	DISCHARGE OVER ROAD @ 1% AEP: N/A
IS ORDINARY RISE IS STAGE AFFECTI		Unknow		MD = 4440	A + + + + + + + + + + + + + + + + + + +	00.1/		
IF YES, DESCRIBE:	Tho	JIREAM C	rolled by an	IKEAMC	UNLIHONS	S7 Yes		BRIDGE LOW CHORD ELEVATION: FREEBOARD: ## 2% AEP = 06
downstream of the	etreture.	ape is con	TOREU LY BI	Uncontrol	eo dam oil	ethy		FREEBOARD: ± 2% AEP = 06
OOM BOOM IN ON BE	BUULAHO.						_	SCOUR: 7.0 ft.**
WATERSHED STOR	MAGE.	1.0%	HEADL	MATERS:				SCOOK 7,01c
***************************************	0100,	1.0%	UNIFOR			X		REQUIRED CHANNEL PROTECTION: Stor
			IMMED	IATELYA	OVE SITE			THE STATE OF PRINCIPLE PROJECTION.
EX	TIMG C	TRUCTU	RE INFO					PERMIT INFORMATION
EAR					100			AVERAGE DAILY FLOW: -
STRUCTURE TYPE:	3-Snn	n Concrete	T-Beam B	ridge				ORDINARY LOWWATER: -
YEAR BUILT:	1926	Reconstruc	T-Beam B ited in 1958	3				ORDINARY HIGH WATER:
CLEAR SPAN(NOR	MAL TO ST	rream):	105,0 ft					
VERTICAL CLEARA	NCE ABO	VE STREA	MBED:	20).3 R.			TEMPORARY BRIDGE REQ
WATERWAYOFFU	LL OPENIN	iG:	1,681,2	sq. L				
DISPOSITION OF ST	RUCTURE	f:	FullRe	homen				STRUCTURE TYPE; N/A
TYPE OF MATERIAL	UNDERS	UBSTRUC	TURE;	Se	e Borlings			CLEAR SPAN (NORMAL TO STREAM): NA
WATER SURFACE								VERTICAL CLEARANCE ABOVE STREAMBED:
WATER SURFACE	ELEVAIIO	NS AT:						WATERWAY AREA OF FULL OPENING: N/A
43% AEP = 713.8	it.		VELOC	TY= 6.9	9 fps			ADDITIONAL INFORMATION
10% AEP = 715.1	ft.	-			d fps	_		The state of the s
4% AEP = 718.1	R.	_		9.4	4 fos	_		* Natural velocity is slightly larger because decelerati
2% AEP = 717.0	PL.	_		9.0	8 fps	_		** Assumes that existing abutments are fully exposed
1% AEP = 717.7	ft.	_			1.2 fps			***E-Stone Type IV is to be used for all in channel wo
								VICTORIA ILLA INCOMEN
LONG TERM STREA	IMBED CH	ANGES:	Unknow	n				1. MAINTAIN TRAFFIC ON AN OFF SITE DETOUR.
								2. TRAFFIC SIGNALS ARE NOT NECESSARY.
IS THE ROADWAY	MERTOP	ED BEIO	W 194 AEE	: No				2. TRAFFIC SIGNALS ARE NOT NECESSARY. 3. SIDEWALKS ARE NECESSARY
FREQUENCY:	NA		·· · · · · · · · · · · · · · · · · · ·	. 140				4. BICYCLES AND PEDESTRIANS WILL BE ACCO
RELIEF ELEVATION								I
DISCHARGE OVER		% AEP:	NA					DESIGNVA
								1. DESIGNUME LOAD
UPS	TREAM	STRUCT	URE					2. FUTURE PAVEMENT 3. DEUGN SPAN
TOWN: North				_1				3. DEBIGN SPAN
HIGHWAY#;		rdral Dal '	ad Roobury		STANCE: RUCTURE		0.0 g	4. MIN. MID-SPAN POS. CAMBER @ RELEASE (F
CLEAR SPAN;	Unknor		ac Nowity		EAR HEIG		RUDWII	5. PRESTRESUNG STRAND
YEAR BUILT:	Unknor				JLL WATER			6. PRESTRESSED CONCRETE STRENGTH
STRUCTURE TYP					ALCOHOL:	THAT, UI		7. PRESTRESSED CONCRETE RELEASE STREET
	-	-						8. S.P. (PERFORMANCE-BASED CONCRETE, CU
DOV	INSTRE	AM STRI	JCTURE					9. S.P. (PERFORMANCE-BASED CONCRETE, CL
			-					10. S.P. (PERFORMANCE-BASED CONCRETE, CL
TOWN: North					STANCE:		l ml,	11, CONCRETE, CLASS C
HIGHWAY#:	VT-12				RUCTURE	#: BF	181	12. REINFORCING STEEL
CLEAR SPAN:	170. ft.				EAR HEIS		known	13. STRUCTURAL STEEL AASHTO M270, GR50W
YEAR BUILT:	1977			FL	ILL WATER	RWAY: Un	known	44 400 004 054000 0500054405 5555
STRUCTURE TYP	E: 2 9pm	Continuou	n Rolled Ba	tam				14. NOMINAL BEARING RESISTANCE OF SOIL
			21					15. SOIL BEARING RESISTANCE FACTOR FEFER 18. NOMINAL BEARING RESISTANCE OF ROCK
LOADING LEVELS			RATING	TRUCK				17. ROCK BEARING RESISTANCE FACTOR (PEFE
	11-20	HL-93	302	# ADD.E	3A STE		EA SENI	18. PILE RESISTANCE FACTOR
TONNAGE	20	38	36	86	30	34,5	. 30	19. LATERAL PILE DEFLECTION
NVENTORY		1,14						20, BASIC WIND SPEED
POSTING				673.4	1777	527		21. MINIMUM GROUND SNOWLOAD 22. SEISMIC DATA PGA:
OPERATING		1.48	2.12	281	4.41	3.89	3.83	22. OCIOMIG DATA PGA:
COMMENTS:								123.
								24.
								24. 25.

FINAL HYDRAULIC REPORT

VELOCITY

@ 2% AEP = 06,57 ft.

TEMPORARY BRIDGE REQUIREMENTS

723,08 fL

DEPTH OR FLEVATION

PLOT DATE: 5/29/2025

OF 102

DRAWN BY: D. WELLS

CHECKED BY: K. SMITH

SHEET 2

Stone FIII Type IV***


***E-Stone Type IV is to be used for all in channel work		
TRAFFIC MAINTENANCE NOTES		
MAINTAIN TRAFFIC ON AN OFF SITE DETOUR.		
2. TRAFFIC SIGNALS ARE NOT NECESSARY.		
3. SIDEWALKS ARE NECESSARY		
4. BICYCLES AND PEDESTRIANS WILL BE ACCOMMODATED		
DESIGN VALUES		
1. DESIGN LIVE LOAD		HL-93
2. FUTURE PAVEMENT	dp:	2.5 INCH
3. DEUKSN SPAN	L:	140 FT
4. MIN. MID-SPAN POS. CAMBER @ RELEASE (PRESTRESSED UNITS)	_ <u>A</u> ; -	
5. PRESTRESUNG STRAND	fv:	
6. PRESTRESSED CONCRETE STRENGTH	f'c:	
7. PRESTRESSED CONCRETE RELEASE STRENGTH	f'el;	
8. S.P. (PERFORMANCE-BASED CONCRETE, CLASS PCD)	f'c:	4.0 KSI
9. S.P. (PERFORMANCE-BASED CONCRETE, CLASS PCS)	f'e:	3.5 KSI
S.P. (PERFORMANCE-BASED CONCRETE, CLASS PSS)	f'c:	4.0 KSI
1. CONCRETE, CLASS C	f'c:	3.0 KSI
2. REINFORCING STEEL	7.	60 KSI
3. STRUCTURAL STEEL AASHTO MZ70, GR50W	fy:	50 KSI
4. NOMINAL BEARING RESISTANCE OF SOIL	gn:	
5. SOIL BEARING RESISTANCE FACTOR (REFER TO AASHTO LRFD)	ф;	
B. NOMINAL BEARING RESISTANCE OF ROCK	W #12	
7. ROCK BEARING RESISTANCE FACTOR (HEFER TO AASHTO LRFD)	4:	
8. PILE RESISTANCE FACTOR	4:	0.65
9. LATERAL PILE DEFLECTION	Δ:	- * *
O, BASIC WIND SPEED	V3e;	***
1. MINIMUM GROUND SNOWLOAD	pg:	
2. SEISMIC DATA PGA:	Sa:	
3,	81:	***
4.		
5.		
6.		
PROJECT NAME: NORTHFIELD		


FILE NAME: zi9j223forms.dgm

PRELIMINARY INFORMATION SHEET


PROJECT LEADER: K. SMITH

DESIGNED BY: O. WELLS

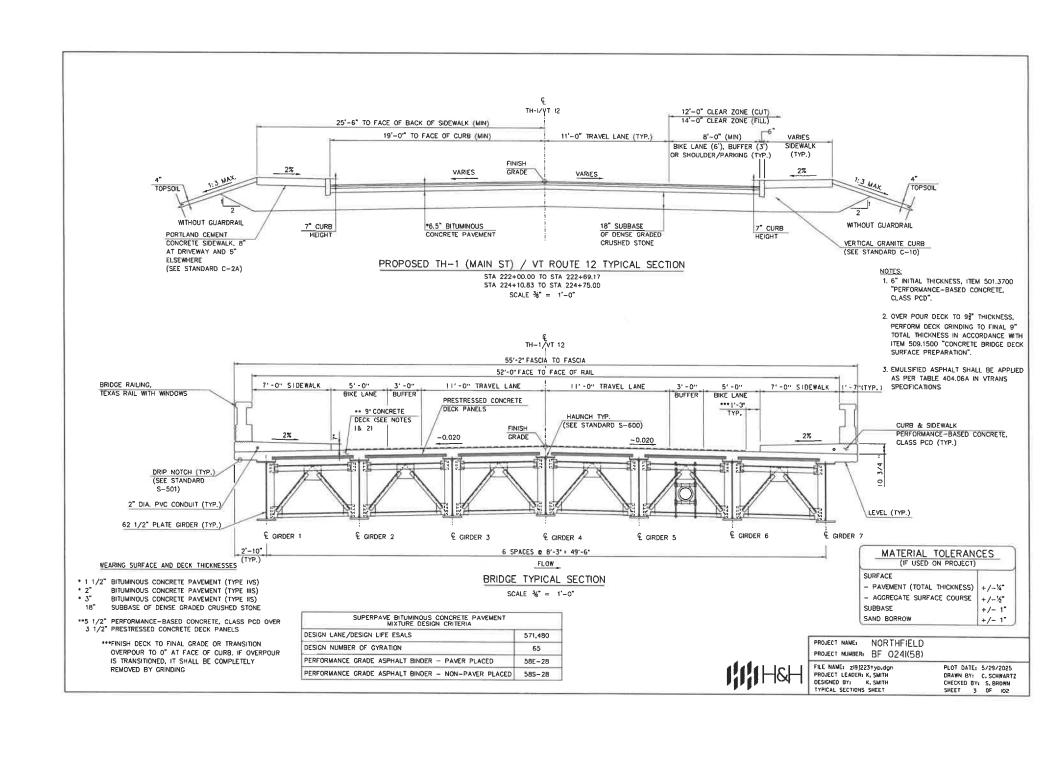

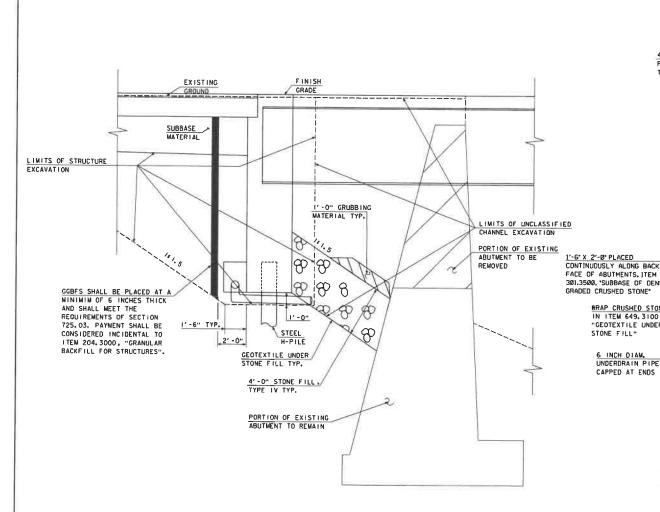


ABUTMENT EARTHWORK TYPICAL SECTION (NOT TO SCALE)

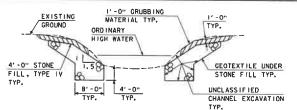

TYPICAL CHANNEL SECTION (NOT TO SCALE)

- I) GRUBBING MATERIAL SHALL BE PLACED UNDERNEATH STRUCTURES WHERE THERE IS MORE THAN 6 FEET VERTICALLY FROM ORDINARY HIGH WATER (OHW) TO THE BOTTOM OF SUPERSTRUCTURE AND MORE THAN 6 FEET HORIZONTALLY FROM OHW LINE TO FRONT FACE OF ABUTMENT. THIS MATERIAL SHALL START JUST ABOVE THE OHW ELEVATION AND TERMINATE 3 FEET HORIZONTALLY FROM THE FRONT FACE OF THE ABUTMENT. THIS MATERIAL SHALL NOT BE PLACED UNDERNEATH DOWNSPOUTS, SEE THE CHANNEL SECTIONS FOR ADDITIONAL DETAILING.
- 2) WHENEVER CHANNEL SLOPE INTERSECTS ROADWAY SUBBASE, GRUBBING MATERIAL SHALL BEGIN AT THE BOTTOM OF SUBBASE.

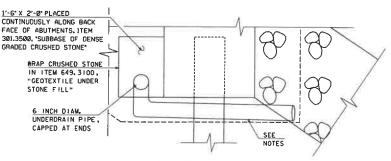

SUBSTRUCTURE DRAINAGE DETAIL (NOT TO SCALE)

- 3) 6" UNDERDRAIN OUTLET PIPE CONNECTED TO UNDERDRAIN AT BACK FACE OF ABUTMENTS. OUTLET PIPE TO BE WRAPPED IN ITEM 649.3100, "GEOTEXTILE UNDER STONE FILL" AND PLACED TO AVOID PILES AND CUSHION SAND.
- 4) SLOPE UNDERDRAIN PIPE AT A MINIMUM OF 1/8" PER FOOT.
- 5) UNDERDRAIN OUTLET PIPE TO TERMINATE A MINIMUM OF 6" BEYOND GRANULAR BACKFILL FOR STRUCTURES. ENDS OF UNDERDRAIN OUTLET PIPE WILL BE PROTECTED FROM DAMAGE DURING PLACEMENT OF STONE FILL TYPE IV. ANY DAMAGED SECTIONS OF PIPE SHALL BE REPLACED TO THE SATISFACTION OF THE ENGINEER AND AT THE CONTRACTORS EXPENSE.
- 6) PAYMENT FOR ALL UNDERDRAIN PIPES SHALL BE UNDER ITEM 605. 1006, "UNDERDRAIN PIPE, 6 INCH".



STONE FILL"

6 INCH DIAM.

PROJECT NAME: NORTHFIELD PROJECT NUMBER: BF 0241(58)

FILE NAME: zi91223ets.dan PROJECT LEADER: K. SMITH DESIGNED BY: K. HO EARTHWORK TYPICAL SECTION PLOT DATE: 5/29/2025 DRAWN BY: T. MARQUETTE CHECKED BY. C. JENNE

GENERAL

- ALL MATERIALS AND CONSTRUCTION SHALL CONFORM TO THE STATE OF VERMONT ACENCY OF TRANSPORTATION STANDARD SPECIFICATIONS FOR CONSTRUCTION 2024, AND ITS LATEST REVISIONS, AND THE AASHTO LRFD BRIDGE DESIGN SPECIFICATIONS, DATED 2020.
- ALL DIMENSIONS SHOWN IN THE PLANS ARE HORIZONTAL OR YERTICAL AND ARE GIVEN AT 68 DEGREES FAHRENHEIT, UNLESS NOTED OTHERWISE.
- THE REMOVAL OF EXISTING STRUCTURE WILL BE PAID FOR UNDER ITEM 529,2000, "PARTIAL REMOVAL OF STRUCTURE." THIS WORK SHALL INCLUDE BUT NOT BE LIMITED TO THE REMOVAL OF
 - A. APPROACH SLABS
 - B. APPROACH RAILING AND BRIDGE RAILING
 - C. SIDEWALKS
 - D. DECK AND SUPERSTRUCTURE
 - E. PORTIONS OF EXISTING ABUTMENTS AND
 - WINGWALLS AS SHOWN IN THE PLANS
 - F. PORTIONS OF THE EXISTING WINGWALLS AND
 - RETAINING WALLS WITHIN THE LIMITS OF THE PROPOSED SUBSTRUCTURE G. PIERS AND PIER FOOTINGS
- 4. THE CONTRACTOR SHALL PROTECT ALL EXISTING UTILITIES FROM DAMAGE DURING ALL STAGES OF CONSTRUCTION. COSTS FOR UTILITY PROTECTION SHALL BE CONSIDERED INCIDENTAL TO ALL PROJECT ITEMS, ANY DAMAGE TO UTILITIES SHALL BE REPAIRED TO THE SATISFACTION OF THE ENGINEER AND AT THE CONTRACTOR'S EXPENSE.
- 5. THE EXISTING SIGN AT THE SOUTHEAST CORNER OF THE NJF WESCO REALTY, LLC, PROPERTY SHALL BE REMOVED AND RESET, THE PROPOSED LOCATION OF THE SIGN SHALL BE APPROVED BY THE ENGINEER, A TEMPORARY STANDALONE SIGN TO ADVERTISE FUEL PRICES SHALL BE INSTALLED FOR THE DURATION THAT A PERMANENT SIGN IS NOT IN PLACE. THE TEMPORARY SIGN SHALL BE APPROVED BY THE ENDINEER PRIOR TO INSTALLATION, PAYMENT FOR THE TEMPORARY AND PERMANT SIGNS SHALL BE INCLUDED LANDER ITEM 65.5600002. "MEMOVE AND RESET PRIVATE SIGN SSHALL BE INCLUDED."

TRAFFIC CONTROL

TRAFFIC MANAGEMENT WILL BE ACCOMPLISHED USING AN OFF-SITE LOCAL DETOUR ON WATER STREET AND WALL STREET, AND A TRICK DETOUR ON Y1-64/1-89/US-2 DURING A 12 WEEK BRIDGE CLOSURE PERIOD, A BIOYCLE/PESTRAN DETOUR VIA LOCAL ROADS WILL BE SIGNED AS SHOWN, REFER TO 'TRAFFIC CONTROL, PLAN' SHEET FOR ADDITIONAL INFORMATION PERTAINING TO TRAFFIC CONTROL.

- THE SIDEWALK AND CURB ADJACENT TO THE WESCO FUEL PUMP ISLAND WILL BE REMOVED TO MAINTAIN ACCESS TO THE FUEL PUMPS DURING THE BRIDGE CLOSURE PERIOD.
- 8. THE COST TO MAINTAIN ACCESS TO EACH PROPERTY WILL BE INCLUDED IN THE PAYMENT OF ITEM 64LIDD, "TRAFFIC CONTROL, ALL-INCLUSIVE."

EPSC

 FOR THE WET CROSSING, ALL CONSTRUCTION EQUIPMENT SHALL BE CLEAN AND WELL MAINTAINED, FREE OF FUEL, HYDRAULIC AND GEAR OIL LEAKS,

EARTHWORK AND RELATED ITEMS

IO. THE "STONE FILL TYPE IV" UNDER THE BRIDGE AS SHOWN IN THE PLANS SHALL BE PLACED BEFORE THE NEW STEEL GIRDERS ARE SET.

STRUCTURAL STEEL

- II. ALL FIELD CONNECTIONS SHALL BE MADE USING % DIAMETER BOLTS IN % "
 DIAMETER HOLES, PER SECTION 506,IB, UNLESS OTHERWISE SPECIFIED.
- 12. ALL WELDING SHALL CONFORM TO THE PROVISIONS OF SUBSECTION 506.10.
- 13. ANY CONNECTIONS THAT ARE NOT DETAILED ON THE PLANS SHALL BE DETAILED BY THE FABRICATOR AND SUBMITTED TO THE STRUCTURE ENGINEER FOR APPROVAL.
- 14. STRUCTURAL STEEL MEMBERS DESIGNATED "CVM" IN THE PLANS SHALL BE CHARPY V-NOTCH TESTED IN ACCORDANCE WITH SUBSECTION TI4,01 OF THE STANDARD SPECIFICATIONS.
- 15. END OF GIRDERS ARE TO BE VERTICAL IN THEIR FINAL POSITION.
- 16. AFTER SUPERSTRUCTURE STEEL HAS BEEN ERECTED, ELEVATIONS ALONG THE TOP OF THE CIRDERS SHALL BE TAKEN AS DIRECTED BY THE RESIDENT ENGINEER, FOR USE IN DETERMINING THE HEIGHT OF DECK PANEL BEDDING STRIPS. AFTER THE DECK PANELS HAVE BEEN SET AND BEFORE THE HAUNCH POUR SPLACED, THE CONTRACTOR SHALL RE-PROFILE THE TOP FLANGES OF THE GRIDER AS DIRECTED BY THE RESIDENT ENGINEER, FOR USE IN DETERNINING SCREED RAIL ELEVATIONS AND CHAIR HEIGHTS FOR REPROFICING STEEL.

17. FLEMING BRACKETS OR SIMILAR FALSE WORK SHALL BE SPACED AS REQUIRED BY DESIGN BUT SHALL BE LIMITED TO A MAXIMUM SPACING OF 4 FEET, THE DESIGN OF FALSE WORK SHALL BE THE RESPONSIBILITY OF THE CONTRACTOR AND SHALL EXTEND AT LEAST 15% OF THE DEPTH OF THE WEB.

PAVEMENT

18. AT BEGIN AND END BRIDGE, PRIDR TO GRINDING, THE 9½ DECK WILL BE ¾ HIGHER THAN THE WEARING COURSE, INSTALL A TEMPORARY TAPER OR MEDGE OF BITUMHOUS CONCRETE PAVEMENT AT A MINIMUM SLOPE OF 1/30 PRIOR TO ALLOWING TRAFFIC ON THE BRIDGE, TAPER AND/OR WEDGE SHALL BE REMOVED WHEN DECK GRINDING OCCURS.

CONCRETE

- 19. THE APPROACH SLABS AND PORTIONS OF THE ABUTMENT BELOW THE BRIDGE SEAT ELEVATION SHALL BE PERFORMANCE-BASED CONCRETE, CLASS PCS AND SHALL BE PAID LINDER TIEM 503.3800, PERFORMANCE-BASED CONCRETE, CLASS PCS, DECK CONCRETE (NCLUDING THE ABUTMENT CONCRETE ABOVE BRIDGE SEAT OR CAP ELEVATION, THE SIDEWALKS, AND MOMENT SLABS SHALL BE PERFORMANCE-BASED CONCRETE, CLASS PCD AND SHALL BE PAID UNDER ITEM 503.7500, PERFORMANCE-BASED CONTRETE, CLASS PCD.
- 20. THE DECK SHALL BE CAST TO AN INITIAL THICKNESS OF 9%, AFTER THE DECK HAS CURED AND BRIDGE RAIL AND SUBGALK ARE INSTALLED THE ENTIRE BROCE DECK SURFACE AND PORTIONS OF THE BRIDGE APPROACHES SHALL BE GROUND FOR A RESULTING DECK THICKNESS OF 9 INCHES, PAYMENT WILL BE MADE LINDER TIEM SO PSOO, "CONCRETE BRIDGE DECK SURFACE PREPARATION."
- 21. THE DECK SHALL BE POURED IN ONE CONTINUOUS POUR WITH A MAXIMUM OURATION OF EIGHT HOURS, EXCEPT FOR THE CLOSURE POUR SECTIONS AT THE ABUTMENTS WHICH SHALL BE PLACED AT LEAST 12 HOURS AFTER THE DECK POUR HAS BEEN COMPLETED, F CIRCUMSTANCES BEYOND THE CONTRACTOR'S CONTROL PREVENT THE PLACEMENT IN ONE POUR, A TRANSVERSE CONSTRUCTION JOINT SHALL BE USED BETWEEN ADJACENT POURS, THE MINIMUM TIME DELAY BETWEEN ADJACENT PLACEMENT WIS DECKLED IN THE CONTRACTOR'S PLACEMENT MOD DECKLESCO DURNG THE PRE-PLACEMENT MEETING.
- WATER REPELLENT, SILANE, SHALL BE APPLIED TO ALL EXPOSED CONCRETE SURFACES, EXCEPT THE UNDERSIDES OF THE DECK BETWEEN DRIP NOTCHES.
- JOINTS AND SCORE MARKS IN CONCRETE SHALL BE CONSTRUCTED AS SHOWN IN THE PLANS OR AS DIRECTED BY THE RESIDENT ENGINEER.
- 24. ALL EXPOSED EDGES OF CONCRETE SHALL BE CHAMFERED I'X I'.

REINFORCING STEEL

- 25. ALL REMFORCING STEEL IN THE APPROACH SLABS SHALL WEET THE REQUIREMENT FOR LEVEL IEFOXY COATED, ITEM 507,100, "REMFORCING STEEL, LEVEL IEFDXY COATED," ALL OTHER REMFORCING SHALL BE LEVEL II, IN ACCORDANCE WITH SECTION 507 OF THE STANDARD SPECIFICATIONS AND PAID FOR UNDER ITEM 507,200, "REMFORCING STEEL, LEVEL II."
- 26. CUTTING AND REPAIRING DAMAGED AREAS OF COATED REINFORCING STEEL SHALL BE PERFORMED IN ACCORDANCE WITH SUBSECTION 507.04 OF THE STANDARD SPECIFICATIONS.

INTEGRAL ABUTMENT PILES

- 27. FOR ESTIMATING PURPOSES, THE PILE TIP ELEVATIONS WERE ASSUMED AS SHOWN ON THE BORNIG LOGS AND THE PROPOSED PILE SUMMARY TABLE. THE ACTUAL IN PLACE LENGTHS MAY VARY
- 28. PROPOSED PILES SHALL BE IN ACCORDANCE WITH SUBSECTION 730.01 OF THE STANDARD SPECIFICATIONS.
- 29. PLES SHALL BE PRE-DRILED PER THE REQUIREMENTS OF ITEM 546,000. "PRE-EXCAVATION OF ABUTMENT PILES, ROCK-TO THE DEPTHS SHOWN ON THE PLANS. THE MINOMED MANETER OF THE EXCAVATED HOLES FOR EACH PILE SHALL BE PER THE ABUTMENT PILE SUMMARY TABLE.
- 30. THE INTERIOR OF THE PRE-BORED HOLES SHOULD BE THOROUGHLY CLEANED OF SOIL AND DEBRIS PRIOR TO THE LOWERING OF THE PILE. A WEIGHTED TAPE SHOULD BE USED TO INSPECT THE BOTTOM OF THE HOLE FOR CLEANLINESS.
- 3). FOLLOWING THE PLACEMENT OF THE PHLE, FILL THE ANNULUS BETWEEN THE PHLE AND THE ROCK SOCKET WITH SELF-CONSOLIDATING CONCRETE (SCC) BY GRAVITY FROM THE LOWEST POINT OF THE SOCKET USING THE TREME METHOD, SCC PLACEMENT SHALL CONTINUE UNTIL UNCONTAMINATED CONCRETE SUPPASSES THE LIMITS OF THE ROCK SOCKET, BUT DOES NOT EXTEND PAST THE LIMITS OF SCC SHOWN ON THE ABUTMENT PHLE DETAIL SHEET. THE TEMPORARY CASING SHOULD BE EXTRACTED WHILE PLACING THE SCC SUCH THAT THE BOTTOM OF THE TEMPORARY CASING IS AT THE TOP OF THE CONCRETED SOCKET,

INTEGRAL ABUTMENT PILES (CONTINUED)

- 32. AFTER THE SCC HAS CURED, BACKFILL THE REMAINDER OF THE ANNULUS WITH CUSHION SAND AT ABUTMENT PILE LOCATIONS WHILE SMULTAMEOUSLY REMOVING THE TEMPORARY CASING, CUSHION SAND SHALL MEET THE REQUIREMENTS OF SECTION 703.03 OF THE STANDARD SPECIFICATIONS.
- CONCRETE SHALL ACHIEVE A MINIMUM 20-DAY COMPRESSIVE STRENGTH OF 5000 PSI AND MEET THE MATERIAL REQUIREMENTS OF STANDARD SPECIFICATIONS SECTION 707.0(IE).
- 34. ALLOW CONCRETED SOCKETS TO CURE FOR A MINIMUM OF 24 HOURS PRIOR TO PRE-EXCAVATING WITHIN 3 SOCKET DIAMETERS OR BACKFILLING THE REST OF THE PILE SOCKET.
- 35. TOLERANCES FOR THE TOPS OF THE PILES AFTER BATTER AND ROTATION SHALL MEET THE REQUIREMENTS OF SECTION 505.04(B). PILE PLACEMENT SHALL NOT VARY FROM THE POSITION SHOWN ON THE PLANS BY MORE THAN 3 INCHES
- 36. THE COMPRESSION RESISTANCE FACTOR FOR THE PROPOSED ROCK SOCKETS IS 0.50 FOR THE STRENGTH LIMIT STATE LOAD COMBINATION.

SOLDIER PILE RETAINING WALLS

- WINGWALLS 2 & 3 SHALL BE SOLDIER PILE WALLS, PAYMENT FOR THESE WINGWALLS SHALL BE UNDER ITEM 225.0300001, "SOLDIER PILE RETAINING WALLS".
- 38. CONTRACTOR SHALL SUBMIT THE ARCHITECTURAL CONCRETE FACING PATTERN TO THE ENGINEER FOR APPROVAL PRIOR TO CONSTRUCTING.

WINGWALL PILES

- 39. FOR ESTIMATING PURPOSES, THE PILE TIP ELEVATIONS WERE ASSUMED AS SHOWN ON THE BORRING LOGS AND THE PROPOSED PILE SUMMARY TABLE, THE ACTUAL IN PLACE LENGTHS MAY VARY.
- PROPOSED PILES SHALL BE IN ACCORDANCE WITH SUBSECTION 730.01 OF THE STANDARD SPECIFICATIONS.
- 41. PILES SHALL BE PRE-DRILED PER THE REQUIREMENTS OF ITEM \$46,000, "PRE-EXCAVATION OF ABUTWENT PILES, BEATH," AND ITEM \$46,2000, PRE-EXCAVATION OF ABUTWENT PILES, ROCK"TO THE DEPTHS SHOWN ON THE PLANS, THE MINIMUM DIAMETER OF THE EXCAVATED HOLES FOR EACH PILE SHALL BE PER THE WINOWALL PILE SUMMARY TABLE.
- 42. THE INTERIOR OF THE PRE-BORED HOLES SHOULD BE THORDUGHLY CLEANED OF SOIL AND DEBRIS PRIOR TO THE LOWERING OF THE PILE. A WEIGHTED TAPE SHOULD BE USED TO INSPECT THE BOTTOM OF THE HOLE FOR CLEANINESS.
- 43. FOLLOWING THE PLACEMENT OF THE PILE, FILL THE ANNALUS BETWEEN THE PILE AND THE ROCK SOCKET WITH SELF-CONSOLIDATING CONCRETE ISCO BY ORAVITY FROM THE LOWEST POINT OF THE SOCKET UISING THE TREME METHOD. THE SCC PLACEMENT SHALL CONTINUE UNTIL THE BOTTOM OF THE CONCRETE WALL PANELS AS SHOWN ON THE WINDWALL PILE DETAIL SHEET, THE TEMPORARY CASING SHOULD BE EXTRACTED WHILE PLACING THE SCC SUCH THAT THE BOTTOM OF THE TEMPORARY CASING SHOULD
- 44. AFTER THE SCC HAS CURED BACKFILL THE REMAINDER OF THE ANNULUS WITH CONTROLLED LOW STRENGTH MATERIAL (CLSM) AT PILE LOCATIONS WHILE SIMULTANEOUSLY REMOVING THE TEMPORARY CASING, CUSMION SAND SHALL MEET THE REQUIREMENTS OF SECTION 703.03 OF THE STANDARD SPECIFICATIONS.
- CONCRETE SHALL ACHIEVE A MINIMUM 28-DAY COMPRESSIVE STRENGTH OF 5000 PSIAND MEET THE MATERIAL REQUIREMENTS OF STANDARD SPECIFICATIONS SECTION 707.0I(E),
- 46. ALLOW CONCRETED SOCKETS TO CURE FOR A MINIMUM OF 24 HOURS PRIOR TO PRE-EXCAVATING WITHIN 3 SOCKET DIAMETERS OR BACKFILLING THE REST OF THE PILE SOCKET.
- 47. TOLERANCES FOR THE TOPS OF THE PILES AFTER BATTER AND ROTATION SHALL MEET THE REQUIREMENTS OF SECTION SOS.048B, TOLERANCES FOR THE PLACEMENT OF THE WINCHALL PILES SHALL ALSO MEET THE REQUIREMENTS OF SECTION 505.048B,
- 48. THE COMPRESSION RESISTANCE FACTOR FOR THE PROPOSED ROCK SOCKETS IS 0.50 FOR THE STRENGTH LIMIT STATE LOAD COMBINATION.



PROJECT NAME: NORTHFIELD PROJECT NUMBER: BF 0241(58)

FILE NAME: zigj223notes.dgn PROJECT LEADER: K.SMITH DESIGNED BY: S.BROWN GENERAL NOTES SHEET PLOT DATE: 5/29/2025
DRAWN BY: C. JAMISON
CHECKED BY: K. SMITH
SHEET 5 OF 102

QUANTITY SHEET 1

	SUM	MARY OF E	STIMATED QU	ANTITIES				тот	ALS	1	DESCRIPTIONS					DETAILED SUMMARY OF QUANTITIES
			1011 - ROADWAY	1031 - TRANING	EROSION CONTROL	1211 - BRIDGE NO. 1	1990 - FULL C.E. ITEMS	GRAND TOTAL	FINAL	TINU	liews	ITEM NUMBER	ROUND	QUANTIT	ES UNIT	TEMS
						80000		80000		DL	NCENTIVE OR DISINCENTIVE (N.A.B.I.)	199,8101				
			1					1	_	LS	CLEARING AND GRUBBING INCLUDING INDIVIDUAL TREES AND STUMPS					
	-	+	1200					1200		CY	COMMONEXCAVATION					
				,								203.1500				
	_		15					5		i .	SOUID ROCK EXCAVATION	203,1600			-	
	1						-	15			UNCLASSIFIED EXCAVATION	203,1700			+-	
			1950				-	1950		CY	UNCLASSIFIED CHANNEL EXCAVATION	203.2700				
			000					900		CY	TRENCH EXCAVATION OF EARTH	204,2000				
		-	1					1		CY	TRENCH EXCAVATION OF ROCK	204.2100				
			1					1 -		CY	TRENCH EXCAVATION OF EARTH, EXPLORATORY (N.A.B.L)	204.2200				
						748		748		CY	STRUCTURE EXCAVATION	204,2500			-	
						698		696		CY	GRANULAR BACKFILL FOR STRUCTURES	204.3000			1	
			230					230		SY	COARSE-MILLING, BITUMNOUS PAVEMENT					
												210.1000			-	
6.0				1						LS	RETAINING WALL, CAST-IN-PLACE CONCRETE (WINGWALL 2)	225.0300			-	
					-	1_1_		11		ts	RETAINING WALL CAST-N-PLACE CONCRETE (WINSWALL 3)	225.0300				
	-	-	_			1		1		LS	RETAINING WALL CONCRETE (WINGWALL 1)	225.0500				
	-					1		1		LS	RETAINING WALL CONCRETE (WHIGHWALL 4)	225,0500				
			500000					500000		OL.	DISPOSAL OF CONTAMINATED MATERIALS (N.A.B.L)	230.0010			-	
			1					1		LS	PROJECT OPERATIONS PLAN	: 230.0030			-	
			1		+	-		1		LS	PROJECT OPERATIONS COMPLETION REPORT	230,0040				
 	-		480			+		480		HR	CORRODON (CATAL OVERSOLIT					
			1							LS						
			848					1			MANAGEMENT OF CONTAMINATED GROUNDWATER	230,0060			+	
								848		CY	SUBBASE OF DENSE GRADED CRUSHED STONE	301,3500				
			100					100		CWT	TACK COAT, EMULSIFIED ASPHALT	404,1100			-	
			155				1	155		TON	BITUMINOUS CONCRETE PAVEMENT, TYPE IS, QA TIER III	406.0230				
	_		138	_			1	138		TON	BITUMINOUS CONCRETE PAVEMENT, TYPE IIS, QA TIER III	1 406,0330				
		-	220				1	220		TON	BITUMINOUS CONCRETE PAVEMENT, TYPE IVS, QA TER II	1 406,0430				
			310					310		SY	BITUMINOUS CONCRETE PAVEMENT, NON-PAVER PLACED, TYPE IVS	406,3400				
 			1					1 1		DL .	PAY ADJUSTMENT, BCP, MOTURE PROPERTIES (N.A.B.L)	400.9100				
				1		355		355		CY	PERFORMANCE BASED CONCRETE, CLASS PCD	501,3700				
						145	-	145		CY	PERFORMANCE-BASED CONCRETE, CLASS PCS	501,3800				
	+	-				1		1		LS	FURNISHING EQUIPMENT FOR DRIVING PLING					
					1							504.1000				
						384		384		LF	STEEL PILING, HP 12 × 84	505.1650	-			
						2	_	2		EACH	DYNAMIC PILE LOADING TEST	505,4500				
	-					327200		327200		LB	STRUCTURAL STEEL, PLATE GROER	508.5500				
						7800		7800		LB	REINFORCING STEEL, LEVEL I	507,1100				
						101100		101100		LB	REINFORCING STEEL, LEVEL II	507,1200		-	-	
						1		1		L\$	SHEAR CONNECTORS (1974 - 7/8 X 7IIV)	508.1500				
	-					5384	1	5384		8F	CONCRETE BRIDGE DECK SURFACE PREPARATION	509.1500				
		-				5688		5568		SF						
	-					50		50			PRESIDENCE CONCRETE DECK PANELS	510.4000				
						50		50		GAL	WATER REPELLENT, SILANE	514.1000				



PROJECT NAME: NORTHFIELD
PROJECT NUMBER: BF 0241(58)

FILE NAME: 219]223quontities.dgn PROJECT LEADER: K. SMITH DESIGNED BY: QUANTITIES SHEET I

PLOT DATE: 5/29/2025 DRAWN BY: C. JAMISON CHECKED BY: K. SMITH SHEET 6 OF 102

QUANTITY SHEET 2

		SUMM	ARY OF EST	MATED QUA	ANTITIES				тоти	ALS		DESCRIPTIONS	
				1011 - ROADWAY	1031 - TRANING	1055 - EROSION CONTRIOL	1211 - BRIDGE NO, 1	1999 - FULL C.E. ITEMS	GRAND TOTAL	FINAL	UNIT	ITEMS	ITEM NUMBER RO
							76		76		LF	BRDGE EXPANSION JOINT, ASPHALTIC PLUG	516.1000
							78	1	76		LF	JONT SEALER, HOT POURED	524,1100
							329		329		LF	BRDGE RAILING, TEXAS RAIL WITH WINDOWS	525.5200
							1		1 1		EACH	PARTIAL REMOVAL OF STRUCTURE	529,2000
				1					11_		CY	FLOWABLE FILL, EXCAVATABLE	541,4800
							224		224		ĻF	PRE-EXCAVATION OF ABUTIMENT PILES, EARTH	548,1000
							_08		98		LF	PRE-EXCAVATION OF ABUTIMENT PILES, ROCK	546.2000
				110					110		LF	24 NCH CPEP	601,0920
				70	-			ļ	70		LF	30 NCH CPEP(SL)	601.2825
				63					63		LF	38 NCH CPEP(SL)	1 801,2630
			_	- 1					1		EACH	30 NCHCPEPES	601.7025
16				1					1			38 NCH CPEPES	801.7030
				.2		9			2		EACH	PRECAST REINFORCED CONCRETE DI WITH CAST IRON GRATE	604,1800
				2					2		1	CHANGING ELEVATION OF DIS, CATCH BASINS, OR MANHOLES	604.4000
				3		J		1	3		EACH	CAST IRON GRATE WITH FRAME, TYPE D	604,4504
				158					158		LF	UNDERDRAIN PIPE, 6 INCH	1
				180				1					805,1008
					-				180		CY	ESTONE FILL TYPE I	813.0601
				900			910		1810		CY	STONE FILL TYPE IV	613,1004
						1			1 .		LS	N-WATER SEDIMENT ISOLATION MEASURES	614.2000
				280					280		LF	VERTICAL GRANITE CURB	816.2100
	+			33			-	-	33		LF	REMOVING AND RESETTING CURB	616,4000
				37					37		LF	REMOVAL OF EXISTING CURB	, 616.4100
_	-			170					170		SY	PORTLAND CEMENT CONCRETE SIDEWALK, 5 INCH	818,1005
				81	_				81		SY	PORTLAND CEMENT CONCRETE SIDEWALK, 8 INCH	818,1008
				25					25		SF	DETECTABLE WARNING SURFACE	618,3000
				20					20		UE	CHAIN-LINK FENCE, 8 FOOT	820,1008
				20			*** # *** ##****		20		LF	REMOVAL OF EXISTING FENCE	620.5500
				100					100		uf	REMOVAL OF GUARDRAIL	621,0100
		1				11					LS_	WATER MAIN ON BRIDGE, ALL INCLUSIVE	629.1700002
								1 1	1		LS	FIELD OFFICE, ENGINEER'S	#31.1000
								1	11		LS	TESTING EQUIPMENT, CONCRETE	631,1600
								1	1		LS	TESTING EQUIPMENT, BITUMINOUS	631.1700
								5000	3000		DL	FIELD OFFICE COMMUNICATIONS (N.A.B.I.)	631.2600
				14					14		EACH	CPM SCHEDULE	633,1000
	-				520				520		HR	EMPLOYEE TRAINEESHIP	634,1000
				1				-	1		LS	MOBILIZATION/DEMOBILIZATION	635,1100
				1	_				1		LS	TRAFFIC CONTROL, ALL-INCLUSIVE	641.1100
		-							1		LS		
				1650								MAINTENANCE OF PEDESTRIAN TRAFFIC	641,1200
									1850		LF.	DURABLE 4 INCH WHITE LINE EPOXY PAINT	648,4030
				1120					1120	_	LF	DURABLE 4 INCH YELLOW LINE, EPOXY PAINT	848,4130

PROJECT NAME: NORTHFIELD PROJECT NUMBER: BF 024I(58)		FILE NAME: 2191223quontities.dgn PLOT DATE: 5/29/202 PROJECT LEADER: K. SMITH DRAWN BY: C. JANISO
	-	
	_	
	_	
	_	
	-	
THE PERSON NAMED IN COLUMN TWO IS NOT THE PERSON NAMED IN COLUMN TO PERSON NAMED IN COLUMN TWO IS NOT THE PERSON NAMED IN COLUMN TWO IS NAMED IN THE PERSON NAMED IN THE PER		

DETAILED SUMMARY OF QUANTITIES



DESIGNED BY

CHECKED BY: K, SMITH SHEET 7 OF 102

QUANTITY SHEET 3

SUMA	MARY OF EST	TIMATED QUA	ANTITIES				тот	ALS		DESCRIPTIONS		
		1011 - ROADWAY	1031 - TRAINING	EROSION CONTROL	1211 - BRIDGE NO. 1	1999 - FULL C.E. ITEMS	GRAND TOTAL	FINAL	UNIT	пемѕ	ITEM NUMBER	ROUNE
		1280					1280		LF	DURABLE 6 INCH WHITE LINE, EPOXY PAINT	646,4230	
		12					12		EACH	DURABLE LETTER OR SYMBOL, EPOXY PAINT	646,4930	-
		80					80		LF	DURABLE CROSSWALK MARKING, THERMOPLASTIC	648.5020	
 ATTEMPT OF					685		. 685	******	SY	GEOTEXTILE UNDER STONE FILL	649,3100	
 				1780			1780		·· sy	TURF ESTABLISHMENT, GENERAL SEED	651.1500	Ī
				198			198		CY	TOPSOIL	651,3500	
				510			510		SY	GRUBBING MATERIAL	651,4000	
				1			1		LS	EPSC PLAN	853.0100	
				80			80		HR	MONITORING EPSC PLAN	653.0200	
				3000			3000		OL.	MAINTENANCE OF EPSC PLAN (NA.B.L)	853,0300	
				1			1		TON	HAYMULCH		
			1	282			282		SY		853,1000	
				120		1	120		ĊY	STABILIZED CONSTRUCTION ENTRANCE	653,2001	
 				10			10				653,3500	
				3						NLET PROTECTION DEVICE, TYPE I	653,4002	
				1 260			3			FILTER BAG	853,4500	
							260		LF.	SILT FENCE, TYPE I	853,4702	
	-			600			600		LF	BARRIER FENCE	653.5000	_
							1		LS	TREE PROTECTION	658.8500	
 		45					45		ŞF	TRAFFIC SIGN, FLAT SHEET ALUMINUM	875.2000	
		. 87		ļ			. 87		LF	SQUARE TUBE SIGN POST AND ANCHOR	675.3410	
		2		-1			2		EACH	FOUNDATION FOR TUBULAR STEEL POST	675.4300	
		3					3		EACH	SIGN REMOVAL, FLAT SHEET ALUMINUM	675.5000	
		4		1			4		EACH	RESETTING SIGNS	875,6000	
		.1					1		EACH	REMOVE AND RESET PRIVATE SIGN ASSEMBLY, LIGHTED	1 675,6000002	2
		- 1					4		EACH	DELINEATOR WITH STEEL POST	876.1000	
		1		-			1		EACH	REMOVE AND RESET LIGHT POLE	879,2500	
		. 1		1			1		DL	PRICE ADJUSTMENT, ASPHALT (N.A.B.I.)	690.0300	
		1								PRICE ADJUSTMENT, FUEL (N.A.B.L)	690,0400	
		20					20			F-184-5.1 FENCE	699.5150	
									_		-	
							7.					
							- 1					
											1.	
												_
				_			-	_				

		DETAILED SUMMARY OF QUANTITIE
OVANTITIES	UNIT	ITEMS
	-	
-		
	1	
	-	
	-	
-	-	
		_
_		
- 4		
	<u>e ni</u>	
-	-	
-		
	- 1	
	-	
	=	
	-	
-	-	



PROJECT NAME: NORTHFIELD
PROJECT NUMBER: BF 024(58)

FILE NAME: 2191223quan+1+1es.dqn PROJECT LEADER: K. SMITH DESIGNED BY: QUANTITIES SHEET 3 PLOT DATE: 5/29/2025 DRAWN BY: C. JAMISON CHECKED BY: K. SMITH SHEET 8 OF 102

AG			RANS		TATIO	N						E/	۱R	RT	Н١	N	OF	RK	S									
		TOTAL EX	CAVATION RTH	EXCA	OCK	EMBA	NKMENT					TOTAL EX	CAVATION RITH	EMBAI	KMENT	RC EXCAN	XX VATION					SUN	MARY AN	ID BALAN	CES			
STATION	DIST	ASRA	VOLUME	AREA	VOLUME	AREA	VOLUME	AREA	VOLUME	STATION	OIST	AREA	VOLUME	AREA	VOLUME	AREA	VOLUME	AREA	VOLUME	STATION TO STATION	TOT EXC, EARTH	ROCK EXCAV	EMBANK	EXCE	SSES	ACUMULATIV	E EXCESSES	
	FT.	S.F.	C,Y,	S,F,	C,Y,	5.F.	C.Y.	8,F.	C.Y.		FT.	S.F.	C.Y.	8.F.	C,Y.	S.F.	C.Y.	8.F.	C,Y,		C.Y,	C.Y,	C,Y.	CUT	FILL	сит	FILL	
N MAIN ST	VT 12)									DOG RIVER	(CHANN	L)								N MAIN ST (VT 12)								
220+30		0.0	1			0.0				50+00		0.0		. 0,0						220+30 222+69 224+11 226+50	878 607	2.5	0	610				
220+50	20	0.0	0.0		-	0.0	0.0			50+25	25	0.0	0.0	0.0			-			DOG RIVER ICHANNE								
220+75	25		0.0				0.0				25		0.0		0.0					50+00 52+59	1921	0	D	1921				
	25	0.0	0.0			0.0	0.0	-		50+50	43	0.0	0.0	0.0	0.0													
221+00	25	0,0	4.4			0.0	0.0			50+93	7	0.0	29.6	0.0	0.0		-											
221+25	25	9.5	9.4	-		0.0		-		51+00		228.3	Ĭ	0.0														
221+50		10.9			1	0.0	0.0			51+10	10	320.7	101,7	0.5	0.1									-				_
221+75	25 _	73.9	39.3		1	0.0	0.0			51+20	10	B20.9	174.4	1.9	0.4	-	-											
222+00	_25	129.8	94.3			0.0	0.0			51+30	10	411.2	191.1	100	0.4													
	50		2783	*****			0.0				10		153.8	0.0_	0.0									5-48-M1- 6				
222+25	_44_	162.7	313,5	_		0.0	0.0	+	_	51+40	_10_	419.5	157.1	0.0	0.0	-	-						-					
222+50	19	170.8	139,0			0.0	0.0	-		51+50		428.8	160,1	0.0														
222+69		220.6				0.0				51+60	10	436.0		0.0	0.0				_									
BEGINER	DOE ST	A 222+69	0.0				0,0	-		51+70	.10	441.0	162.4	0.0	0.0												********	
END BRI	DGE STA	224+10.8	3		-		_				10		195.5		1.1													
224+11		212.9	<u> </u>			0.0	-			51+80	10	614.5	174,1	_5.8_	1.8									-		-		
224+25	14	298,5	132.6	-	-	0.0	0.0	-	-	51+90	10	325.8	103.4	3.7	_3.1_			_										- 1
11.	25		209.9		-		0.0			52+00		232.7		13.2													//// total .	
224+50	25	154.9	1 115,D		i	0.0	0.0			52+15	15	199.0	119.9	28.7	11.6				-									
224+75	25	_ 93.5	74.8			0.0	0.0			52+25	10	176.1	69.5	34.2	11.6													
225+00		67.7	1			0.0					25		115,9		15.8													
225425	25	47.2	53.2			0.0	÷ 0.0			52+50.0	9	74,3	12,4	0.0	0.0													
225+50	25	0.0	21.8			0.0	: 0.0			52+59		0.0		0.0	-													
	25		0.0		-		0.0																				-	
225+75	25	0.0	0.0	-		0.0	0.0	-		-	-	-	-	-	-		-											
226+00 _	25	0.0	1		4	0.0	I																					
226+25	1	0.0	0.0		-	0.0	0.0																	-				-
226+50	25	0.0	0.0	-	+	0.0	0.0	-	_				-	-			-			TOTAL	3406		0	3411	. 0	3411		
	-	-	i .				-													To the						3911		
					-!																	REMARK	5					
		1			-	-	-	-		-	-		-	-						EARTH AND ROCK E	XGAVATION			3411		1		- 1
					-															SOLID ROCK EXCAV. EARTH EXCAVATION	ATION			5		1		
					·			L.												T				3406		-		
		-						-						-	-				-	PLANMETERED FILL LESS FACTORED SO				0				
	-			- attended	1		1	-												LESS DISPLACEMEN	TOF ANY LA	RGE STRUC	TURES	0				
		-																		NET PLANMETERED FACTOR				1.15		1		
-	-	-	\	-	-			-			1									PLANMETERED FILL	INCLUDING	ACTOR		0				
			1	ļ																LOS AUTOLOS DE SECONO					. tot street a	1		
							1 -										1			MATERIALS AVAILABLE EARTH EXCAVATION				1485				
	-	1	1	-				-		1										CHANNEL EXCAVATE UNDER DRAIN EXCAV	ON NOTES			1921		1		
			1		-															STRUCTURE EXCAV				43				
	1		1		-			1																-		1		
	-	1	1	-	realise best	-				77.35										TOTAL MATERIAL AV	ALABLE FOR	FLL		3449		1		
																				TOTAL FILL INCLUDIR				0				
				-	-													-		TOTAL MAYERIAL FO				3449		-		
	_	-	1		1	_		_		1			_							EXCESS EXCAVATIO	N			3449				



PROJECT NAME: NORTHFIELD

PROJECT NUMBER: BF 024(58)

FILE NAME: 21912236ws.dgn
PROJECT LEADER: K. SMITH
DESIGNED BY1 K. HO
EARTHWORK SMEET

PLOT DATE: 5/29/2025 DRAWN BY: J. DIAZ CHECKED BY: C. JENNE SHEET 9 OF IO2

GENERAL INFORMATION

SYMBOLOGY LEGEND NOTE

THE SYMBOLOGY ON THIS SHEET IS INTENDED TO COVER STANDARD CONVENTIONAL SYMBOLOGY. THE SYMBOLOGY IS STANDARD CONVENTIONAL SYMBOLOGY. THE SYMBOLOGY IS USED FOR EXISTING & PROPOSED FEATURES WITH HEAVIER LINEWEIGHT, IN COMBINATION WITH PROJECT ANNOTATION, AS NOTED ON PROJECT PLAN SHEETS. THIS LEGEND SHEET COVERS THE BASICS, SYMBOLOGY ON PLANS MAY VARY, PLAN ANNOTATIONS AND NOTES SHOULD BE USED TO CLARIFY AS NEEDED.

R.O.W. ABBREVIATIONS (CODES) & SYMBOLS

POINT	CODE	DESCRIPTION
	BF	BARRIER FENCE
	CH	CHANNEL EASEMENT
	CONST	CONSTRUCTION EASEMENT
	CUL	CULVERT EASEMENT
	D&C	DISCONNECT & CONNECT
	DIT	DITCH EASEMENT
	DR	DRAINAGE EASEMENT
	DRIVE	DRIVEWAY EASEMENT
	EC	EROSION CONTROL
	HWY	HIGHWAY EASEMENT
	18:M	INSTALL & MAINTAIN EASEMENT
	LAND	LANDSCAPE EASEMENT
	PDF	PROJECT DEMARCATION FENCE
	R&RES	REMOVE & RESET
	R&REP	REMOVE & REPLACE
	R.T. & I.	RIGHT, TITLE, AND INTEREST
	SR	SLOPE RIGHT
	UE	UTILITY EASEMENT
	(P)	PERMANENT EASEMENT
	(T)	TEMPORARY EASEMENT
	BNDNS	BOUND SET
D	BNDNS	BOUND TO BE SET
0	IPNF	IRON PIN FOUND
•	IPNS	IRON PIN TO BE SET
Ø	CALC	EXISTING ROW POINT
0	PROW	PROPOSED ROW POINT
[LENG	тн7	LENGTH CARRIED ON NEXT SHEET

COMMON TOPOGRAPHIC POINT CYMPOLS

POINT	CODE	DESCRIPTION
#	APL	BOUND APPARENT LOCATION
	ВМ	BENCHMARK
	BND	BOUND
@	СВ	CATCH BASIN
¢	COMB	COMBINATION POLE
(0)	DITHR	DROP INLET THROATED DNC
¢	EL	ELECTRIC POWER POLE
	FPOLE	FLAGPOLE
0	GASFIL	GAS FILLER
0	GP	GUIDE POST
**	GSO	GAS SHUT OFF
•	GUY	GUY POLE
•	GUYW	GUY WIRE
н	GV	GATE VALVE
₽3	н	TREE HARDWOOD
Δ	HCTRL	CONTROL HORIZONTAL
A	HVCTRL	CONTROL HORIZ, & VERTICAL
•	HYD	HYDRANT
•	IP	IRON PIN
•	IPIPE	IRON PIPE
ф	LI	LIGHT - STREET OR YARD
ď	MB	MAILBOX
0	MH	MANHOLE (MH)
	MM	MILE MARKER
•	PM	PARKING METER
9	PMK	PROJECT MARKER
•	POST	POST STONE/WOOD
5	RRSIG	RAILROAD SIGNAL
•	RRSL	RAILROAD SWITCH LEVER
*	S	TREE SOFTWOOD
***	SAT	SATELLITE DISH
€3	SHRUB	SHRUB
0	SIGN	SIGN
A	STUMP	STUMP
۰	TEL	TELEPHONE POLE
•	TIE	TIE
0.0	TSIGN	SIGN W/DOUBLE POST
*	VCTRL	CONTROL VERTICAL
•	WELL	WELL
	WSO	WATER SHUT OFF

THESE ARE COMMON VAOT SURVEY POINT SYMBOLS FOR EXISTING FEATURES, ALSO USED FOR PROPOSED FEATURES WITH HEAVIER LINEWEIGHT, IN COMBINATION WITH PROPOSED ANNOTATION.

PROPO	SED GEOMETRY CODES	
CODE	DESCRIPTION	
PC	POINT OF CURVATURE	
PI	POINT OF INTERSECTION	
CC	CENTER OF CURVE	
PT	POINT OF TANGENCY	
PCC	POINT OF COMPOUND CURVE	
PRC	POINT OF REVERSE CURVE	
POB	POINT OF BEGINNING	
POE	POINT OF ENDING	
STA	STATION PREFIX	
AH	AHEAD STATION SUFFIX	
BK	BACK STATION SUFFIX	
D	CURVE DEGREE OF ((OOFT)	
R	CURVE RADIUS OF	
T	CURVE TANGENT LENGTH	
L	CURVE LENGTH OF	
E	CURVE EXTERNAL DISTANCE	
CB	CHORD BEARING	

UTILITY SYMBOLOGY UNDERGROUND UTILITIES - UGU -- · · - · · - UTILITY (GENERIC-UNKNOWN) - UT ----- TELEPHONE - UE - · · · · · ELECTRIC - UC - · · - · E- CABLE (TV) - UEC - - - ELECTRIC+CABLE - UET - . . - . . - ELECTRIC+TELEPHONE - UCT - . . - . M.- CABLE+TELEPHONE - UECT - · · - · ELECTRIC+CABLE+TELEPHONE - 6 -- · · - · · ~ GAS LINE -- W -- ·- - WATER LINE - s - · · - · · - SANITARY SEWER (SEPTIC) ABOVE GROUND UTILITIES (AERIAL) - AGU - · · - · · - UTILITY (GENERIC-UNKNOWN) — T — · · − · · - TELEPHONE - E -- · · - ELECTRIC - c -- -- CABLE (TV) EC --- - ELECTRIC+CABLE - ET - · · - · · - ELECTRIC+TELEPHONE - AER E&T - · · - · ELECTRIC+TELEPHONE - ct - · · - · · - CABLE+TELEPHONE - ECT - · · - · · - ELECTRIC+CABLE+TELEPHONE ----- UTILITY POLE GUY WIRE PROJECT CONSTRUCTION SYMBOLOGY

PROJECT DESIGN & L	AYOUT SYMBOLOGY
cz	CLEAR ZONE PLAN LAYOUT MATCHLINE

PROJECT CONSTRUCTION FEATURES

TOP OF CUT SLOPE
TOE OF FILL SLOPE
STONE FILL
BOTTOM OF DITCH &
CULVERT PROPOSED
STRUCTURE SUBSURFACE
PROJECT DEMARCATION FENCE
BARRIER FENCE
TREE PROTECTION ZONE (TPZ)
STRIPING LINE REMOVAL
SHEET PILES

CONVENTIONAL BOUNDARY SYMBOLOGY

UNDARY LINES	
	TOWN BOUNDARY LINE
	COUNTY BOUNDARY LINE
JAN UM	STATE BOUNDARY LINE
	PROPOSED STATE R.O.W.
	(LIMITED ACCESS)
	- PROPOSED STATE R.O.W.
	STATE ROW (LIMITED ACCESS)
	STATE ROW
	TOWN ROW
- · - · - · - ·	 PERMANENT EASEMENT LINE (P)
	 TEMPORARY EASEMENT LINE (T)
	SURVEY LINE
<u> </u>	- PROPERTY LINE (P/L)
SR SR S	R SLOPE RIGHTS
61	6F PROPERTY BOUNDARY
7	- 4F PROPERTY BOUNDARY
HAZ	HAZARDOUS WASTE

EPSC LAYOUT PLAN SYMBOLOGY

1 30 EA1001 F	LAIT STMIDULUUT
EPSC MEASURE	S
ОМИСОМИСОМИС	FILTER CURTAIN
	SILT FENCE
0 0 X 0 X 0 X	SILT FENCE WOVEN WIRE
·	CHECK DAM
	DISTURBED AREAS REOURING RE-VEGETATION
	EROSION MATTING
	EROSION LOG
SEE EPSC DETAIL	SHEETS FOR ADDITIONAL SYMBOLOGY
ENVIRONMENTAL	RESOURCES
	WETLAND BOUNDARY
	RIPARIAN BUFFER ZONE
	WETLAND BUFFER ZONE
	SOIL TYPE BOUNDARY
TAE	THREATENED & ENDANGERED SPECIES
HAZ HAZ	HAZARDOUS WASTE AREA
AG	AGRICULTURAL LAND
HABITAT	FISH & WILDLIFE HABITAT
- FLOOD PLAN -	FLOOD PLAIN
-√0H₩√-	ORDINARY HIGH WATER (OHW)
	STORM WATER
	USDA FOREST SERVICE LANDS
	WILDLIFE HABITAT SUIT/CONN
	MEDERE HADITAT SOTTOONIN
RCHEOLOGICAL	& HISTORIC
ARCH	ARCHEOLOGICAL BOUNDARY
HISTORIC DIST	HISTORIC DISTRICT BOUNDARY
	HISTORIC AREA
(H)	HISTÓRIC STRUCTURE
U	

CONVENTIONAL TOPOGRAPHIC SYMBOLOGY

STING FEATURES	ROAD EDGE PAVEMENT
	ROAD EDGE GRAVEL
	DRIVEWAY EDGE
	DITCH
	FOUNDATION
×	FENCE (EXISTING)
ooo	FENCE WOOD POST
0-0-0-0-	FENCE STEEL POST
	GARDEN
- 0 0 0 0 0 0 0	ROAD GUARDRAIL
10001110000000000000000000000000000000	RAILROAD TRACKS
***************************************	DISTRIBUTE ADMICTINGS
	CULVERT (EXISTING)
000000000000000000000000000000000000000	STONE WALL
	WALL
	WOOD LINE
white	BRUSH LINE
	HEDGE
<i>======</i>	BODY OF WATER EDGE
211831183118311	LEDGE EXPOSED

PROJECT PROJECT			RTHFIELD 024K58)		
FILE NAM	end.dan	PLDT	D		

ATE: 5/29/2025 PROJECT LEADER: K. SMITH DRAWN BY: VTRANS DESIGNED BY: VTRANS
CONVENTIONAL SYMBOLOGY LEGEND CHECKED BY: VTRANS SHEET IO OF 102

GPS CONTROL POINTS

10

ш

-

ليا

RAVERS

-

POB 220+25.00

NORTH = 60972.89

EAST = 1599429.98

HVCTRL #2

NAIL IN COMB

NORTH = 601331.244

EAST = 1599536.458

HVCTRL #3

NORTH = 600836.112

EAST = 1599371.534

ELEV. = 739.54

SCALE | 1" = 40'

NAIL IN COMB 3/30

NAIL IN COMB 3/30

STATE PLANE COORDINATES WERE DERIVED THROUGH THE USE OF RTK GPS UTILIZING THE VERMONT CORS SYSTEM POINTS ONE AND TWO WERE OCCUPIED WITH LEICA GSI5 GNSS UNITS, POINTS THREE, TEN, AND THIRTY ONE WERE CREATED WITH A LEICA TSI6 ROBOTIC TOTAL STATION

VCAP

NORTH = 642,229,41

EAST = 1,618,636,27

ORTHO HEIGHT = 617,5

This is a GPS Continuously Operating Reference Station.
VERWONT CAPITAL CORS ARP


CORS.10 - VIRU

PID - AF9563

STATE/COUNTY - VIWASHINGTON
COUNTRY - USAS GUAD - MONTPELIER (1968)
U.S. NATIONAL GRID SPATIAL ADDRESS: 18TX09297703812

(NAD 83)

MARKER: STATION IS THE ANTENNA REFERENCE POINT OF THE GPS ANTENNA

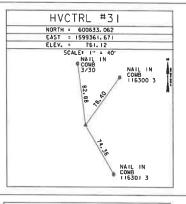

BM #1429 NORTH = 601488,407 EAST = 1599565.674 S ELEV. = 729.94 (1) SCALE: 1" = 20" ш ш DOCK SPIKE IN COMB 5 115869 9100 9000 5 \vdash GNMENT ш S α . 🚱 ΛE ⋖ \propto DOLLAR GENERAL 83 000

HVCTRL #1

NORTH = 60. EAST = 1599570, 00. ELEV. = 127.70 SCALE! !" = 50 NAIL (N

> NAIL IN COMB 5 115869 9100 9000 5

> > POB 220+25,00
> >
> > | NORTH = 500972,89
> > | EAST = 1599429,98
> > | Head | NOT TIED |
> > | NOT TIED |
> > | NOT TIED |

PC 224+70.83

NORTH = 601409.00

EAST = 1599522.55

NOT TIED

PT 226+33.41

NORTH * 601570.00

EAST = 1599544.00

NOT TIED

POE 228+04.68

NORTH = 501741.01

EAST = 1599553.55

NOT TIED

DATUM


 VERTICAL
 NAVO 88


 HORIZONTAL
 NAD 83 (2010)


 ADJUSTMENT
 Least Sq.


PROJECT NAME: NORTHFIELD PROJECT NUMBER: BF 0241(58)

FILE NAME: zi9J223+1.dgn PROJECT LEADER: K. SMITH DESIGNED BY: K. HO SURVEY TIE SHEET PLOT DATE: 5/29/2025 DRAWN BY: S.BROWN CHECKED BY: K.HO SHEET II OF 102

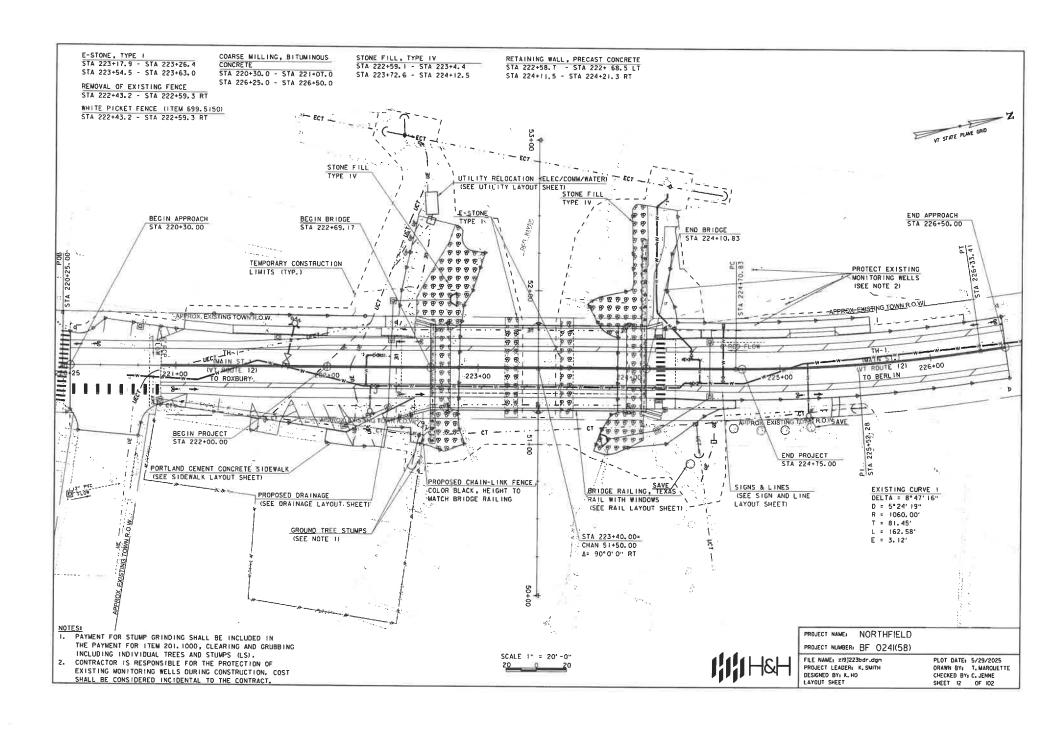

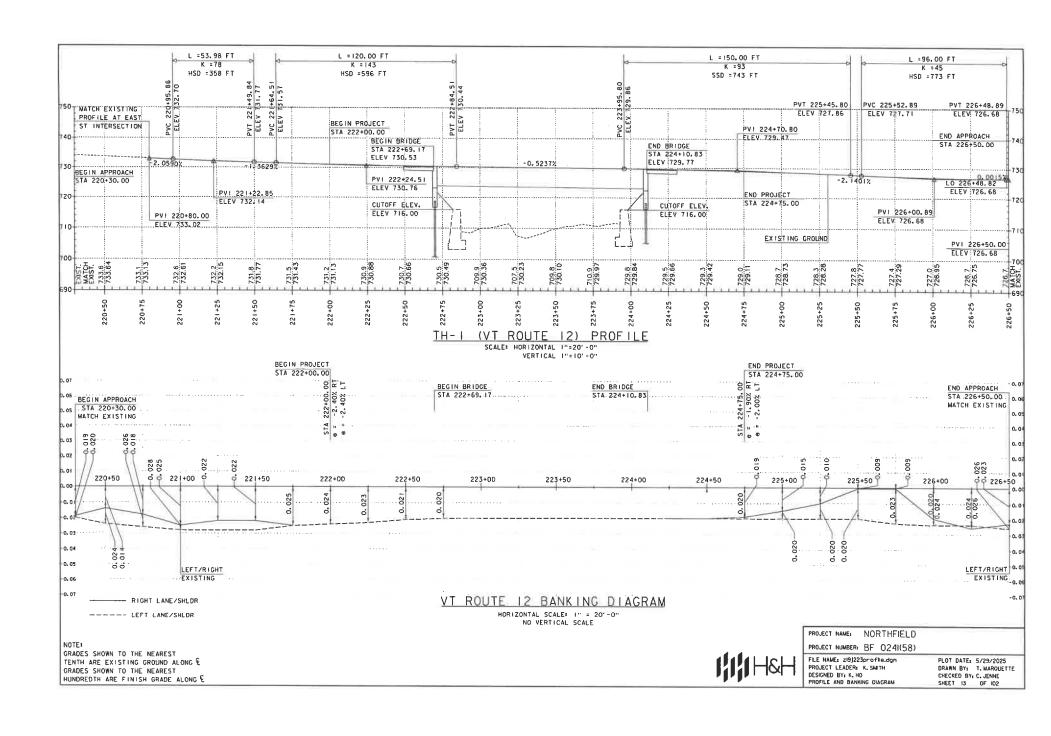

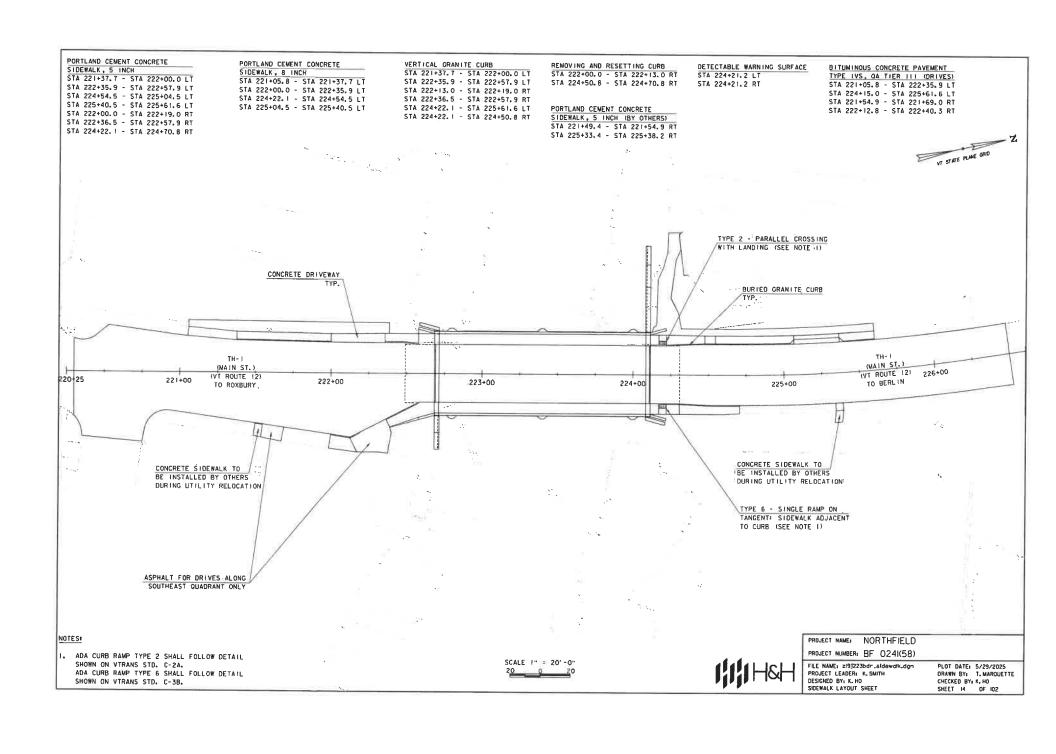

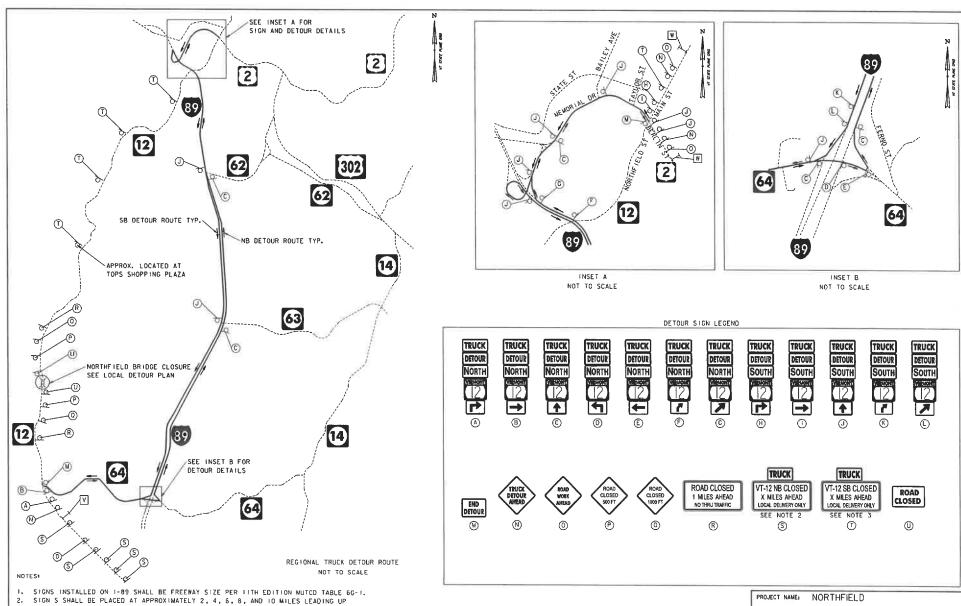


TO BRIDGE CLOSURE. SYMBOL V REFERS TO A PCMS DISPLAYING THE MESSAGE: "VT-12 NORTH CLOSED 7 PM MM/DD - 7 AM MM/DD".

4. SYMBOL W REFERS TO A PCMS DISPLAYING THE MESSAGE: "VT-12 SOUTH CLOSED 7 PM MM/DD - 7 AM MM/DD",

PROJECT NUMBER: BF 0241(58)

FILE NAME: zi9J223detour.dgn PROJECT LEADER: K. SMITH DESIGNED BY: K. HO TRUCK DETOUR ROLITE

PLOT DATE: 5/29/2025 DRAWN BY: T. MARQUETTE CHECKED BY: C. JENNE SHEET 15 OF 102

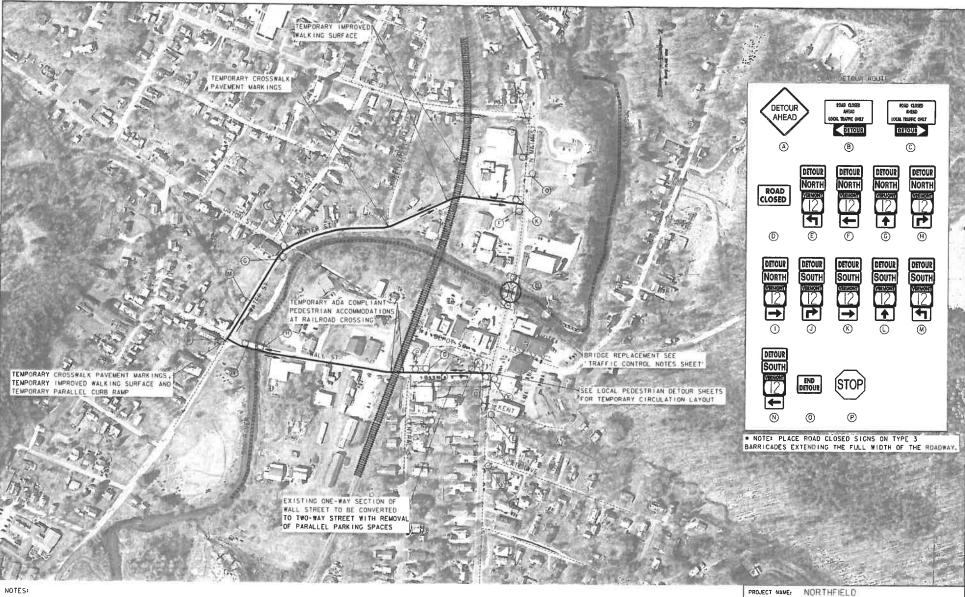

I. REFER TO LOCAL PEDESTRIAN DETOUR SHEETS FOR ADDITIONAL DETAILS.

 SIDEWALK AND DRIVEWAY ACCESS TO COMMERCIAL BUSINESSES SHALL BE MAINTAINED AT ALL TIMES. PROJECT NUMBER: BF 0241(58)

FILE NAME: zi9j223detour.dgn PROJECT LEADER: K. SMITH DESIGNED BY: K. HO LOCAL DETOUR ROUTE

PLOT DATE: \$/29/2025

ORAWN BY: T. MARQUETTE
CHECKED BY: C. JENNE
SHEET 16 OF 102

TRAFFIC CONTROL NOTES

- I. TRAFFIC MANAGEMENT WILL BE ACCOMPLISHED USING AN OFF-SITE LOCAL DETOUR ON WATER STREET AND WALL STREET, AND A TRUCK DETOUR ON VT-64/1-89/US-2 DURING A 12 WEEK BRIDGE CLOSURE PERIOD.
- 2. A BICYCLE/PEDESTRIAN DETOUR VIA LOCAL ROADS WILL BE SIGNED AS SHOWN.
- 3. SIDEWALK AND DRIVEWAY ACCESS TO COMMERCIAL BUSINESSES SHALL BE MAINTAINED AT ALL TIMES.
- 4. TRAFFIC FROM GAS STATION ON NORTH SIDE OF BRIDGE TO USE PORTION OF DRIVEWAY AS EGRESS.
- 5. A PORTION OF THE GAS STATION DRIVEWAY WILL BE CLOSED WITH TEMPORARY CONCRETE BARRIERS FOR WORK JONE PURPOSES.
- EXISTING ONE-WAY SECTION OF WALL STREET TO BE CONVERTED TO TWO-WAY STREET WITH REMOVAL OF PARALLEL PARKING SPACES, SEE DWG FOR DETAILS.
- PAYMENT FOR ALL ELEMENTS ASSOCIATED WITH WORK ZONE TRAFFIC CONTROL SHALL BE INCLUDED LINDER 'ITEM 64LIOOO - TRAFFIC CONTROL', LINLESS OTHERWISE NOTED ON THE PLANS.

PEDESTRIAN TEMPORARY TRAFFIC CONTROL NOTES

- I. THE CONTRACTOR SHALL PROVIDE A TEMPORARY PEDESTRIAN ACCESS ROUTE (TPAR) FOR REVIEW AND WRITTEN APPROVAL BY THE RESIDENT ENGINEER A MINIMUM OF THREE WEEKS BEFORE SUCH PLAN IS IMPLEMENTED. THIS PLAN SHALL DETAIL THE CONSTRUCTION PHASING AND SCHEDULE AND THE SPECIFIC METHODS OF MAINTAINING SAFE PEDESTRIAN ACCESS THROUGHOUT THE CONSTRUCTION AREA, THIS PLAN SHALL PROVIDE THE LOCATION AND DETAILS OF TEMPORARY CONSTRUCTION SIGNING, MARKINGS, BARRICADES, CHANNELIZING DEVICES, TPARS AND METHODS TO MAINTAIN ACCESS TO ADJACENT PROPERTIES, BUSINESSES, RESIDENCES, ETC.
- THE CONTRACTOR SHALL MAINTAIN PEDESTRIAN THROUGH MOVEMENTS FROM ONE END OF THE
 CONSTRUCTION AREA TO THE OTHER, ON AT LEAST ONE SIDE OF THE STREET DURING CONSTRUCTION.
 ANY SIDEWALK CLOSURES SHALL MEET THE REDUIREMENTS OF THE MANUAL ON UNIFORM TRAFFIC
 CONTROL DEVICES (MUTCD), PART 6.
- PEDESTRIAN ACCESS SHALL BE PROVIDED TO ALL ADJACENT PROPERTIES, BUILDINGS, RESIDENCES, COMMERCIAL PROPERTIES AND TRANSIT STOPS, THIS MAY INCLUDE TEMPORARY WALKWAYS SPANNING THE CONSTRUCTION AREA.
- 4. IF SIDEWALKS ARE CLOSED, A TEMPORARY PEDESTRIAN ACCESS ROUTE (TPAR) SHALL BE PROVIDED ON THE SAME SIDE OF THE ROAD AS THE CLOSED SIDEWALK, IF POSSIBLE, SIGNS AND BARRIADES SHALL BE USED TO PROVIDE ADVANCE NOTICE OF THE CLOSURE AND THE ROUTE OF ANY PEDESTRIAN DETOURS. THE TPAR SHALL HAVE A MINIMUM UNOBSTRUCTED WIDTH OF 4 FEET, IF THE TPAR IS LESS THAN 5 FEET IN WIDTH, A 5 FOOT BY 5 FOOT PASSING SPACE MUST BE PROVIDED AT LEAST EVERY 200 FEET. THE SURFACE OF THE TPAR SHALL BE FIRM, STABLE AND SLIP-RESISTANT AND CONTINUOUS WITH A MINIMUM BO INCHES OVERHEAD CLEARANCE FOR THE LENGTH OF THE TPAR. THE TPAR SHALL MAINTAIN THE SAME LEVEL OF ACCESSIBILITY AND DETECTABILITY AS THE FACILITY THAT IS BEING CLOSED, THE TPAR SHALL NOT LEAD PEDESTRIANS INTO CONFILCTS WITH VEHICLES, EQUIPMENT, OR CONSTRUCTION OPERATIONS.
- 5. WHEN TEMPORARY CROSSWALKS ARE UTILIZED FOR THE TPAR, TEMPORARY DETECTABLE WARNINGS SHALL BE PLACED AT EACH END OF THE TEMPORARY CROSSWALKS, THE TEMPORARY CROSSWALK SHALL BE DELINEATED WITH TEMPORARY PAVEMENT MARKINGS OR TAPE, THE MARKINGS SHALL BE PARALLEL 12-INCH-WIDE WHITE LINES PLACE 7 FEET ON CENTER APART. IT SHOULD BE NOTED THAT CUMB PARKING SHALL BE PROHIBITED FOR AT LEAST 20 FEET IN ADVANCE OF MIDBLOCK CROSSWALKS, TEMPORARY CROSSWALK SIGNS SHALL BE PROVIDED FOR THE CROSSWALK.


- 6. IF THERE IS WORK OCCURRING OVER AN OPEN SIDEWALK, PROTECTIVE OVERHEAD COVERING MUST BE PROVIDED AS NECESSARY TO ENSURE PROTECTION FROM FALLING OBJECTS AND DRIPPING FROM OVERHEAD STRUCTURES, COVERED WALKWAYS SHOULD BE STURDILY CONSTRUCTED AND ADEQUATELY LICHTED FOR NIGHTIME USE.
- 7. INDIVIDUAL CHANNELIZING DEVICES, TAPE, OR ROPE USED TO CONNECT INDIVIDUAL DEVICES AND OTHER DISCONTINUOUS BARRIERS AND DEVICES, PAVEMENT MARKINGS ARE NOT DETECTABLE BY PERSONS WITH VISUAL DISABILITIES. THESE MEASURES DO NOT PROVIDE ACCEPTABLE PATH GUIDANCE ON TEMPORARY OR RE-ALIGNED SIDEWALKS OR OTHER PEDESTRIAN FACILITIES. PEDESTRIAN CHANNELIZING DEVICES SHALL INCLUDE A CONTINUOUSLY DETECTABLE BOTTOM AND TOP EDGE THROUGHOUT THE LENGTH OF THE FACILITY SUCH THAT IT CAN BE FOLLOWED BY PEDESTRIANS USING LONG CANES FOR GUIDANCE.
- 8. CHANNELIZING DEVICES ON BOTH SIDES OF THE TPAR SHALL INCLUDE A CONTINUOUS SOLID TOP AND BOTTOM RAILS. THE TOP EDGE OF THE TOP RAIL SHALL BE BETWEEN 32 INCHES AND 38 INCHES ABOVE THE GROUND LEVEL THE BOTTOM RAIL SHALL BE AT LEAST B INCHES WIDE PER HITH EDITION MUTCD, WITH THE BOTTOM EDGE OF THE BOTTOM RAIL SURFACE NO HIGHER THAN 2 INCHES ABOVE THE GROUND.
- IF THE TPAR IS ADJACENT TO MOVING TRAFFIC, CONSTRUCTION OPERATIONS/EQUIPMENT, OR DROPOFFS, THEN CRASHWORTHY CHANNELIZING DEVICES THAT MEET THE REQUIREMENTS OF THE IITH EDITION MUTCD SHALL BE USED.
- 10. THE CONTRACTOR SHALL NOT STORE OR PLACE ANY CONSTRUCTION MATERIALS, EQUIPMENT OR SIGNS IN THE PEDESTRIAN PATH OF TRAVEL.
- II. PROVISION OF THE TPAR AND ALL ITS ELEMENTS, INCLUDING BUT NOT LIMITED TO SIGNS, CHANNELIZING DEVICES, BARRICADES, TEMPORARY CUIB RAMPS, TEMPORARY PAVEMENT MARKINGS AND OTHER TRAFFIC CONTROL DEVICES IS TO BE PAID FOR INCIDENTAL TO TRAFFIC CONTROL (ITEM 64I,IDDO).
- 12. THE CONTRACTOR SHALL REVIEW AND USE THE "VERMONT BICYCLE AND PEDESTRIAN WORK ZONE TRAFFIC CONTROL GUIDE", AVAILABLE ON VTRANS WEBSITE TO DESIGN AND IMPLEMENT TRAFFIC CONTROL FOR BICYCLE AND PEDESTRIAN INTO THEIR SITE-SPECIFIC TRAFFIC CONTROL PLAN FOR ALL STAGES OF CONSTRUCTION.


IIIH&H

PROJECT NAME: NORTHFIELD
PROJECT NUMBER: BF 024I(58)

FILE NAME: z19J223+raff(cNotes,dgn PROJECT LEADER: K. SMITH DESIGNED BY: K. HO TRAFFIC CONTROL NOTES

PLOT DATE: 5/29/2025 DRAWN BY: T. MARQUETTE CHECKED BY: C. JENNE SHEET 17 OF 102

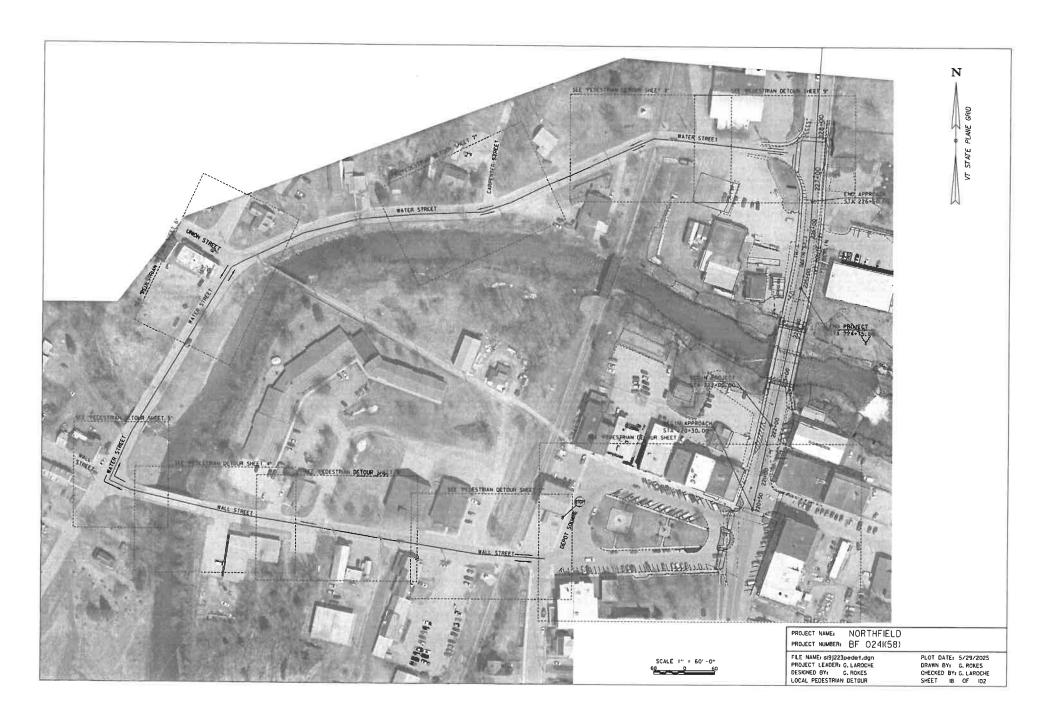

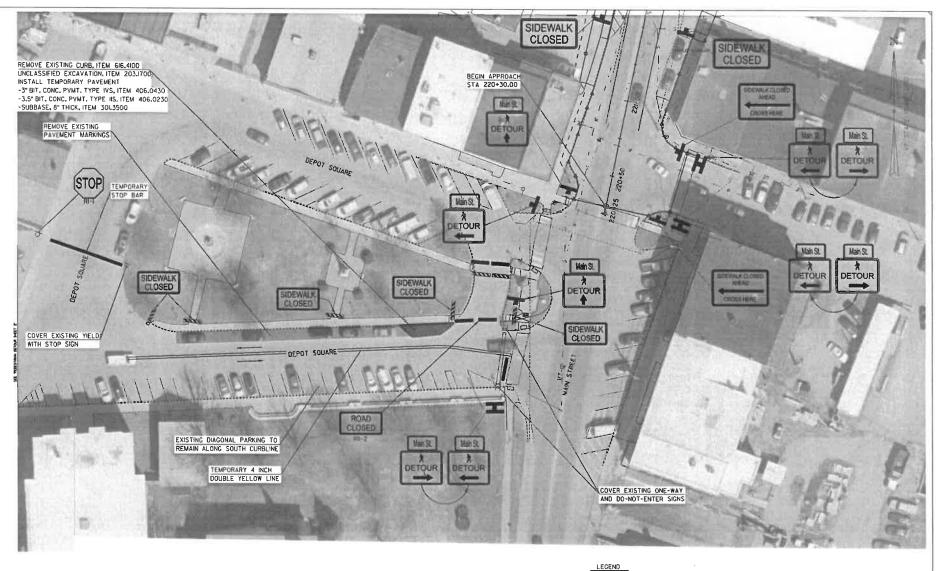

NOTES:

- PLACEMENT OF THE DEVICES SHOWN ON THIS SHEET ARE REFERENCED FROM "VERMONT BICYCLE AND PEDESTRIAN WORK ZONE TRAFFIC CONTROL GUIDE".
- SIDEWALK AND DRIVEWAY ACCESS TO COMMERCIAL BUSINESSES SHALL BE MAINTAINED AT ALL TIMES.
- ANY AREAS IMPACTED BY CONSTRUCTION SHALL BE RESTORED IN KIND TO PRE-CONSTRUCTION CONDITIONS PRIOR TO PROJECT COMPLETION.

NOTE: SEE TPAR NOTES SHEET




PEDESTRIAN DETOUR SIGN (TEMP)
PEDESTRIAN DETOUR SIGN (TEMP)
(BACK TO BACK)
LONGITUDINAL CHANNELIZING DEVICE (PCD)
PEDESTRIAN BARRICADE (TYPE II) (PCD)


DETECTABLE WARNING SURFACE (TEMP)


DESIGN

PROJECT NAME: NORTHFIELD PROJECT NUMBER: BF 0241(58)

FILE NAME: 319 J223 pedet.dgn PROJECT LEADER: G. LAROCHE DESIGNED 8Y: G. ROKES LOCAL PEDESTRIAN DETOUR SHEET I PLOT DATE: 5/29/2025 DRAWN BY: G. ROKES CHECKED BY: G. LAROCHE SHEET 19 OF 102

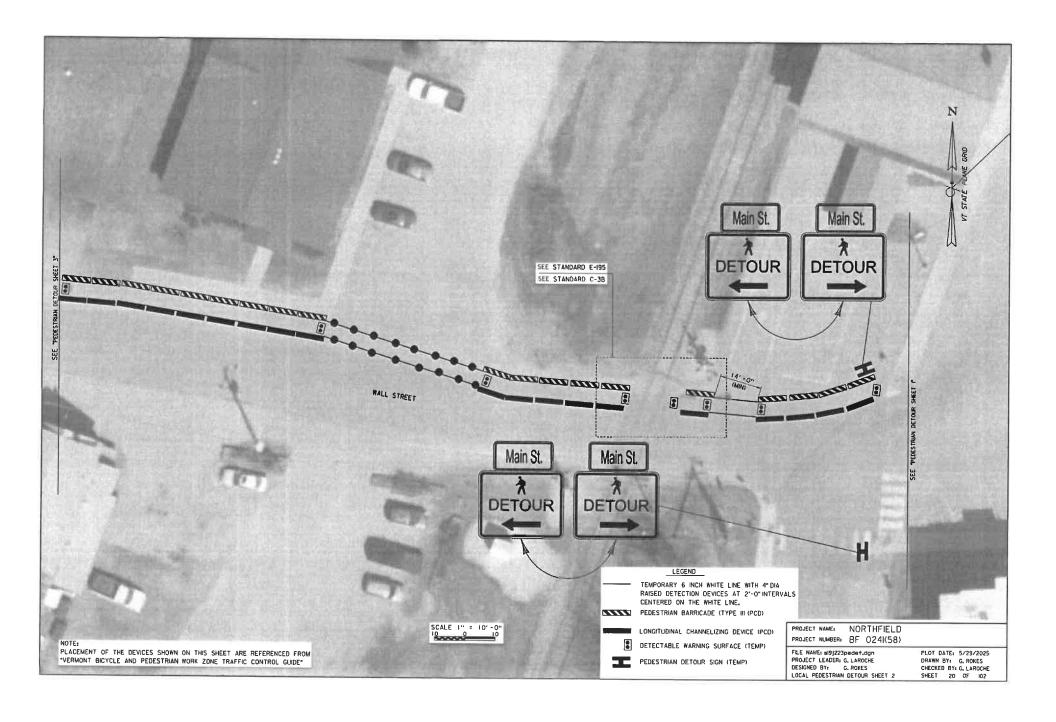

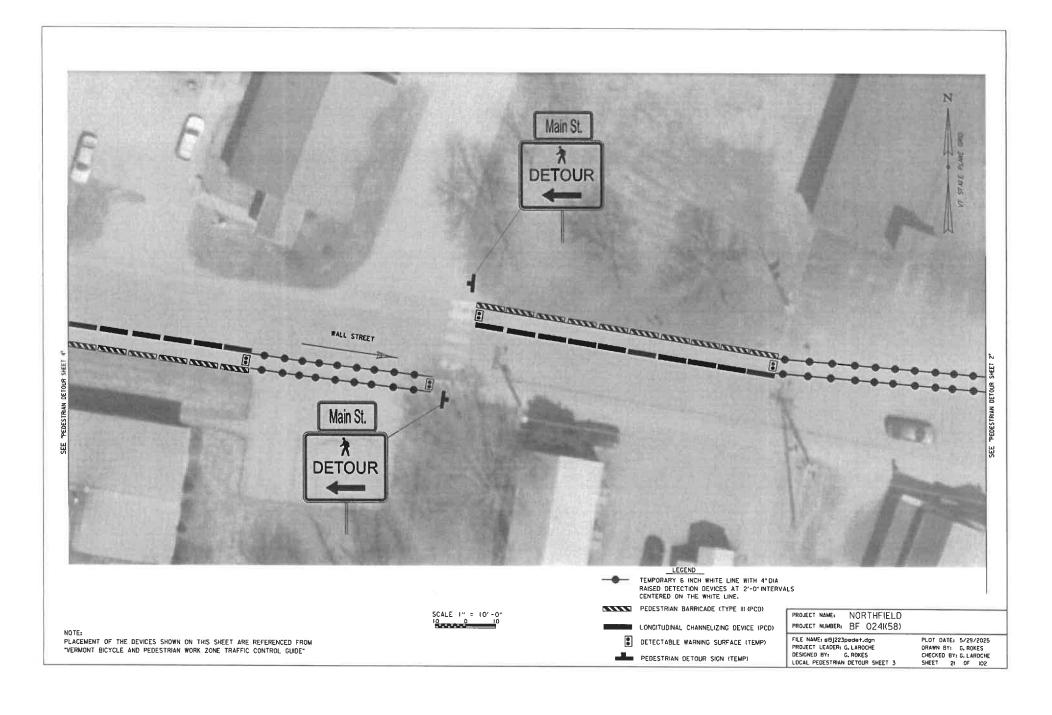

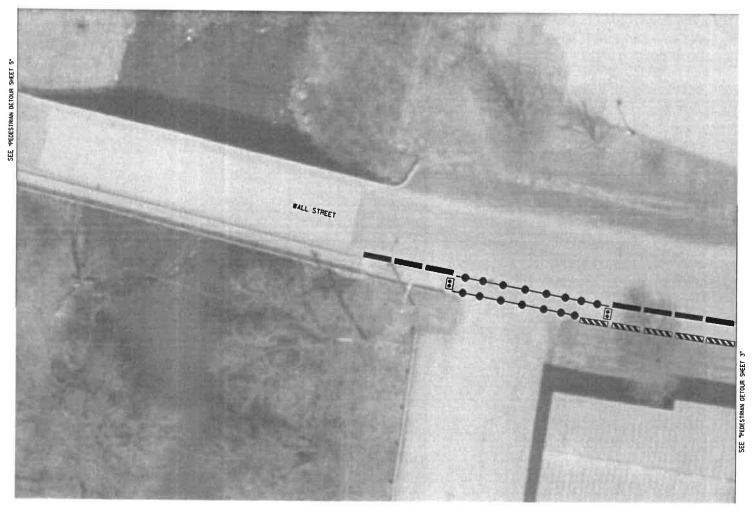

LEGEND

-

TEMPORARY 6 INCH WHITE LINE WITH 4"OIA RAISED DETECTION DEVICES AT 2'-0"INTERVALS CENTERED ON THE WHITE LINE,

PEDESTRIAN BARRICADE (TYPE II) (PCD)


LONGITUDINAL CHANNELIZING DEVICE (PCD)


DETECTABLE WARNING SURFACE (TEMP)

PROJECT NAME: NORTHFIELD PROJECT NUMBER: BF 024(58)


FILE NAME: si9]223pede+.dgn PROJECT LEADER: G. LAROCHE DESIGNED BY: G. ROKES LOCAL PEDESTRIAN DETOUR SMEET 4 PLOT DATE: 5/29/2025 DRAWN BY: G. ROKES CHECKED BY: G. LAROCHE SHEET 22 OF ID2


NOTE: PLACEMENT OF THE DEVICES SHOWN ON THIS SHEET ARE REFERENCED FROM "VERMONT BICYCLE AND PEDESTRIAN WORK ZONE TRAFFIC CONTROL GUIDE" SCALE I" = 10'-0"

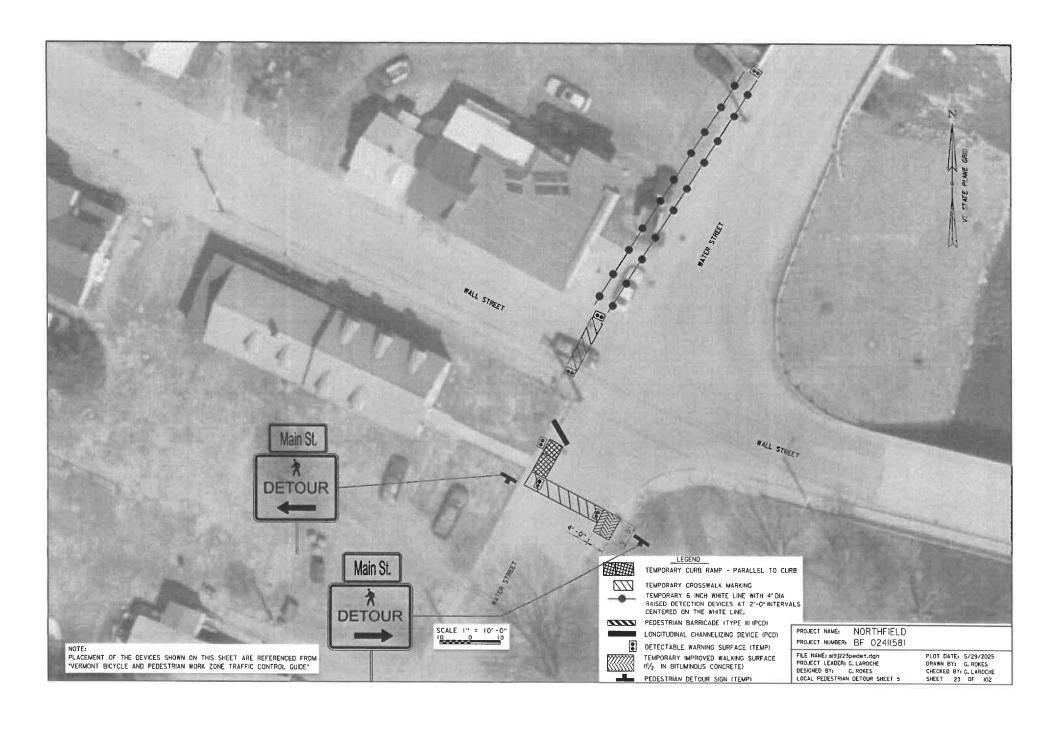


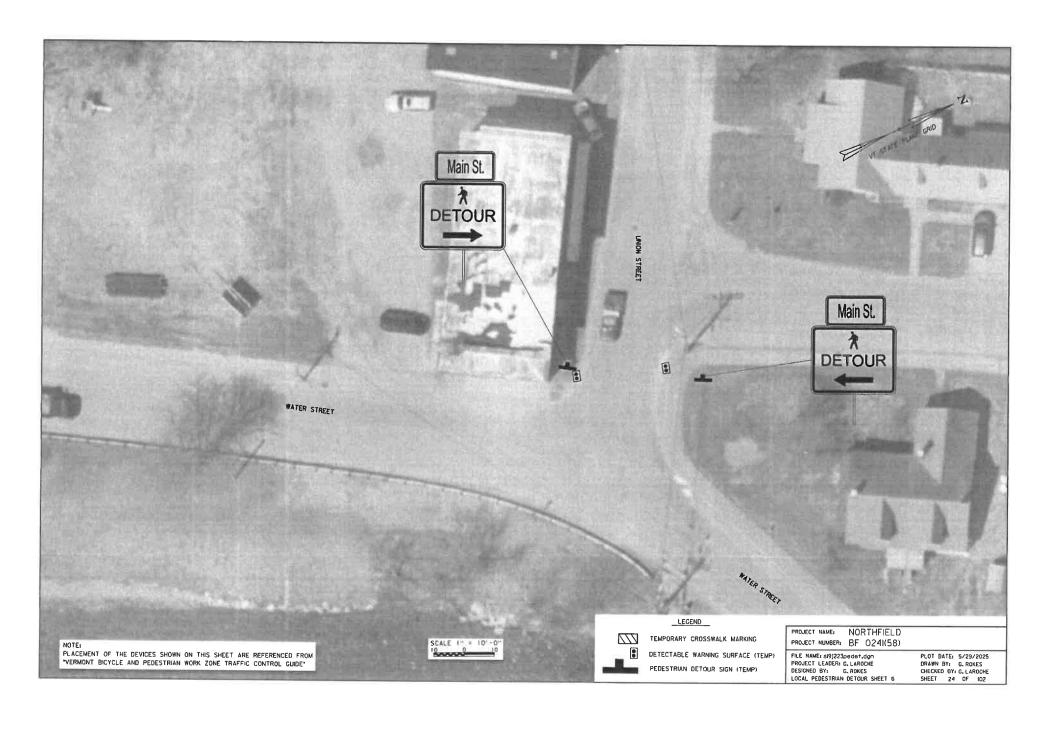




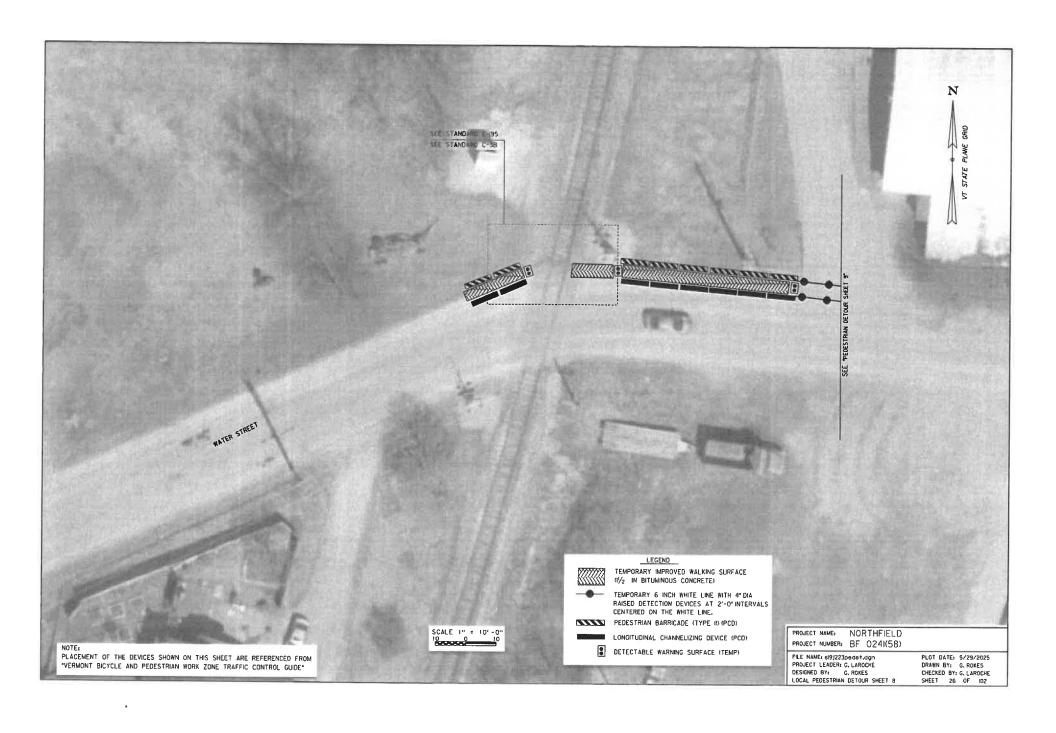

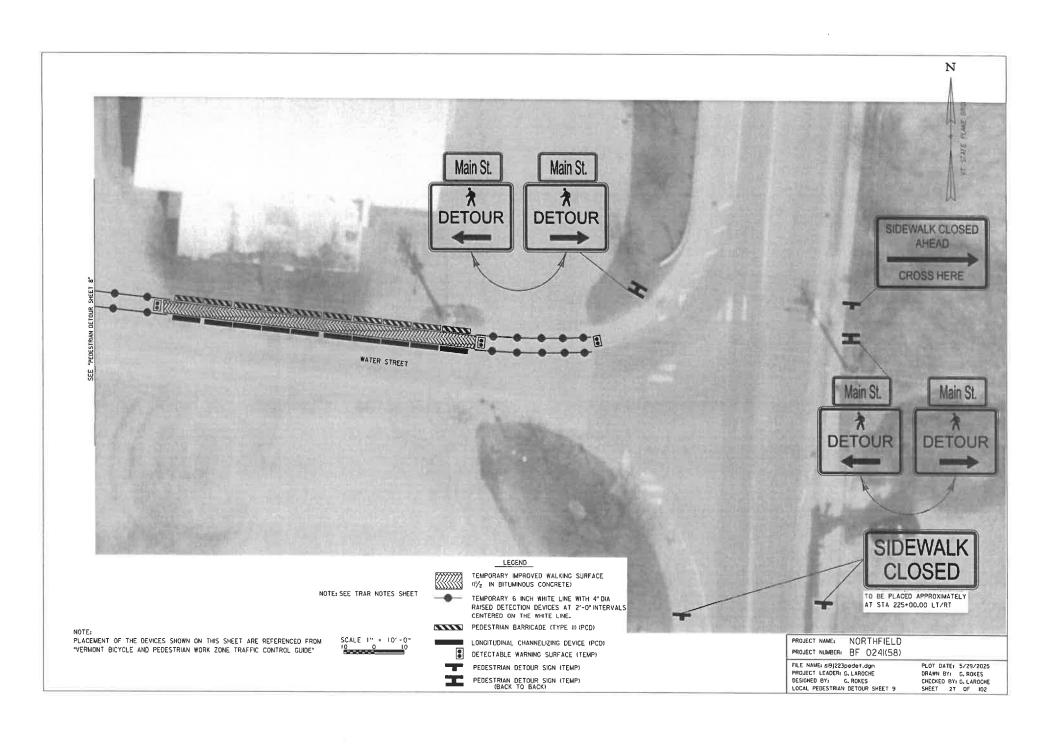


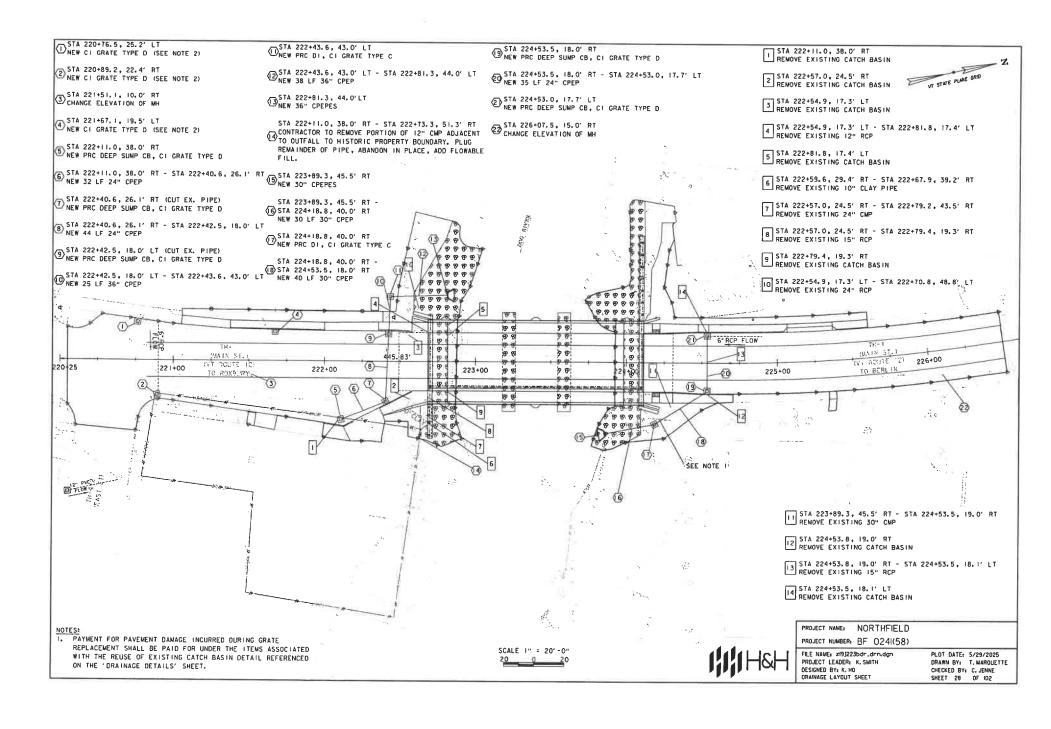

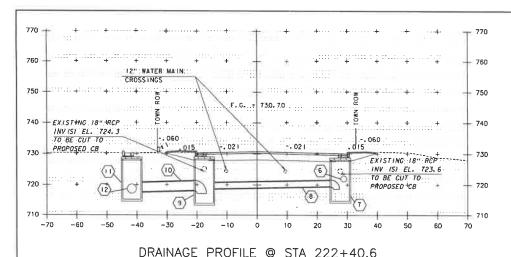

- 6 STA 222+11.0, 38.0' RT STA 222+40.6, 26.1' RT NEW 32 LF 24" CPEP INLET EL 721.2 OUTLET EL 721.0
- T STA 222+40.6, 26.1' RT
 NEW PRC DEEP SUMP CB. CI GRATE TYPE D
 TOP OF GRATE EL 730.1
 SUMP EL 718.6
- (B) STA 222+40.6, 26.1' RT STA 222+42.5, 18.0' LT NEW 44 LF 24" CPEP INLET EL 719.4 OUTLET EL 719.7
- (9) STA 222+42.5, 18.0' LT NEW PRC DEEP SUMP CB, CI GRATE TYPE D TOP OF GRATE EL 730.3 SUMP EL 717.2

- (0) STA 222+42.5, 18.0' LT STA 222+43.6, 43.0' LT NEW 25 LF 36" CPEP INLET EL 718.21 OUTLET EL 717.7
- STA 222+43.6, 43.0' LT
 NEW PRC DI, CI GRATE TYPE C
 TOP OF GRATE EL 730.2
 OUTLET EL 717.18
- (12) STA 222+43.6, 43.0' LT STA 222+81.3, 44.0' LT NEW 38 LF 36" CPEP INLET EL 717.18 OUTLET EL 716.00

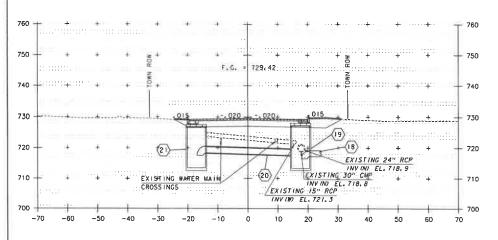


- (B) STA 224+18.8, 40.0' RT STA 224+53.5, 18.0' RT NEW 40 LF 30" CPEP INLET EL 717.25 OUTLET EL 716.7 (SEE CHANNEL XS AT STA 51+10 FOR DI INFO)
- (9) STA 224+53.5, 18.0' RT NEW PRC DEEP SUMP CB, CI GRATE TYPE D TOP OF GRATE EL. 729.28 SUMP EL. 716.5
- \$\frac{1}{20}\$ STA 224+53.5, I8.0' RT STA 224+53.0, I7.7' LT NEW 35 LF 24" CPEP INLET EL. 71B.4 OUTLET EL.71F.6
- (21) STA 224+53.5, 17.7' LT NEW PRC DEEP SUMP CB, CI GRATE TYPE D TOP OF GRATE EL 728.81 SUMP EL 717.52


DRAINAGE PROFILE @ STA 224+53.5


PROJECT NAME: NORTHFIELD
PROJECT NUMBER: BF 024(58)

FILE NAME: ZI9J223x8.dgn PROJECT LEADER: K, SMITH DESIGNED BY: K, HO DRAINAGE PROFILE PLOT DATE: 5/29/2025 DRAWN BY: J. DIAZ CHECKED BY: C. JENNE SHEET 29 OF IO2

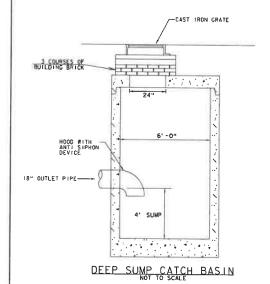

NOTE:
WATERSTOP WITH PIPE GASKET, CAST IRON FRAME AND
WATERSTOP WITH ANYT STPHEN DEVICE,
GRATES, WANHOLE RUNGS, HODD WITH ANYT STPHEN DEVICE,
ARE INCIDENTAL TO ITEM GOAZ GOOD PRECAST REINFORCE
CONCRETE CATCH BASIN WITH CAST IRON GRATE (DEEP SUMP)

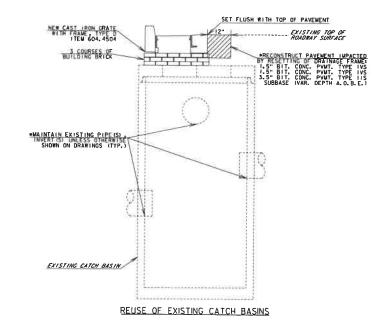

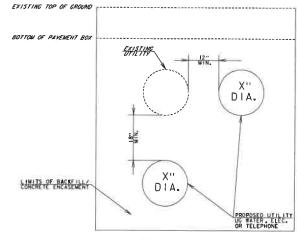

UNDERGROUND UTILITY CLEARANCE DIAGRAM

IIIIH&H

PROJECT NAME: NORTHFIELD
PROJECT NUMBER: BF 024(58)

FILE NAME: z19]223drn_det.dgn PROJECT LEADER: K.SMITH DESIGNED BY: K.HO DRAINAGE DETAILS

PLOT DATE: 5/29/2025 DRAWN BY: J. DIAZ CHECKED BY: C. JENNE SHEET 30 OF 102


TATION 81	MOIFA	POS.	ASKEW	NLET	ET TYP	OUL NI	OUT	SPAN :	E ARCH RISE IN	L PT	PPE D N	L P	CSP C	ALLOY AP RC	VABLE OPT P CSF L TH	CPEI	P PCCBF	PPE	ES	СВ	R C C C	OÉPTH DI	CONC CLASS	REDF STEEL	OI GRATE	CHAN ELEV	СРВМ	EXCAVATION	EXC	CHAN	STRUCT	BKFRL C	RAN ERG	e st	ONE FILL	PC LT	DATE AT	DRAHATI IO		OF MARKS
			NO. DEG.						01	rf	44	FT	тн '	н с	L 1H	5L	PI TH	NO, DEC	EA	EA.	0	я	CY	LBS	TYPE	EA	~	EASTH ROCK	* I ~		cr		C7 81		TYPE	EA	EA	(.)		PIEMA RICE
20+78,5		25.2 LT																							0													1		MEW CI GRATE TYPE D
20+89.2		22.¢ RT																1	1						٥													2		NEW CI GRATE TYPE D
21+91.1		10 0' RT	1 1		- 1		- 1											1	1							1			1	1							1	а		CHANGE ELVATION OF MH
21+67.1		19.5°LT											M 111		519										Ö											0.00			1	NEW CI GRATE TYPE D
22+11.0		38,0° RT	1 1																-	1					0							8.89						5		NEW PRC DEEP SUMP CB. C1 GRATE TYPE D
22+11 0 Z	22+40.6	38.0° RT- 26.1° RT		C6	ca		.				24	32				×		1	1									80.37				41,68								NEW 24" CPEP
22+40 5		28.1°RT	- 1														- 1		1	١,-					0.70			28.67				23.67				ļ.,		,		NEW PRC DEEP SUMP CS. C1 CRATE TYPE O
22+40 8 2	22142.5	26.1° AT - 18 C	- 1	св	ca						24	4				х				1					١			63.33				- 1					1 "	W.		
		LT		~	~		-	,			~	**						1		l												43.11					1			NEW 24" CPEP
22+42 8		18,0'LT "																	-	77					D			30.2		ш		30.2			1 "			٠.	le b	NEW PRC DEEP SUMP CB, C1 GRATE TYPE D
27+42 5 2	22+43.6	43 D'LT		CS	CB						36	26				×												45.62				37,4			1			10		NEW SE CPEP
22+43 6		40 0 LT																1	1		1	=			c		-	24,47				24.47	: 🕒		1			11		NEW PRO DL C1 DRATE TYPE C
22+43,6 2	22481.3	43.0° LT - 44.0° LT		CB	OUTLET						36	38				×		1										106.81				91.67		1	1			12		NEW 36° CPEP
22+81.3		44.0°LT																	1.		1				-1		- 1	18.41				16.41								
	22+73.3	38.0'RY-81.		1-407	OUTLET						12							1	1.			*****		at 101	MO 8 1 1	"						18.41.	LINE .					18		NEW 3F CHEPES
	22413.3	RT	1 1	Ce	OURLET						12															- 1									1	1	1	14		PROPERTY BOUNDARY, PLUG REMANDER OF P.
23+89.3		45.6° RT	LΙ																1.2	1 -						- 1		14,97				14.97					1	15		NEW 30" OPEPES
23+89.3 2	24+18.8	48 # RT - 40.0 RT	1 1	CS	OUTLET						30	30				×				1	- 77		1 6			1		149.21		1 "		122.26					1	18		NEW 30" CPEP
24+18.8		40.0° RT	1 1																	1	١,				0												1	17		NEW PRC DL CL GRATE TYPE C
24+18.6 2	24+53.5	40.0' RT - 18.0	<u>'</u>	ca	CS			-> 4791118 9				40				×				1	1	-	7	- 1	- 1	1		81.22				6L17					1	10		NEW 30° CPEP
24+53.5		18 0' FIT							41.0				***************************************							,			140	* 140 1	D.		*************	28.68			1	26.65						10		NEW PRC DEEP SUMP CO. C1 GRATE TYPE D
24+63 8 2	24+63.0	16 C RT - 17,	. [cs	СВ						24	38				×			1							- 1														
		LT	1 1	-		=					7.1	-				^		1		-	-	-					-	19,98				18.39			1	1	1	30	·	NEW 24" CPEP
726+53,0	- 1	17.7 LT	ΙI																	1					ο.			23.66		1		25.65	- 1	'"	1.1	1	1	21		NEW PRC DEEP SUMP CB, C1 GRATE TYPE D
26+07.5	_	15.0 RT	1 1			-		TOTAL CPER	P (SPNG)	24"	111	FT	_				_	+	+	-		1		-		-1-			+	1	-	-	+	+	+	\vdash	\vdash	22	\vdash	CHANGE ELEVATION OF MH
_	_				PKU	POS	ED:	TOTAL CPER	P (SINGL P (SINGL	30"	70 63	FT						4	_	↓_		_			_				4_			_							Ш	
22+11.0		35 O'RT																		x											8							1		REMOVE EXISTING CATCH BASIN
22+57.0		24.5°RT	1 1																	x "									1	1	6	- 1			1	l .	1	,		REMOVE EXISTING CATCH BASIN
222+64.8		17,8 LT	1 1																1	×	1	1 1							1	1	6		- 1			1		3		REMOVE EXISTING CATCH BABIN
222+54.9 2	22+81,8	17.3 LT									12	25			x											- 1		6.23									1	4		REMOVE EXISTING REINFORCED CONCRETE PH
222+81,8		17.4 LT	1 1		Û														1	×		1									8				.,	100		8		REMOVE EXISTING CATCH BASIN
222+57 0 2	22+79.4	29 4'RT- 39.2 RT									10	17								ř								4 89		1								١.		REMOVE EXISTING CLAY PIPE
		34.5 RT													****																1,000									
222+57.0 2	72+79.2	43.9 RT									24	27																13.15										7		REMOVE EXISTING CORRUGATED METAL PIPE
222+57.0 2	22+79.4	24 5 RT - 19.3' RT									13	27			×				1									24					- 1							REMOVE EXISTING REINFORCED CONCRETE PU
222+79 6		19.3YRT																		×	1										6							,		REMOVE EASYING CATCH BASIN
221+59:0 2	22+70.8	17.3 LT -									ы	32			x						1							10.67										10		REMOVE EXISTING REINFORCED CONCRETE PR
		48.8° LT 46.8° RT -										_																										10	1	NEWLYK ENBING PEINFORCED CONCRETE PI
223+86 3 2	24483.5	19.3° RT									30	63																129.48		1								111		REMOVE EXISTING CORRUGATED METAL PIPE
224+53.8		19.0' RT			~ [n # 1941					1 = 3	1	×.									1		1.6							12		REMOVE EXISTING CATCH BASIN
224+53.B 2	24+53.5	19 0° RT - 18. LT	r								15	36			×				1									22.89										13		REMOVE EXISTING REINFORCED CONCRETE PI
- 1	224.53.5						Ų													×				ļ,														l u		REMOVE EXISTING CATCH BASIN
								TOTAL RCP		12"	25	FT								$\overline{}$							-		_	_	1	\rightarrow	-		+	+	-	-	+	INCHES SAFETED OF TOTAL BASIN


PROJECT NUMBER: 8F 024I(58)

FILE NAME: 2191223drn.det.dgn
PROJECT LEADER: K, SMITH
DESIGNED BY: K, HO
DRAINAGE TABLES

PROJECT NAME: NORTHFIELD

PLOT DATE: 5/29/2025 DRAWN BY: J. DIAZ CHECKED BY: C. JENNE SHEET 31 OF 102

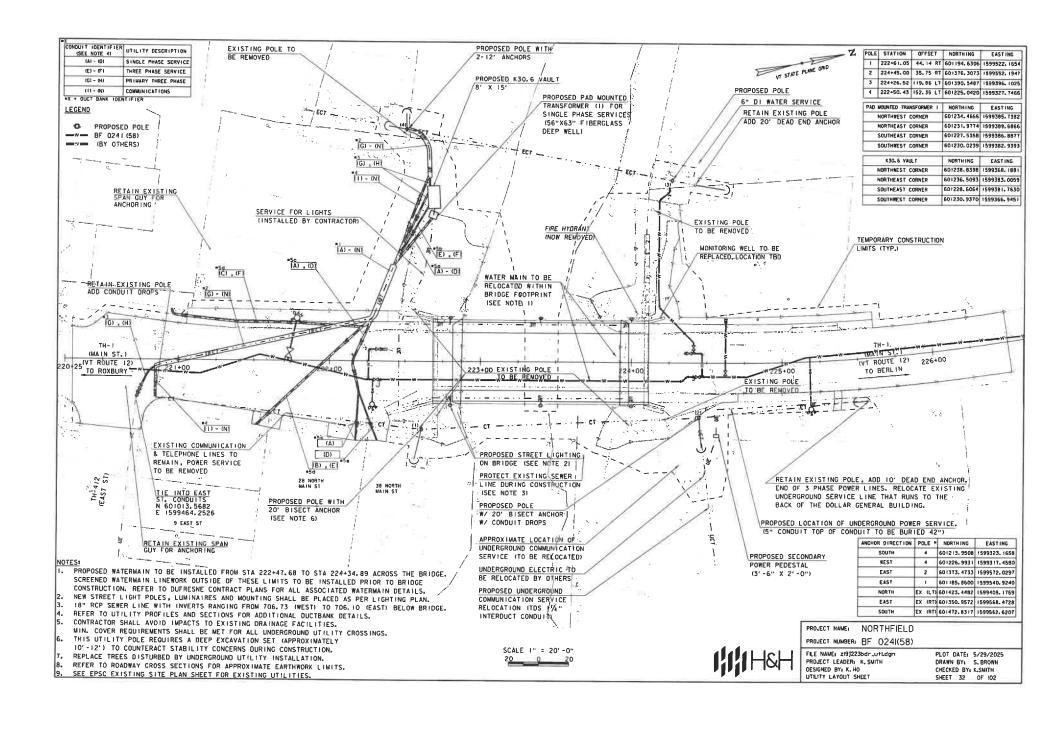

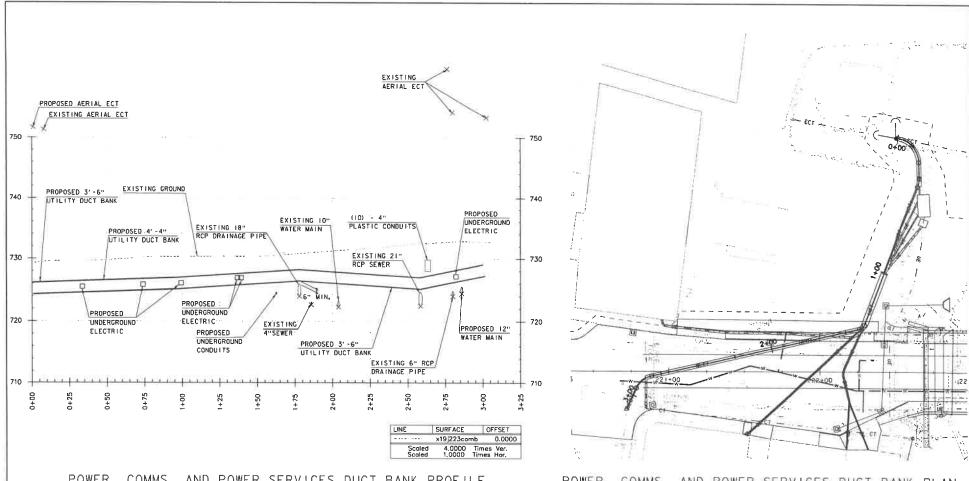

POWER, COMMS, AND POWER SERVICES DUCT BANK PROFILE

POWER, COMMS, AND POWER SERVICES DUCT BANK PLAN



NOTES:

1. INVERTS SHOWN FOR EXISTING UTILITIES ARE ASSUMED BASED ON AVAILABLE INFORMATION. THE CONTRACTOR SHALL VERIFY THE POSITION OF ALL EXISTING UTILITIES.


2. PROPOSED UTILITY DUCT BANKS SHALL MAINTAIN 18" MINIMUM VERTICAL CLEARANCE FROM EXISTING UNDERGROUND UTILITIES UNLESS OTHERWISE SHOWN. COCATIONS WITH LESS THAN 18" VERTICAL CLEARANCE HAVE BEEN AGREED UPON BETWEEN VTRANS, GMP. NED AND THE TOWN OF NORTHFIELD.




PROJECT NAME: NORTHFIELD PROJECT NUMBER: BF 0241(58)

FILE NAME: zi9j223u+l_pro.dgn PROJECT LEADER: K. SMITH DESIGNED BY: K. HO UTILITY DUCT BANK PLAN & PROFILE -

PLOT DATE: 5/29/2025 DRAWN BY: J. DIAZ CHECKED BY: C. JENNE SHEET 33 OF IO2

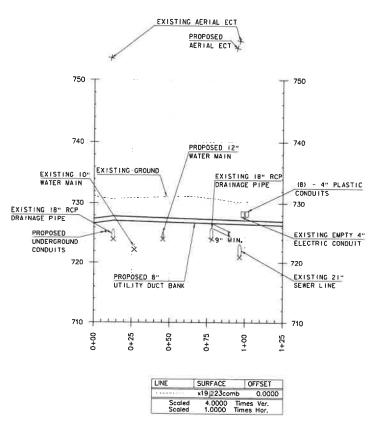

2 - 4" POWER SERVICE DUCT BANK PROFILE

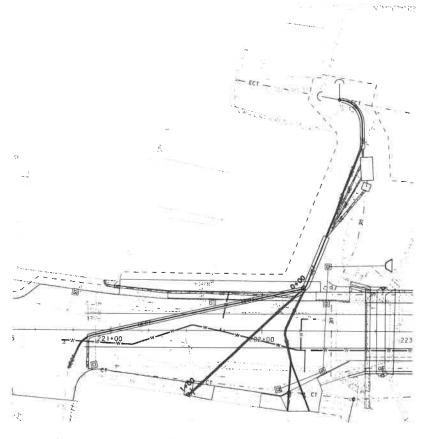

I - 4" POWER SERVICE DUCT BANK PLAN

SCALE 1" = 20'-0" 20 0 20

NOTES:

1. INVERTS SHOWN FOR EXISTING UTILITIES ARE ASSUMED BASED ON AVAILABLE INFORMATION. THE CONTRACTOR SHALL VERIFY THE POSITION OF ALL EXISTING UTILITIES.


2. PROPOSED UTILITY DUCT BANKS SHALL MAINTAIN 18" MINIMUM VERTICAL CLEARANCE FROM EXISTING UNDERGROUND UTILITIES UNLESS OTHERWISES SHOWN, LOCATIONS WITH LESS THAN 18" VERTICAL, CLEARANCE HAVE BEEN AGREED UPON BETWEEN VIRANS, GUP, NED AND THE TOWN OF NORTHFIELD.





PROJECT NAME: NORTHFIELD PROJECT NUMBER: BF 0241(58)

FILE NAME: 219)223u11_pro.dgn
PROJECT LEADER: K, SMITH
DESIGNED BY: K, HO
UTILITY DUCT BANK PLAN & PROFILE = 2

PLOT DATE: 5/29/2025 DRAWN BY: J. DIAZ CHECKED BY: C. JENNE SHEET 34 OF 102

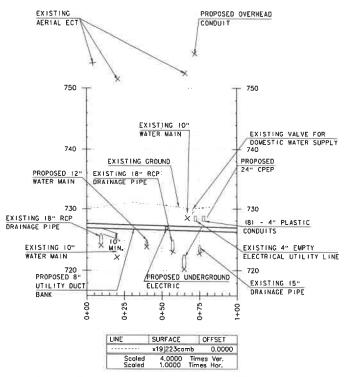

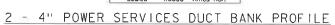

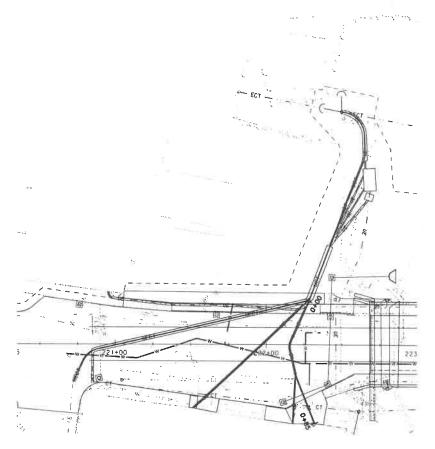

2 - 4" POWER SERVICES DUCT BANK PLAN



NOTES:


1. INVERTS SHOWN FOR EXISTING UTILITIES ARE ASSUMED BASED ON AVAILABLE INFORMATION. THE CONTRACTOR SHALL VERIFY THE POSITION OF ALL EXISTING UTILITIES.


2. PROPOSED UTILITY DUCT BANKS SHALL MAINTAIN 18" MINIMUM VERTICAL CLEARANCE FROM EXISTING UNDERGROUND UTILITIES UNLESS OTHERWISE SHOWN. LOCATIONS WITH LESS THAN 18" VERTICAL CLEARANCE HAVE BEEN AGREED UPON BETWEEN VTRANS, GMP, NED AND THE TOWN OF NORTHFIELD.





PROJECT NAME: NORTHFIELD PROJECT NUMBER: BF 0241(58)

FILE NAME: zi9)223utl_pro.dgn PROJECT LEADER: K. SMITH
DESIGNED BY: K. HO
UTILITY DUCT BANK PLAN & PROFILE - 3 PLOT DATE: 5/29/2025 DRAWN BY: J. DIAZ CHECKED BY: C. JENNE

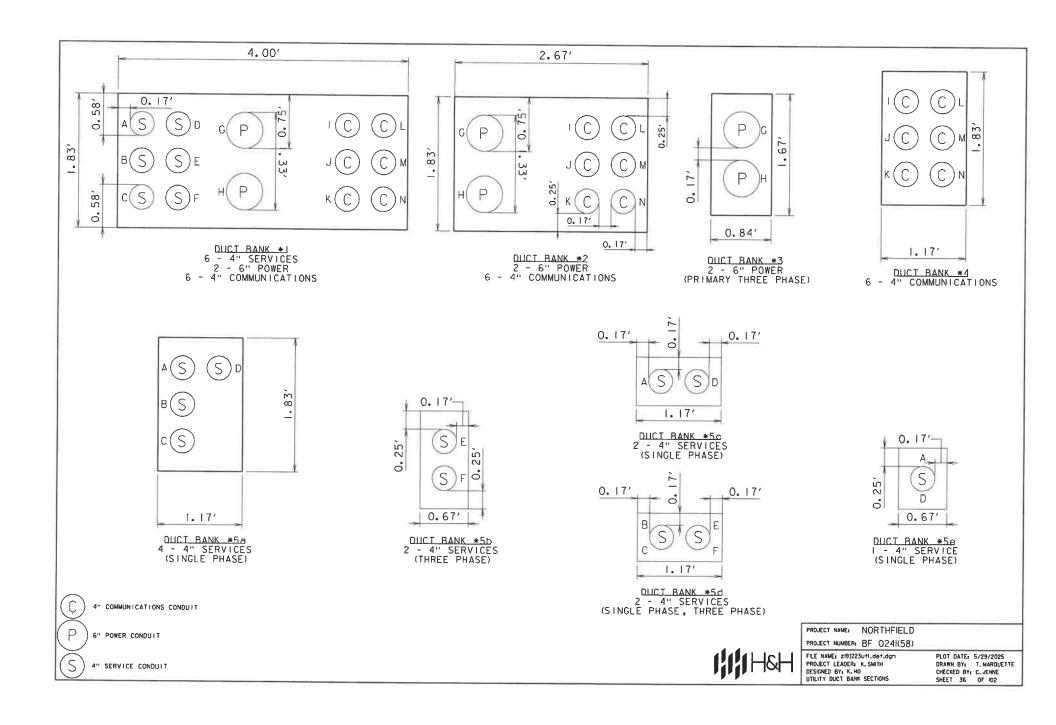

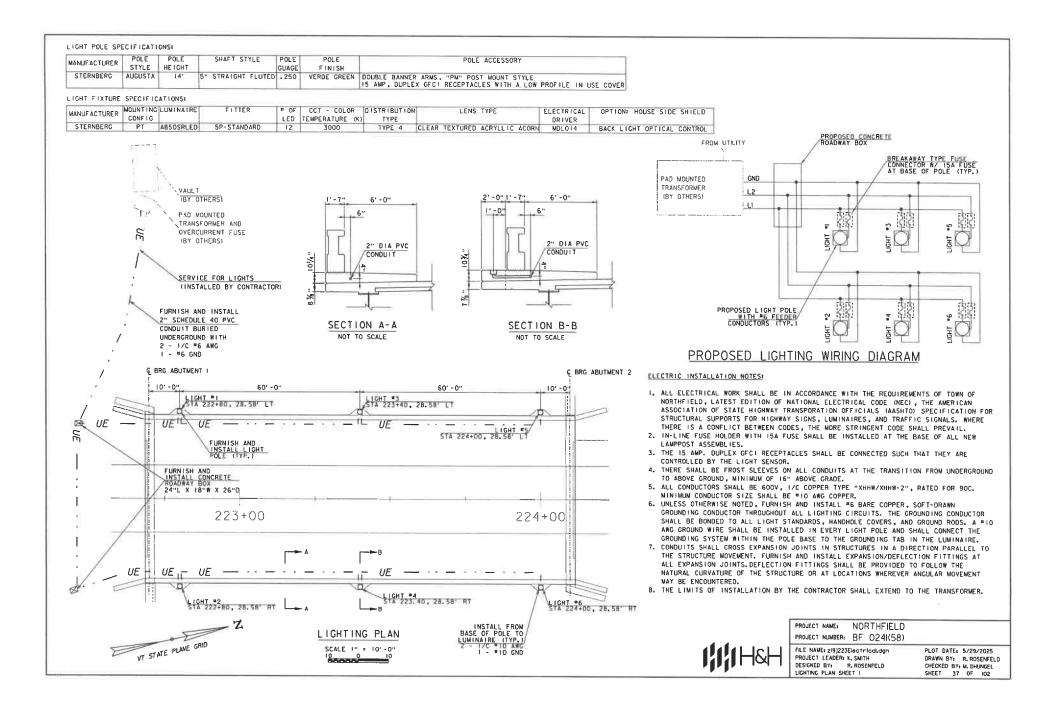


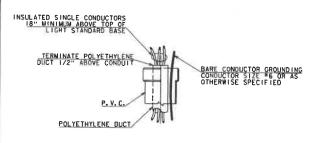


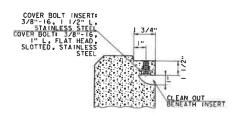

CABLE IN DUCT TERMINATION _AT LIGHT STANDARD BASE


THREADED INSERT

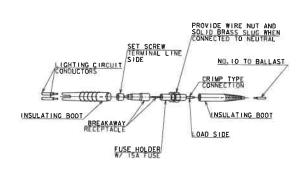

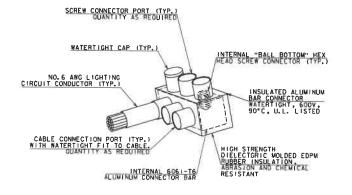

BREAKAWAY FUSE CONNECTOR

WATERTIGHT CONNECTOR

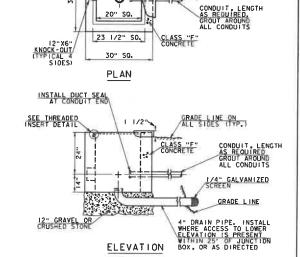

⊕⊫

COVER PLATE


CONCRETE JUNCTION BOX




THREADED

PROJECT NAME: NORTHFIELD
PROJECT NUMBER: BF 024I(58)

FILE NAME: zi9J223Electrical.dgn PROJECT LEADER: K, SMITH DESIGNED BY: R, ROSENFELD LIGHTING PLAN SHEET 2 PLOT DATE: 5/29/2025 ORAWN BY: R. ROSENFELD CHECKED BY: M. DHUNGEL SHEET 38 OF 102

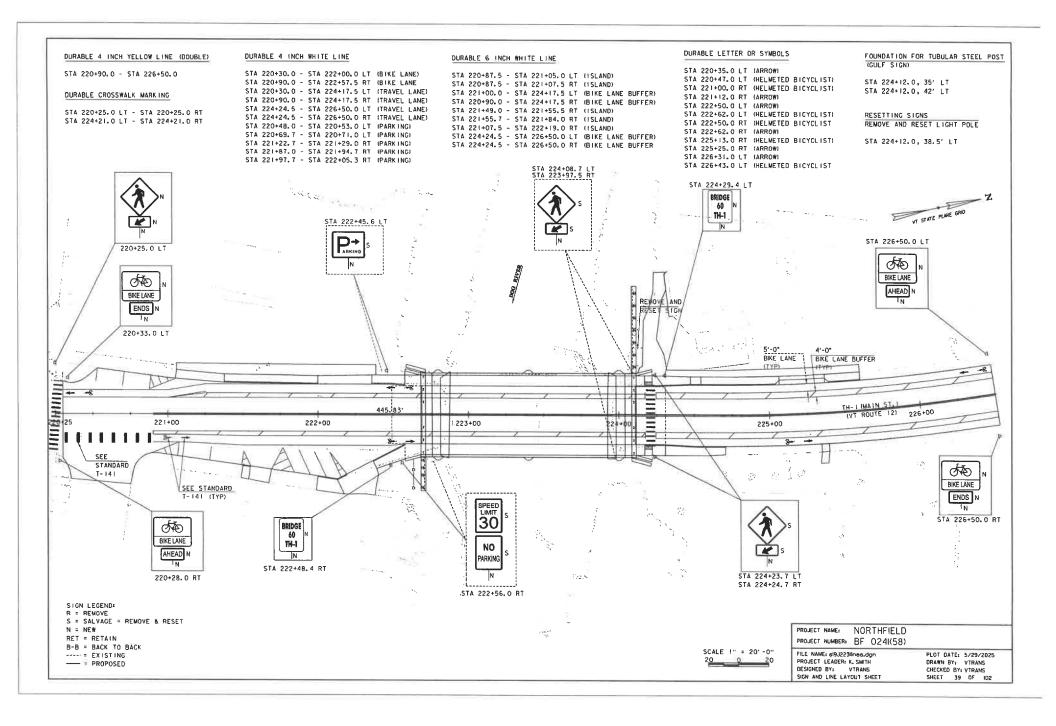

BLOCK PATTERN CROSWALK PAVEMENT MARKING DETAILS

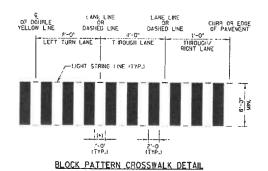

OF DOUBLE CANE LINE LANE LINE OF PAVEMENT PO ASSED LINE OF PAVEMENT RIGHT LANE THROUGH LANE TYP.)

SKEWED BLOCK PATTERN CROSSWALK DETAIL MAY VARY WITH 1'-0" OR 12'-0" LANE

NOTES

- 1. THIS DETAIL IS CONFIGURED FOR AN 1'-0' LANE.
- 2. MARK LIGHT STRING LINE ON PAVEMENT ACROSS ROADWAY ICURB-TO-CURBI.
- 3. ESTABLISH THE CENTER LINE OF THE ROADWAY IDOUBLE YELLOW LINE OR LANE LINES.
- BLOCKS ARE PARALLEL TO THE CENTERLINE (DOUBLE YELLOW LINE OR LANE LINE). (OFFSET BLOCKS VERTICALLY TO ACHIEVE REQUIRED SKEW).
- 5. ALWAYS START MEASURING FROM THE CENTERLINE OR LANE LINE RIGHT WITH THE FLOW OF TRAFFIC.
- 6. PAINTED BLOCKS SHALL BE Z'-0" (TYPICAL), (OPTION ITEM)
- IN 7. THIS SPACING WILL INCREASE TO 2'-0" FOR A 12"-0" LANE.
- (+) 8. ADJUST SPACING TO AVOID WHEEL PATHS AS DIRECTED BY THE ENGINEER.

PROJECT NAME: NORTHFIELD PROJECT NUMBER: BF 0241(58)

FILE NAME: SIGJ223,DGN
PROJECT LEADER: C. BAKER
DESIGNED BY: VTRANS
CROSSWALK DETAILS

PLOT DATE: 5/29/2025 DRAWN BY: VTRANS CHECKED BY: VTRANS SHEET 40 OF 102

	OF VERMONT FTRANSPORTATION								T	R	A	FI	=	C	S		16	1	SI	UI			١F	Y	' §	3F	ΙE	E	T						
		SIGN	MENS	ONS	NEW	& SALV	AGED S	IGNS	EXIS POS	T NO	FLA	NGED C	HANNEI		s	JUARE S	NEEL (i	n)	TU	NEW BULARAI Ø (II)		_	TUB	ULARS	TEEL			W-SH	APE ST	TEEL				BIGN	DETAIL
ILE MARKER. ATION OR SIGN NUMBER	SIGN LEGEND	ω	IDTH F	Eickiii (In)	- A-	-B-	SALV	SALV	RETAIN		ŀ	(LB / F			(LB /	FT)	- GHONA		1,3	(LB / I	T)	OUNDATIO	7.60	3.50 (LB	4.00 /FT) 10.80	5,00	FTG.	\$LZE 30*	WEIGHT	POST SIZE	SIGN FRAME		REMARKS	DETAIL ON SHEET NUMBER	ORFH
STA 220+25.0 LT	\wedge	1	30.0	30.0	9.0					12			Ī	Ī	12	.0	,		PTION	ITEMS											T				
STA 224+23.7 LT 'A 224+23.7 RT	$\langle y \rangle$	2	30.0	30,0	18,0					2.					24	.0	,	,														BLA	CK ON FLUORESCENT YELLOW-GREEN		WL
STA 220+25.0 LT		1	24.0	12.0	2.0					Ì								P	AIRED V	/TH NEW	W11-2 S	GN LISTE	D ABOV	E											
STA 224+23.7 LT TA 224+23.7 RT	K	2	24.0	12.0	4.0													PA	RED W	THEXIST	NG W11-	2 SIGN LI	STABON	Æ									CK ON FLUGRESCENT YELLOW-GREEN		WIE
STA 222+45.6 LT	P→ ARKING	1	30.0	24.0	5,0					1.	D				15	.0	,	· ·															GREEN ON WHITE		MU D
A 222+56.0 RT	SPEED LIMIT 30	1	24,0	30,0	6.0					1.	0				12	0.0	,	,															BLACK ON WHITE		MU R:
A 222+56,0 RT	NO PARKING	1	24,0	30.0	5.0											-		PAI	RED WI	THEXIST	NG R2-1	SIGN LIST	ED ABO	VE.									RED ON WHITE		ML
222+48.4 RT	BRIDGE	1	6.0	19.0	0.4					1.	0				12	2.0	,	ĸ	ľ														WHITE ON GREEN	T-42	
224+29.4 LT	60 TH-1	1	6.0	10.0	0,4					1.	a				12	.0	,	c .															WHITE ON GREEN	T-42	
ST SIZES ARE COM	ARE TO SE DETERMINED IN THE FIELD. IPUTED BASED ON INFORMATION TANDARD SHEETS AND THE VITRANS SUDDELINE:		TOTALS		SF	SF	EA.	6F			FT	Y				7. F		E	A L	B LE	-	EA.	LB		LB B	LB	EA.	EA.	LB						


SIGN LEGEND:
R = REMOVE
S = SALVAGE = REMOVE & RESET
N = NEW
RET = RETAIN
B-B = BACK TO BACK
----- EXISTING
= PROPOSED


PROJECT NAME: NORTHFIELD

PROJECT NUMBER: BF 0241(58)

FILE NAME: 21912223sgn.dgn
PROJECT LEADER: K. SMITH
DESIGNED BY: K. HO
SIGN AND LINE TABLE SHEET

PLOT DATE: 5/29/2025 DRAWN BYI S. TANG CHECKED BY: C. JENNE SHEET 41 OF 102

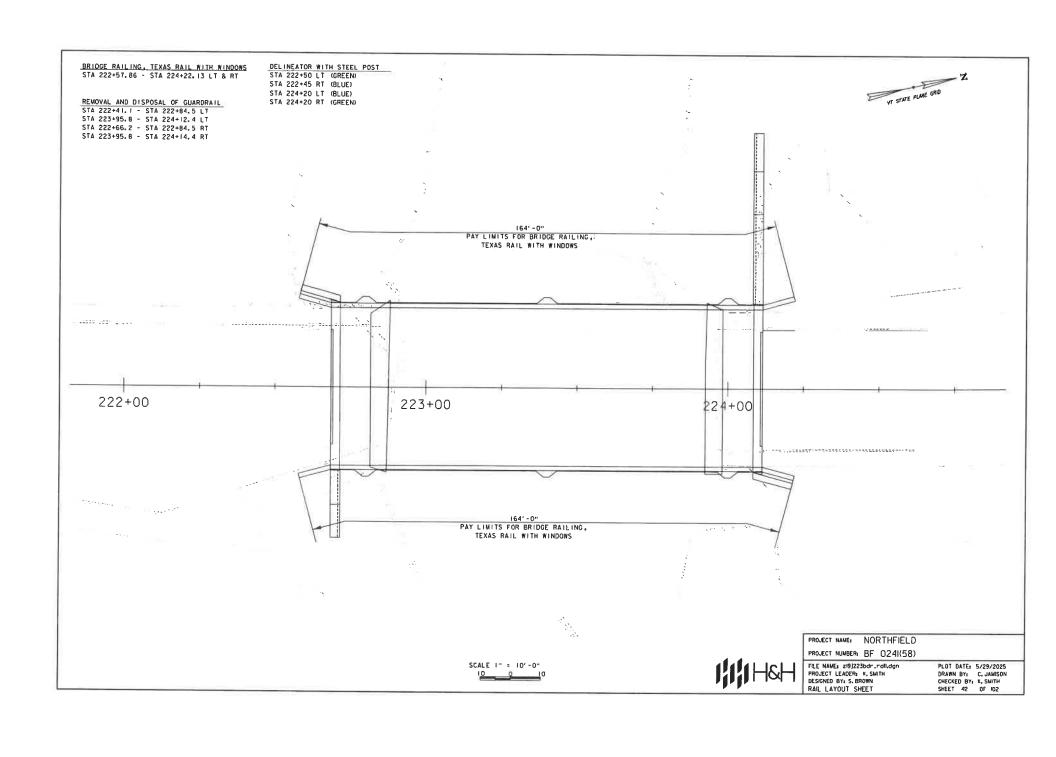

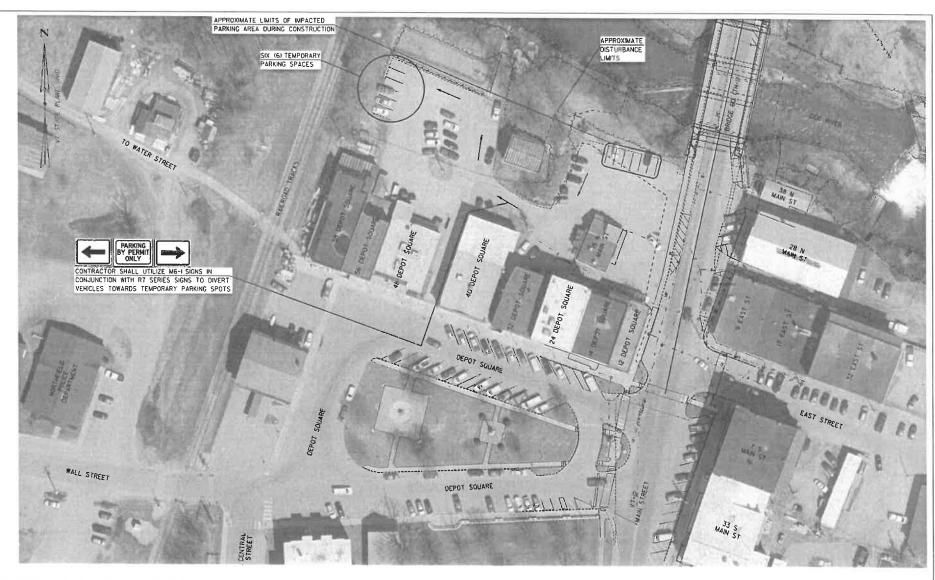

NOTE

I. TEMPORARY PARKING LAYOUT SHALL BE IN PLACE FOR DURATION OF WORK ASSOCIATED WITH UTILITIES RELOCATION AND BRIDGE REPLACEMENT.

2. LAYOUT OF SIGNAGE AND PERMIT PARKING AS SHOWN IS SCHEMATIC AND SHALL BE COORDINATED WITH THE TOWN OF NORTHFIELD.

3. COSTS FOR TEMPORARY SIGNING AND STRIPING AS SHOWN SHALL BE INCLUDED UNDER PAY ITEM 641,1000 - TRAFFIC CONTROL.

SCALE I" = 30'-0" 30 30 PROJECT NAME: NORTHFIELD
PROJECT NUMBER: BF 0241(58)

FILE NAME: SI9J223†parking.dgn PROJECT LEADER: K, SMITH DESIGNED BY: K, HO TEMPORARY PARKING LAYOUT

PLOT DATE: 5/29/2025 DRAWN BY: J. DIAZ CHECKED BY: C. JENNE SHEET 43 OF 102

SOIL CLASSIFICATION

AASHTO

- Gravel and Sand Fine Sand Silty or Clayey Gravel and Sand Silty Soil Low Compressibility Silty Soil Mighly Compressible Clayey Soil Low Compressibility Clayey Soil Highly Compressible

ROCK QUALITY DESIGNATION

R.O.D. (2)	ROCK DESCRIPTION
₹25	Very Poor
25 to 50	Poor
51 to 75	Fair
76 to 90	Good
>90	Excellent

SHEAR STRENGTH

LINDRAINED	=
SHEAR STRENGTH	
MPEE	

CONSISTENCY N P.S.F. <250 Very Soft Soft Med. Stiff Stiff 250-500 500-1000 1000-2000 2000-4000 Very Stiff

CORRELATION GUIDE OF "N" TO DENSITY/CONSISTENCY

	DENSITY LULAR SOILS)		NSISTENCY ESIVE SOILS)
N	DESCRIPTIVE TERM	N	DESCRIPTIVE TERM
5-10 II-24 25-50 >50	Very Loose Loose Med. Dense Dense Very Dense	<2 2-4 5-8 9-15 16-30 31-60 >60	Very Soft Soft Med. Stiff Stiff Very Stiff Hord Very Hard

ngrapon Ledge No Ledge To Depth Can Not Penatrate Further Top of Ledge Or Boulder No Recovery Le NLTD CNPF TLOB NR Rec.


XRec. ROD CBR

Recovery
Percent Recovery
Rock Quality Designotion
California Bearing Ratio
Less Than
Greater Than R Refusal IN > IODI VTSPG NAD83 - See Nate 7

COLOR Black Blue Brown Dark Groy Green Light Orange Pink bi brn dk gry gn it or rd tn wh yel mitc Purple Red Tan White Multicolored

COMMONLY USED SYMBOLS

•	Water Elevation
ė	
0	Standard Penetration Boring Auger Boring
0	Rod Sounding
S	Sample
N	Standard Penetration Test
	Blow Count Per Foot For:
	2"O.D. Sampler
	1 3/4" I. D. Sampler
	Hammer Weight Of 140 Lbs.
	Hammer Fall Of 30"
٧S	Fleid Vane Shear Test
ÚŠ	Undisturbed Soll Sample
В	Biost
DC	Diamond Core
MD	Mud Drill
WA	Wash Ahead
HSA	Hollow Stem Auger
AX	Core Size II/2
BX	Core Size 1%*
NX	Core Size 2 /a"
M	Double Tube Core Bornel Used
ĹL	Liquid Limit
PL	Plastic Limit
PI	Plasticity Index
NP	Non Plastic
w	Moisture Content (Dry Wgt. Bosis)
D	Ory
M	Molst
MT₩	Moist To Wet
₩	Wet
Sat	Saturated
Во	Boulder
Gr-	Gravel
Sa	Sand
12	Sfit
CI	Clay
HP	Hardpan

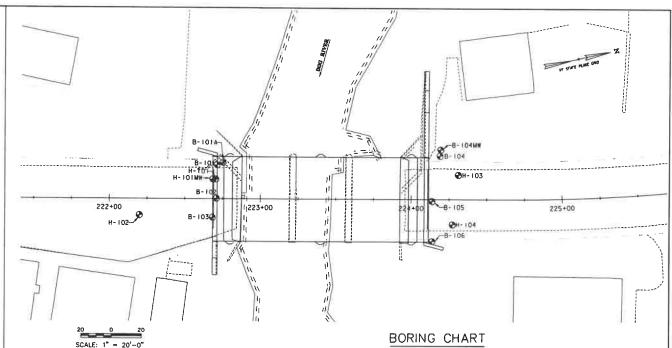

NORTHING	EASTING	STATION	OFFSET	ELEV TLOB
601218.43	1599459,36	222+71,29	22.2' LT	
601222.65	1599458.73	222+75.29	23.7' LT	
601213.45	1599480.83	222+70.87	0.2' LT	698.5
601208,44	1599492.27	222+68.35	12.0' RT	700.3
601364,21	1599483.86	224+18.98	28.5' LT	701.6
601365.53	1599480.06	224+19.48	32,5' LT	
601352.94	1599511.91	224+13.78	L2' RT	704.7
601347.71	1599537.30	224+13.93	27.2' RT	706.0
	601218.43 601222.65 601213.45 601208.44 601364.21 601365.53 601352.94	601218.43 1599459.36 601222.65 1599458.73 601213.45 1599480.83 601208.44 1599492.27 601364.21 1599483.86 601365.53 1599480.06 601352.94 1599511.91	60/218.43 1599459.36 222+71,29 60/222.65 1599458.73 222+75.29 60/213.45 1599480.83 222+70,87 60/208.44 1599492.27 222+68.35 60/364.21 1599483.86 224+18.98 60/365.53 1599480.06 224+19.48 60/352.94 1599511.91 224+13.78	60128.43 1599459.36 222+71.29 22.2° LT 601222.65 1599458.73 222+75.29 23.7° LT 601213.45 1599480.83 222+70.87 0.2° LT 601208.44 1599492.27 222+68.35 12.0° RT 601364.21 1599483.86 224+18.98 28.5° LT 601365.53 1599480.06 224+19.48 32.5° LT 601352.94 159951.91 224+13.78 L2° RT

HOLE NO.	NORTHING	EASTING	STATION	OFFSET
H-IQI	601215.68	1599468.47	222+70.49	12.8' L T
H-IOIMW	601213.73	1599468.06	222+68.49	12.8' LT
H-I02	601161,44	1599480.88	222+20.01	10.6' RT
H-103	601373.36	1599498.83	224+31.03	15.8' LT
H-I04	60/363,07	1599529.46	224+27.33	16.3' RT

DEFINITIONS (AASHTO)

BEDROCK (LEDGE) - Rock In its notive location of indefinite thickness. BOULDER - A rock fragment with an overage dimension > 12 inches. COBBLE - Rock fragments with an average dimension between 3 and 12 inches.

GRAVEL - Rounded particles of rock < 3" and > 0.0787" ("10 sleve). SAND - Porticles of rock < 0.0787*
(*10 sieve) and > 0.0029*(*200 sieve).

SILT - Soli (0,0029" (#200 sleve), non or slightly plastic and exhibits no strength when air-dried.

CLAY - Fine grained soil, exhibits plasticity when moist and consider-able strength when air-dried.

VARVED - Alternote layers of slit and clay.

HARDPAN - Extremely dense soil, cemented layer, not softened when wet,

with wer, MUCK - Soft organic soil icontaining > 10% organic material, MOISTURE CONTENT - Weight of water divided by dry weight of soil. FLOWING SAND - Granular soil so saturated (loose) that it flows into drill cosing during extraction of wash rad.

STRIKE - Angle from magnetic north to line of intersection of bed with a horizontal plane. DIP - inclination of bed with a horizontal plane.

The subsurface explorations shown herein were made between 9/20/2021 and 9/28/2021 by New England Boring Contractors.

Soll and rock classifications, proper-ties and descriptions are based on engineering interpretation from available subsurface information by the Agency and may not necessarily reflect actual variations in sub-surface conditions that may be encountered between individual boring or sample locations.

3. Observed water levels and/or conditions indicated are as record-ed at the time of exploration and may vary according to the prevall-ing rainfall, methods of exploration and other factors.

GENERAL NOTES

4. Engineering judgment was exercised in preparing the subsurface information presented herein, analysis and interpretation of subsurface information presented and interpreted for Agency design and estimating ourposes. Presentation of the information in the Contract is intended to provide the Contractor access to the same data available to the Agency. The subsurface information is presented in good faith and is not intended as a substitute for personal investigation, independent interpretation, independent analysis or judgment by the Contractor.

5. Pictorial structure details shown an the boring plan layout or salls profile are for illustrative purposes only and may not accurately portray final contract details.

6. Terminology used on boring lags to describe the hardness, degree of weathering, and spacing of fractures, joints and other discontinuities in the bedrock is defined in the ASANTO Manualon Subsurface Investigations, 1988.


T. Northing and Easting coordinates are shown in Vermont State Plane Grid North American Datum 1983 in meters and survey feet.




PROJECT NAME: NORTHFIELD PROJECT NUMBER: BF 0241(58)

FILE NAME: zi91223bor.dan PROJECT LEADERS K. SMITH DESIGNED BY: S. BROWN BORING LAYOUT SHEET

PLOT DATE: 5/29/2025 DRAWN BY: S. BROWN CHECKED BY: K. SMITH SHEET 44 OF 102

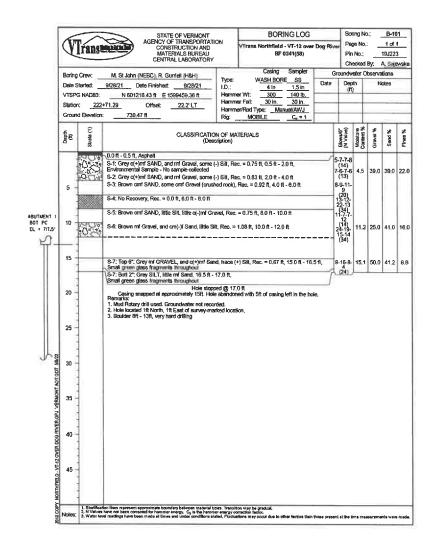

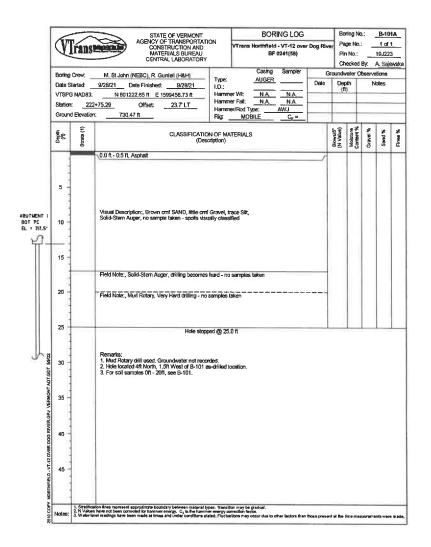




PROJECT NAME: NORTHFIELD
PROJECT NUMBER: BF 0241(58)

FILE NAME: z/9/223bor.dgn PROJECT LEADER: K. SMITH DESIGNED BY: R. GUARIELL BORING LOG SHEET I PLOT DATE: 5/29/2025
DRAWN BY: S. BROWN
CHECKED BY: K. SMITH
SHEET 45 OF 102

	V	Trans		STATE OF V AGENCY OF TRA CONSTRUC MATERIALS CENTRAL LA	INSPORTATION AND BUREAU	ON	VTrans No	BF (- VT-12 0241(56	over (Dog R	Iver Pi	oring N age No in No.: hecked	 	1 of 19,122 A Sa	1
	Dete VTSF Static	g Crew: Started: G NAD83: on: 222 nd Elevation	9/22/21 D N 6012 +70.87	13.45 ft E 1599480 Offset: 0.2	9/23/21	Type: I.D.: Hamm Hamm Hamm Rig:	w <u>A</u>		Samp E SS 1.5 i 140 30 in ual/AW	n b.	Date		water C		ations lotes	
	Depth	Strata (1)		CLASSIFICATI (Dec	ON OF MATE scription)	RIALS			Run (Dip deg.)	Core Rec. % (RQD %)	Drill Rate minutes/ft	Blows/6" (N Value)	Moisture Content %	Gravel %	Sand %	Fines %
T I .5'	5 - 10 -	¢Çe ≈¢	S-2: Grey cmf S-3: Brown on Environmental S-4: Brown/Gr Environmental	Concrete/Rebar of SAND, little ml Gra mental Sampte - No; SAND, little (+) cmf of SAND, little c(-)mf Sample - No sampte sy cmf SAND, little c Sample - No sampte vm c(+)m(-)! SAND,	sample collect Gravel, Rec. : Gravel, Rec. : collected imf Gravel, Re collected	ed = 0.67 ft, = 0.58 ft, ec, = 1.01	4.0 ft - 6.0 f 6.0 ft - 8.0 f ft, 8.0 ft - 10	nt nt, 0.0 ft,				10-10- 11-11 (21) 22-17- 9-46 (8) 3-3-3-4 (8) 10-9-6- (15) 9-3-6-6 (9)	6.9	15,0	59,0	21.
	15		S-6: Dark Brov 17.0 ft, Wood i	n omf SAND, some ragments present in	cm(+)f Grave sample	I, Rec. =	0.5 ft, 15.0 f	it -				3-3-4-7 (7)				
	20 -		(Confirmed by S-7: Grey/Blad Wood In tip of	, Orilled through larg wood stuck to casing k cm SAND, Rec. = 6 spoon. c. = 0.58 ft, 21.0 ft -	upon remove 0.17 ft, 20.0 ft	l)						50/2° (100) 9-7-12- 16 (19)				
	25 -		S-9: Grey mt G Wood fragmen	RAVEL, fittle omf Sa is present in sample	ind, Rec. ≃ 1.	33 ft, 25.	ว กิ - 27.0 กิ					6-6-3-4 (9)				
T.GOT 59/22	30 -	2572	30.0 H - 31,0 M	l"): Grey-Brown mf(+ 6"); Grey SILT trace				- 0				14-16- 16-15 (32)	31.3	1.0	2.0	97.0
DIGPL VERMONT ADTIGOT	35 -		32.0 ft, Approx 33.0 ft 30.0 ft	mate Top of Rock Grey PHYLLITE, mi lightly fractured, mod	oderalely to h	of the week	Hered	- /[-	C-1 (5-90)	91.7 (45)	6 4 4.5 12					
3	40		38.0 ft - 43.0 ft moderately frac 7+ pieces	Grey PHYLLITE, m lured, moderately so	oderately wea It to moderate	thered, ir ily hard n	itensely to ook, omf gra	ins, (C-2 (5-90)	91.7 (33.3)	3.5 7 6 6 6					
2010 COPY NORTHINELD - VT-12 OVER DOG	45 -	an e h	Remarks: 1, Mud Rotary of 2. Hole located 3. Lost water in 1 limit repeats any are not been correct readings have been	iril) used. Groundwat 0.5ft South, 2.5ft We	est of survey-r	marked ic	cation.				16					

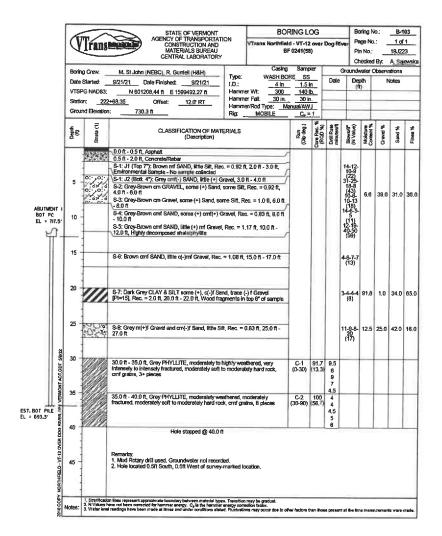



PROJECT NAME: NORTHFIELD PROJECT NUMBER: BF 0241(58)

FILE NAME: 219J223bor.dgn PROJECT LEADER: K, SMITH DESIGNED BY: R, GURRIELL BORING LOG SHEET 2 PLOT DATE: 5/29/2025 DRAWN BY: S. BROWN CHECKED BY: K. SMITH SHEET 46 OF 102

		Ų	rans		AGENCY C CON! MATI	TE OF VERMONT OF TRANSPORTATI STRUCTION AND ERIALS BUREAU RAL LABORATORY	ON	VTrans Northfield	NG LC 1 - VT-12 0241(58)	over I	Dog Ri	Par Pin	nng No ge No. i No.: ecked	: 	B-10 1 of 19,J22 A. Sare	13
	S V	Date S /TSPC Station	Crew; tarted: 6 NAD83: c: d Elevation:	9/24/21 N 601:	(NEBC), R. G Date Finished: 364.21 ft E 1 Offset:	9/24/21	Type: 1.D.: Hamm Hamm Hamm Rig:	er Fall: 30 in.	Sampl RE SS 1.5 ir 140 li 30 ln Inusl/AW. C _F =		Date 09/28/2	Dep (ft 1 18.6	th)	-	otes	gailbe
	1	9	Strata (1)		CLASSI	FICATION OF MATI (Description)	ERIALS		Run (Dip deg.)	Care Rec. % (ROD %)	Drill Rate mmutes/R	Blows/6" (N Value)	Mosture Content %	Gravel %	% pues	Fines %
ABUTMENT BOT PC EL = 716.	2	5	7.37.6 OO	S-2: Brown of S-3: SAME, I S-4: Brown of S-5: SAME, I S-6: Brown/G	mf SAND, son al Sample - No mf(+) SAND, I Rec. = 0.83 ft, mf SAND, son Rec. = 0.75 ft, stey mf Gravel - 12.0 ft, crum	ne (+) cmf Gravel, R 8.0 ft - 10.0 ft , some (+) Sitt, some	. = 0.83 f ec. = 0.7	1, 2.0 ft - 4.0 ft 5 ft, 6.0 ft - 8.0 ft				12-16- 12-10 (28) 10-10- 15-8 (25) 5-7-8-5 (15) 10-12- 12-13 (24) 9-10- 12-28 (22) 14-10- 21-50 (31)	8.9	47.0	20.0	33.0
		15 20 25		0.75 ft, 15.01 collected S-7: Jar B (8 S-8: Dark Bro Wood fragme S-9: Grey c(4 22.0 ft - 24.0	ft - 16.5 ft, Per oft, 3"): Black o own o(-)mif SAI ents throughou -)mif Sand, and ft	d (-) m(+)f Gravel, litt	ample - v 1 - 17.0 ft = 1.5 ft, 2 lie (+) Sili	0.0 ft - 22.0 ft, Rec. = 1.25 ft,				9-11- 42-6 (53) 2-4-5-8 (9) 9-9-11- 9 (20)	12.2	39.0	43.0	18,0
	59472	30		28 0 ft, Appro 29 0 ft - 34,0	ft - 27.0 ft, De namete Top of ft, Grey PHYL	D, some (+) c(-)mf C composed Rock Rock LUTE, moderately to ook, cmf grains, 7+ p	slightly w		C-1 (5-80)	100 (95)	5	15-26- 33-50 (59)				
BOT PILE 694.6"	R.GPJ VERNONT ADT	95 -		fractured, mo	fil, Grey PHYL iderately soft to sige quartz poo	LiTE, slightly weath o moderately hard ro cket	ered, moo ck, cmf g	derately to slightly rains, 6+ pieces.	C-2 (5-80)	86.7 (68.7	4.5 6.5 7					
	T-12 OVER DOC	40 45		Hole locate	y drill used. G ed 4ft North, 11	iole stopped @ 39.0 roundwater not recor ft West of survey-me North, 4ft West of B	rded. irked loca	tion. trifled location.		I	9					
	\$	otes:	1, Strettificati 2, N Values 3, Water levi	on lines represent have not been corr al readings have be	approximate boar ected for hammer sen made all times	dary between material by energy, C _g is the hamma a and under conditions sta	es, Transili er energy co led, Fluctus	on may be gradual. rraction factor. stions may occur due to o	other factors	then th	Ose pres	ent at the ti	me mai	sureme	nts were	made

		Ý	Trans		STATE OF VERMONT AGENCY OF TRANSPORTAT CONSTRUCTION AND MATERIALS BUREAU CENTRAL LABORATORY		VTrans Northfield	RING LO d - VT-12 0241(58	over (Dog Ri	ver Pa	ring N ge No 1 No.:	: -	B-1 1 of 19J22 A. Sai	1 3
	1	Borin	g Crew:	M. St John	(NEBC), R. Gurriell (H&H)		Casing	Sampl	er	_	Groundw		<u> </u>		
		Date	Started:	9/23/21	Date Finished: 9/23/21	Type;	WASH BO	RE SS 1.5 le	<u>.</u> [Date	Deg (ft		N	lotes	
	- 1	VTSF	G NAD83:	N 6013	352.94 ft E 1599511.91 ft	Hamm		1401			100	1			
	- 1	Statio		+13.78	Offset: 1,2 RT			30 tn				\exists			=
	J	Grout	nd Elevation:	729.	72 ft	Rig:	MOBILE	_C _F =	1						
		Depth (ft)	Strata (1)		CLASSIFICATION OF MAT (Description)	ERIALS		Run (Dip deg.)	Core Rec. % (RQD %)	Onk Rate minutes/ft	Blows/6" (N Value)	Moisture Coment %	Gravel %	Sand %	Fines %
		5	NO.	ft, 0.5 ft - 2.0 S-2: SAME, F	own mf Gravel, some (+) cm(-)f Si	and, some	Silt, Rec. = 1.17				41-50- 46-39 (96) 17-13- 10-6 (23) 6-2-5-2 (7) 7-8-5-9	2,5	23.0	33.0	24.0
	- 1		1 1	S-4: Grey cm	GRAVEL, little cmf Sand, Rec. =	0.33 ft, €	5.0 ft - 8,0 ft	1			7.6.5.9				
ABUTMEN BOT PO	: 11			S-5: Dark Bro 10.0 ft	own cmf SAND, little (+) cmf Grav	el, Rec. =	0.42 ft, 9.0 ft -				(11) 3-4-7-				
EL . N	2	10		S-6: Grey o(-) 10.0 ft - 12.0)mf GRAVEL, trace cmf Sand, tra fl, Crumbled Rock	ce (-) Silt,	Rec. = 1,08 ft,				(††) 11-11- 11-15 (22)				
		15 -		S-7: Grev om	f GRAVEL, little Sift, trace f Sand	Rec = D	58 1508-170				250				
				fl, Crumbled	Rock		511, 10.0 K - 17,0				3-5-8- 20 (13)				
		20		S-8: Grey cm	f(+) SAND, trace cmil Gravel, Rec al Sample - No sample collected	. = 0.67 fi	l, 20.0 ft - 22.0 ft,				6-4-5-4 (9)				
			٠Ç. ٠,		sck mf(+) Gravel, and (-) cm(-)f Si	and, some	(-) Silt, Rec. =				3-10- 16-23 (26)	12.4	44.0	35.0	21.0
	22/65	25		25.0 ft - 30.0 slightly fractu	ft, Grey PHYLLITE, moderately w red, moderately soft rock, cmf gra	eathered, ins, 5+ ph	moderalely to eces	C-1 (5-90)	91,7 (45)	3 3 3 6 5					
51, BOT PLE . • 699.0°	AOTGET	30		30.0 ft - 35.0 fractured, mo	ft, Grey PHYLLITE, moderately widerately soft rock, cmf grains, 5+	eathered, pieces	moderalely	C-2 (5-90)	100 (58.3	5.5					
	SWO.	35	WILL ST		Hole stopped @ 35.0					4.5		_	_		
	NORTHRELD - VT-12 OVER COG RIVER,GPJ VERMONT	40		Hole locate	y drill used. Groundwater not reco ed 3,5ft North of survey-marked for maintain seel at bottom of casing,	rded.	roximately 750 gallo	ns of wate	er durin	ng rock	coring.				
	0 COPY NORTHRELD - VT-1:	45	1. fittelificati	ion lines represent	spprodimate boundary between material h	pes. Yransit	ion may be gradual.								
	임	Notes:	2. N Values 3. Weter less	have not been com at madicus, have he	soled for hummer energy. C ₀ is the herminen made at times and under conditions at	er energy co	strection factor.	-	-					-t	




PROJECT NAME: NORTHFIELD

PROJECT NUMBER: BF 024(58)
FILE NAME; z/9)2235or.dgn
PROJECT LEADER: K. SMITH
DESIGNED BY: R. CURRIELL
BORING LOG SHEET 3

PLOT DATE: 5/29/2025 DRAWN BY: 5. BROWN CHECKED BY: K. SMITH SHEET 47 DF 102

V	Trans		AGENCY O CONS MATE	F TRANSPORTA TRUCTION AND TRIALS BUREAU		VTrans Northfie	ld - VT-12	2 over	Dog R	lver Pi	age No in No.:	-	1 of 19J22 A. Sa	1 23
Date: /TSP Statio	Started: G NAD83: In:224	9/20/21 D N 6013 +13,93	Note Finished: 47.71 ft E 1: Offset:	9/20/21	Hamm	WASH BC 4 in er Wt: 300 er Fall: 30 in.	1.5 140 30 i	in lb. r.	_	Ground	water (Observ	ations	
g	Strate (1)		CLASSIF	CATION OF MA (Description)	TERIALS		Run (Dip deg.)	CROD %)	Drill Rate minutes/ft	Blows/6" (N Value)	Moislure Content %	Gravel %	Sand %	Fines %
5 -	*00°	S-2: Brown of S-2: Brown of S-4: Grey cmt- ft - 6.0 ft S-4: Grey cmt- ft - 6.0 ft S-5: Grey cmt- ft - 10.0 ft S-6: TarvDark	environmental if SAND, little Environmental if SAND, som if SAND, som if SAND, som if SAND, som Brown o(-)mf	Sample - no samp orn' Gravel, grass Sample - no samp ne (+) f Gravel, littl ne (+) f Gravel, littl ne (+) f Gravel, littl	ole taken /organics, l ole taken e (+) Silt, F e (+) Silt, F e (+) Silt, F	Rec. = 0.42 ft, Rec. = 1.0 ft, 4.0 Rec. = 1.17 ft, 6.0 Rec. = 0.5 ft, 8.0				4-8-13 17 (19) 15-12- 9-7 (21) 9-8-6 (12) 6-7-11- 7 (18) 8-10- (16) 8-10- (20)	6.2	32.0	50.0	18.
15 -	??;??; ??;??;	S-7: Brown f S 17.0 ft	AND, some Si	it, trace (-) f Grav	el, Rec. = 0	1.75 ft, 15.0 ft -				6-8-9- 11 (17)	17.4	1.0	73.0	26.
	o: ,o: (,o:	22.0 ft, Large v Environmental S-9: Grey mf(+	wood fragment Sample - no s) Gravel, som monsed Rock	in center of sam; ample taken e (+) of Sand, son	wie ne Sint, Rec	. = 1.5 ft, 22.0 ft				4-3-1-1 (4) 4-12- 21- 60/3	10.6	40.0	32.0	28,0
4.4.4.4		25.0 ff - 30.0 ff moderately soft	, Grey PHYLL trock, mf grei	ITE, slightly weath 16, 12 pieces	nered mod	eralely fractured,	C-1 (30-90)	96.7 (63.3)	6.5 6					
100		30.0 ft - 35.0 ft moderately soft	, Grey PHYLL I rock, mf grair	ITE, slightly weath 18, 3+ pieces	ered, sligh	tly fractured,	C-2 (60)	100 (91.7)	7.5 8 8 7					
10 -		Remarks: 1. Mud Rotary a 2. Hole located	drill used. Gro						1.0					
	Dete Property Control of the Control	Soring Crew. John StatestTTSPG NADS: TSPG NADS: Station: 226 Secund Elevation 10 15 20 20 20 20 20 20 20 20 20 2	Soring Crew. M. St John 9/20/21 C 1/20/21 C	AGENICY OF CONS MATER CENTR CE	CONSTRUCTION AND MATERIAL S BUREAU CENTRAL LABORATOR MATERIALS BUREAU CENTRAL LABORATOR Date Started 9/20/21 Determined 9/20/21 TSPC NADS: N. 801347.71 ft E. 1996507.30 ft Station: 224+13,93 Offset 27.2 RT CASSIFICATION OF MA. (Description of Elevation: 729.97 ft CLASSIFICATION OF MA. (Description of Crase) Grand Off. 1. 20.11 (Provincemental Sample - no sample 1. 20.11 - 4.0 ft, Environmental Sample - no sample 1. 20.11 - 4.0 ft,	AGBECY OF TRANSPORTATION CONSTRUCTION AND MATERIALS BUREAU CENTRAL LABORATORY M. St. John (NEBC). R. Gurriell (HAH) Dete Startect 9/20/21 Dete Finished. 9/20/21 Hamm Hamm Right TYPO: 1.D.: Carriel, Right Typo: 1.D.: Carr	AGENOT OF TRANSPORTATION CONSTRUCTION AND MATERIALS BURREAU CENTRAL LABORATION? Deb Startect M. St. John (NEBC). R. Gurriell (H&H) MATERIALS BURREAU CENTRAL LABORATION? Deb Startect M. St. John (NEBC). R. Gurriell (H&H) MATERIALS BURREAU CENTRAL LABORATION OF MATERIALS Deb Startect M. St. John (NEBC). R. Gurriell (H&H) MATERIALS Deb Startect M. St. John (NEBC). R. Gurriell (H&H) MATERIALS Deb Startect M. St. John (NEBC). R. Gurriell (H&H) MATERIALS Deb Startect M. St. John (NEBC). R. Gurriell (H&H) MATERIALS Deb Startect M. St. John (NEBC). R. Gurriell (H&H) Hammer M. St. Grey Control (Mescaphical) St. Grey Control (Mescaphical). R. Gurriell (Mescaphical) St. Grey Control (Mescaphical). R. Gurriell (Mescaph	AGENOY OF TRANSPORTATION CONSTRUCTION AND MATERIALS BURREAU Typo: WASH BOCRE SE FORMANDAS: N 801347.71 ft E 199637.30 ft Harmore W. 1 in 1.5 Harmore W. 1 in 1.5 Harmore Fail: 30 in .	AGENCY OF TRANSPORTATION CONSTRUCTION AND MATERIALS BUREAU CENTRAL LABORATORY Dete Started M. St. John (NEBC). R. Gurriell (HAH) Dete Started M. St. John (NEBC). R. Gurriell (HAH) Dete Started M. St. John (NEBC). R. Gurriell (HAH) Dete Started M. St. John (NEBC). R. Gurriell (HAH) Dete Started M. St. John (NEBC). R. Gurriell (HAH) Dete Started M. St. John (NEBC). R. Gurriell (HAH) Dete Started M. St. John (NEBC). R. Gurriell (HAH) Dete Started M. St. John (NEBC). R. Gurriell (HAH) Dete Started M. St. John (NEBC). R. Gurriell (HAH) Dete Started M. St. John (NEBC). R. Gurriell (HAH) Dete Started M. St. John (NEBC). R. Gurriell (HAH) Dete Started M. St. John (NEBC). R. Gurriell (HAH) Dete Started M. St. John (NEBC). R. Gurriell (HAH) Dete Started M. St. John (NEBC). R. Gurriell (HAH) Dete Started M. St. John (NEBC). R. Gurriell (HAH) Dete Started M. St. John (MEDC). R. Gurriell (HAH) Dete Started M. St. John (MEDC). R. Gurriell (HAH) Dete M. John (MEDC). R. Gurriell (HAH) Dete Started M. John (MEDC). R. Gurriell (HAH) Dete M. John (MEDC). R. Gurriell (HAH) Dete Started M. John (MEDC). R. Gurriell (HAH) Dete M. John (MEDC). R. John (MEDC). Jo	AGENCY OF TRANSPORTATION CONSTRUCTION AND MATERIALS BUREAU CENTRAL JABORATIORY Date Started: M. St. John (NEBC) R. Gurriell (H&H) 920/21 Dete Findshed: 9/20/21 Type: WASH BORE SS. Dote Started: 9/20/21 Dete Findshed: 9/20/21 Type: WASH BORE SS. Dote Started: 9/20/21 Dete Findshed: 9/20/21 Type: WASH BORE SS. Dote 1/3	ASPINCY OF TRANSPORTATION AND MATERIALS BUREAU CONSTRUCTION AND MATERIALS BUREAU CONSTRUCTION AND MATERIALS BUREAU CONTROL ASSOCIATION AND MATERIALS NEEDED AND ASSOCIATION AND MATERIALS NEEDED AND ASSOCIATION AND MATERIALS CONTROL ASSOCIATION AND MATERIALS OF THE PROPERTY OF THE P	AGENCY OF TRANSPORTATION AND MATERIALS BUREAU CONSTRUCTION AND MATERIALS BUREAU CONTROL LABORATORY WASH BORE SET 10: 41 1.5: 51 Date Opph (II) MASH BORE SET 10: 41 1.5: 51 Date Opph (II) MASH BORE SET 10: 41 1.5: 51 Date Opph (II) MASH BORE SET 10: 41 1.5: 51 Date Opph (II) MASH BORE SET 10: 41 1.5: 51 Date Opph (II) MASH BORE SET 10: 41 1.5: 51 Date Opph (III) MASH BORE SET 10: 41 1.5: 51 Date Opph (III) MASH BORE SET 10: 41 1.5: 51 Date Opph (III) MASH BORE SET 10: 41 1.5: 51 Date Opph (III) MASH BORE SET 10: 41 1.5: 51 Date Opph (III) MASH BORE SET 10: 41 1.5: 51 Date Opph (III) MASH BORE SET 10: 41 1.5: 51 Date Opph (III) MASH BORE SET 10: 41 1.5: 51 Date Opph (III) MASH BORE SET 10: 41 1.5: 51 Date Opph (III) MASH BORE SET 10: 41 1.5: 51 Date Opph (III) MASH BORE SET 10: 41 1.5: 51 Date Opph (III) MASH BORE SET 10: 41 1.5: 51 Date Opph (III) MASH BORE SET 10: 41 1.5: 51 Date Opph (III) MASH BORE SET 10: 41 1.5: 51 Date Opph (III) MASH BORE SET 10: 41 1.5: 51 Date Opph (III) MASH BORE SET 10: 41 1.5: 51 Date Opph (III) MASH BORE SET 10: 41 Date Opph (III) MASH BOR	AGENCY OF TRANSPORTATION CONSTRUCTION AND MATERIALS BURRAU CENTRAL LABORATORY CENTRAL LABORATORY CHARLES BURRAU CENTRAL LABORATORY CHARLES BURRAU CENTRAL LABORATORY CHARLES BURRAU CENTRAL LABORATORY CHARLES BURRAU CENTRAL LABORATORY CHARLES CREW CHARL	AGENCY OF TRANSPORTATION AND MATERIALS BURRAU CONSTRUCTION AND MATERIALS BURRAU CONTROL LABORATORY 19,22 (Thodod By Assistinct 19,22 (Thodod By Assistinct 19,22) Date Fireshed 19,20) Date Fireshed 19,20

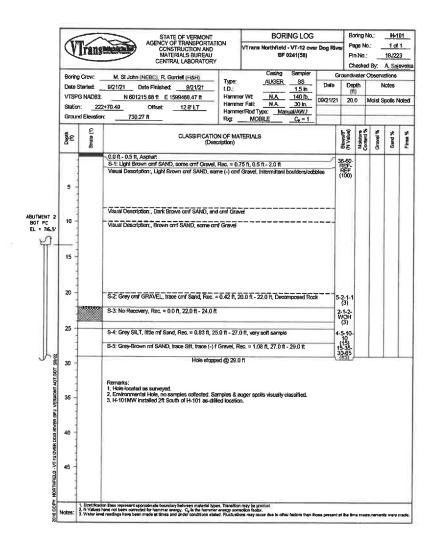




PROJECT NAME: NORTHFIELD PROJECT NUMBER: BF 0241(58)

FILE NAME: z/9/223bor.dgn PROJECT LEADER: K. SMITH DESIGNED BY: R. GURRIELL BORING LOG SHEET 4 PLOT DATE: 5/29/2025 DRAWN BY: S. BROWN CHECKED BY: K, SWITH SHEET 4B OF 102

ſ	Boring C	inew:	M, St John	(NEBC), R. G	Surriell (H&H)	Туре:		Casing		_	Groundw		_	A <u>. Saj</u> e ations	_
l	Date Sto			Oate Finished		1 I.D.:			1,5 in	Date	Dep (ft)	th	N	lotes	
ı	VTSPG Station:				1599480.88 ft	Horne	er Wt: er Fall;	N.A.	140 lb. 30 in.	09/22/2			Vloist S	poits N	lote
		Elevation:	730.	Offsel: 78 ft	10.6° RT	Harrom Rigg	er/Rod T MO		C _n = 1		1	-			
Ī	Septh (3)	Strate (1)			CLASSIFI	ICATION OF MA (Description)	ATERIAL	s			Blown/8" (N Value)	Moisture Content %	Gravel %	Sand %	1
ŀ		555	0.0 ft - 0.5 ft, 0.5 ft - 2.0 ft,							/					T
l	1	******			D, trace mt G	ravel, Rec. = 1.2	5 n , 201	R-4,0 R			25-30- 26-26				
l	5		S-2: Brown a	mf SAND, littl	e Silt, trace fil	Gravel, Rec. = 1.	.17 ft, 4.0	n - 6.0 ft			25-30- 28-26 (56) 11-21- 23-25 (44)				
l	T	ONO	Field Note:, C			ttle Sitt, trace f G	muni				(44)				
	10 -														
	15	299	Field Note:, B	louider											
	20					ec. = 1,25 ft, 20.					8-11- 14-16 (25)				
l			S-4: SAME, 2 SPT values o Rec. = 2.0 ft	orrelate to mi	it, Spoon over dafe 2ft (22.5	-driven to collect - 24.5)	extra so	lifor envin	mmental sam	ple.	14-20- 27-35				
١	25				Но	le stopped @ 25	.0 ft				4 (47)	_	-		-
SOURCEPT HORITIFIED : VI-12 OVER LOG RIVERGET VERSION (NO. 120) SWIZE	30 -		Remarks: 1. Hole locate 2. Environme	ed 0.5ft South intal Hole, no	of survey-ma samples colle	irked location. cted. Samples &	auger sp	ooils visua	ly classified.						
AGL A MINISTER	35														
VER USG RIVER	40														
VF-120	45														

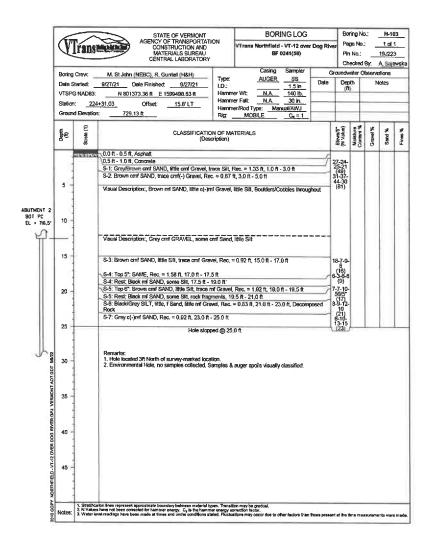


1111H&H

PROJECT NAME: NORTHFIELD
PROJECT NUMBER: BF 0241(58)

FILE NAME: ZISJ223bor.dgn PROJECT LEADER: K, SMITH DESIGNED BY: R. GURRIELL BORING LOG SHEET 5


PLOT DATE: 5/29/2025 DRAWN BY: S. BROWN CHECKED BY: K, SMITH SHEET 49 OF 102

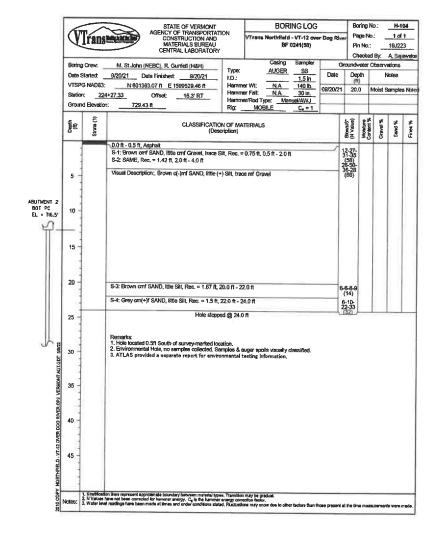

1111H&H

PROJECT NAME: NORTHFIELD
PROJECT NUMBER: BF 0241(58)

FILE NAME: z19)223bor.dgn PROJECT LEADER: K. SMITH DESIGNED BY: R. GURRIELL BORING LOG SHEET 6 PLOT DATE: 5/29/2025 DRAWN BY: S. BROWN CHECKED BY: K. SMITH SHEET 50 OF 102

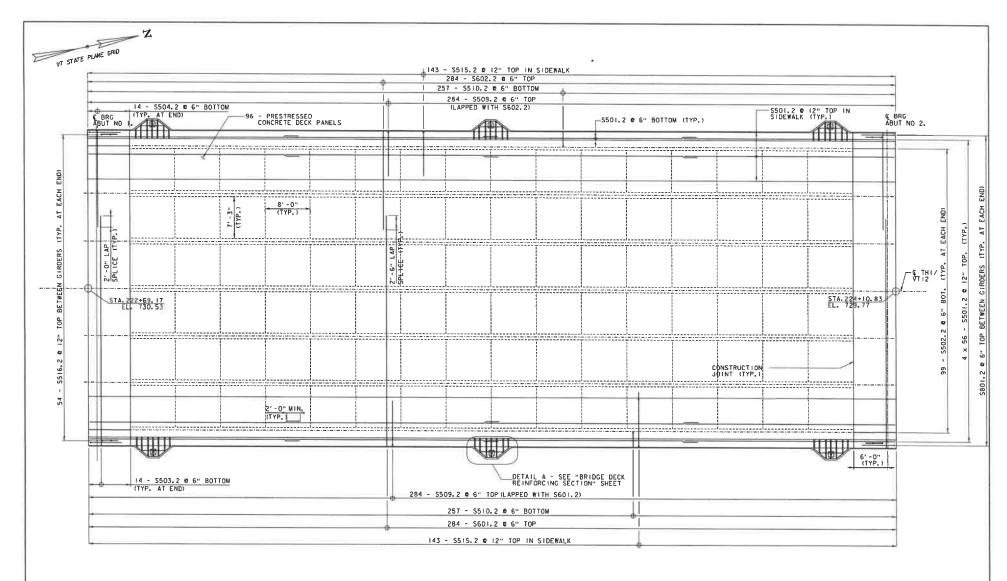

NOTES:

1. BRIDGE RALL REINFORCEMENT NOT SHOWN FOR CLARITY. SEE "BRIDGE RAILING DETAILS I" AND "BRIDGE RAILING DETAILS 2" FOR BRIDGE RAIL REINFORCEMENT DETAILS.

 SEE "ABUTMENT I REINFORCEMENT" AND "ABUTMENT 2 REINFORCEMENT" FOR STEM REINFORCEMENT DETAILS. DECK REINFORCEMENT PLAN


SCALE: %"=1'0"




PROJECT NAME: NORTHFIELD
PROJECT NUMBER: BF 0241(58)

FILE NAME: ZIBJ2236UD.dgn PROJECT LEADER: K. SMITH DESIGNED BY: N. BOB BRIDGE DECK PLAN

PLOT DATE: 5/29/2025 DRAWN BY: C. JAMISON CHECKED BY: K. SMITH SHEET SI OF 102

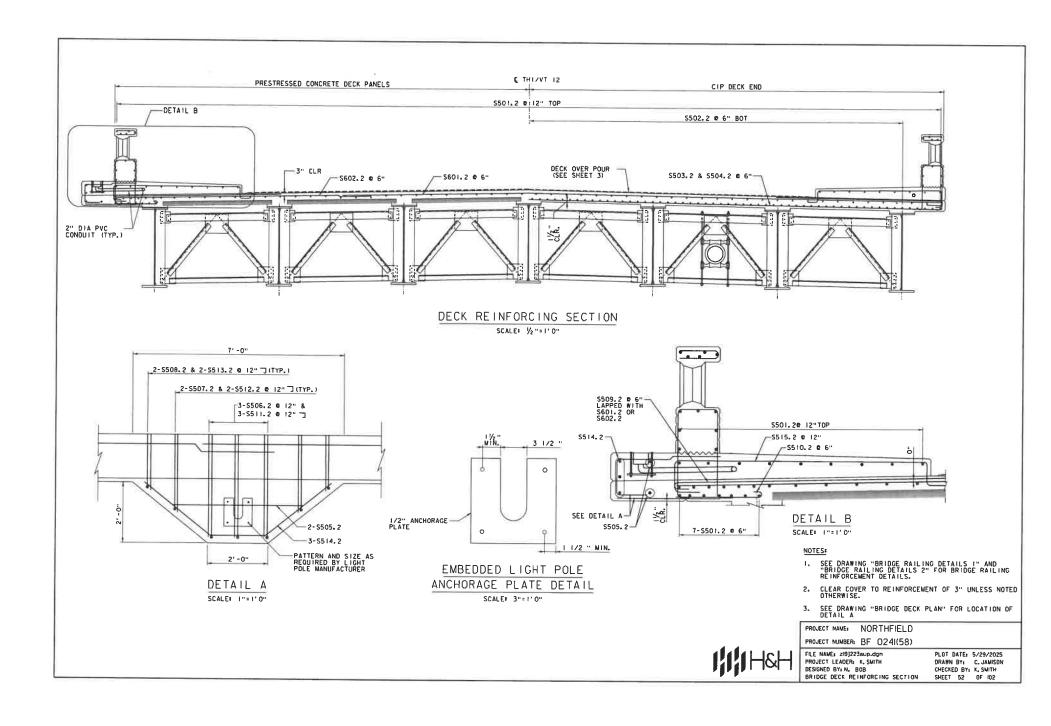

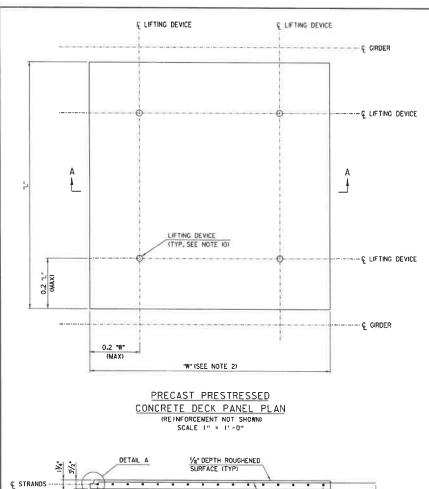

34" DIA STRANDS

(SEE TABLE)

SECTION A-A


SCALE !" = 1'-0"

3" (TYP)


"4 BAR 2 6"


1'-6" REBAR PROJECTION

(FOR END PANELS ONLY)

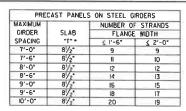

* BARE DECKS WITH 9" THICKNESS AFTER GRINDING SHALL INCLUDE ONE ADDITIONAL STRAND.

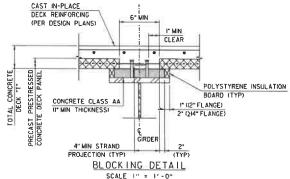

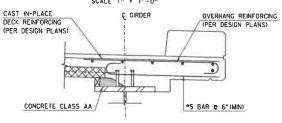

TYPICAL OVERHANG SECTION
SCALE I" = 1'-0"

LEGEND



PRECAST PRESTRESSED CONCRETE DECK PANEL

CONCRETE CLASS AA WITH HIGH RANGE WATER REDUCING ADMIXTURE


GENERAL NOTES:


- PRECAST DECK PANELS SHALL CONFORM TO STANDARD SPECIFICATION SECTION 510 - PRESTRESSED CONCRETE. REINFORCING BARS SHALL MEET THE REQUIREMENTS OF SECTION 507 - REINFORCING STEEL.
- 2. THE TYPICAL PANEL WIDTH IS 8'-O". PANEL WIDTHS OF LESS THAN 8'-O" MAY BE USED. PROVIDE STRANDS IN THE RATIO OF THE SMALLER PANEL WIDTH TO 8'-O". MULTIPLIED BY THE NUMBER OF STRANDS SHOWN, ROUNDING UP TO THE NEXT EVEN NUMBER OF STRANDS. THE MINIMUM PANEL WIDTH IS 3'-O".
- 3. THE CONTRACTOR SHALL SUBMIT WORKING DRAWINGS SHOWING THE EXACT LAYOUT OF PANEL TYPES AND SIZES.
- PRESTRESSING STRANDS SHALL BE %" DIAMETER, GRADE 270 7 - WIRE LOW RELAXATION STRANDS CONFORMING TO THE REQUIREMENTS OF AASHTO M203 (ASTM A416). INITIAL TENSION SHALL BE 17.2 KIPS PER STRAND.
- REINFORCING BARS SHALL HAVE THE SAME LEVEL OF CORROSION RESISTANCE AS THE REINFORCING BARS IN THE CAST-IN-PLACE PORTION OF THE DECK.
- CONCRETE FOR PRECAST PRESTRESSED CONCRETE DECK PANELS SHALL HAVE A MINIMUM 28 DAY COMPRESSIVE STRENGTH OF 5,000 PSI AND A MINIMUM RELEASE STRENGTH OF 4,000 PSI.
- DURING ERECTION, PRECAST PRESTRESSED CONCRETE DECK PANELS SHALL ALIGN VERTICALLY TO WITHIN 1/4 INCH.
- POLYSTYRENE INSULATION BOARD SHALL BE CONTINUOUS, HIGH-DENSITY AND SHALL BE CUT IN THE FIELD TO THE REQUIRED THICKNESS.
- DECK PANELS ARE REQUIRED TO BE GROUTED IN PLACE PRIOR TO PLACEMENT OF THE CAST IN-PLACE DECK. TOP OF GROUT BED SHALL BE A MINIMUM OF I" BELOW THE STRAND EXTENSIONS.
- 10. LIFTING DEVICE SELECTION AND DESIGN SHALL BE THE RESPONSIBILITY OF THE FABRICATOR. A MINIMUM OF FOUR DEVICES SHALL BE INSTALLED.
- 11. REGARDLESS OF THE CURING METHOD FOR THE HAUNCH POUR. FULLY SATURATE CONTINUOUSLY, THE TOP AND SIDE SURFACES OF THE PANELS FOR THREE DAYS AFTER THE HAUNCH POUR AND PRIOR TO THE OVER POUR. PROCEDURE OF THE WETTING METHOD SHALL BE DETERMINED BY THE CONTRACTOR AND SUBMITTED FOR APPROVAL TO THE RESIDENT ENGINEERS.
- 12. TEMPORARY BRACING BETWEEN PANELS SHALL BE PROVIDED AS REQUIRED TO PREVENT PANEL MOVEMENT TRANSVERS TO THE GIRDERS. TEMPORARY BRACING DETAILS SHALL BE PROVIDED IN THE PANEL FABRICATION DRAWINGS AND/OR ERECTION PLAN.

PROJECT NAME: NORTHFIELD


PROJECT NUMBER: BF 0241(58)

FILE NAME: zi9]223sup.dgn PROJECT LEADER: K.SMITH DESIGNED BY: VTRANS BRIDGE DECK DETAILS PLOT DATE: 5/29/2025
DRAWN BY: VTRANS
CHECKED BY: VTRANS
SHEET 53 OF 102

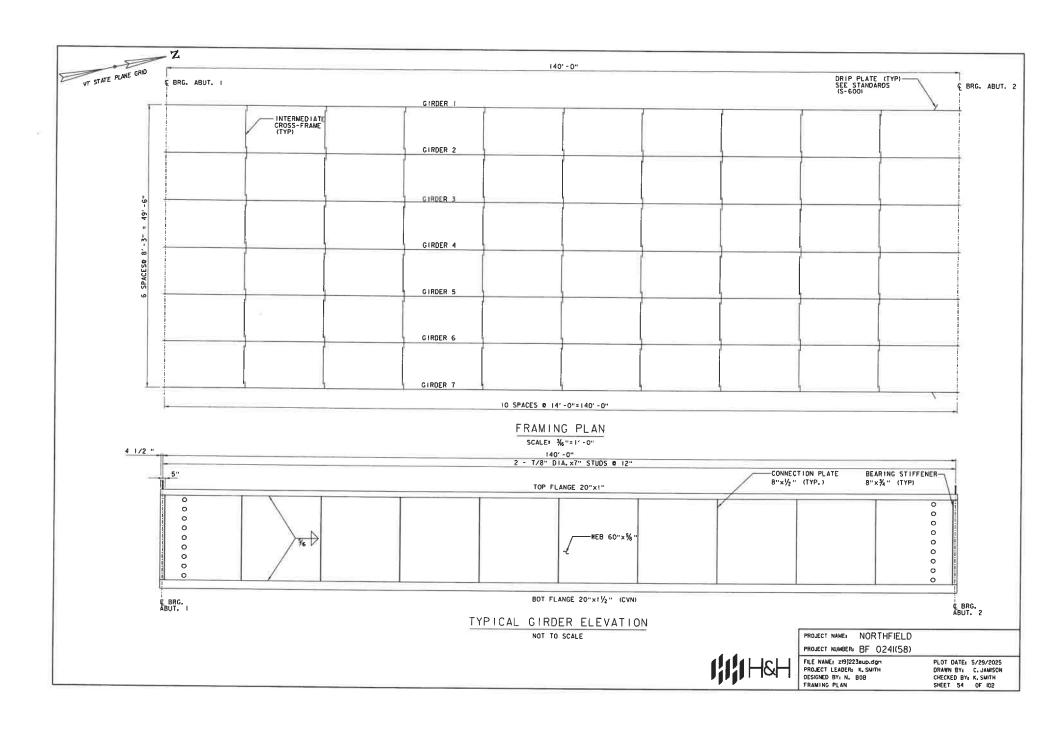

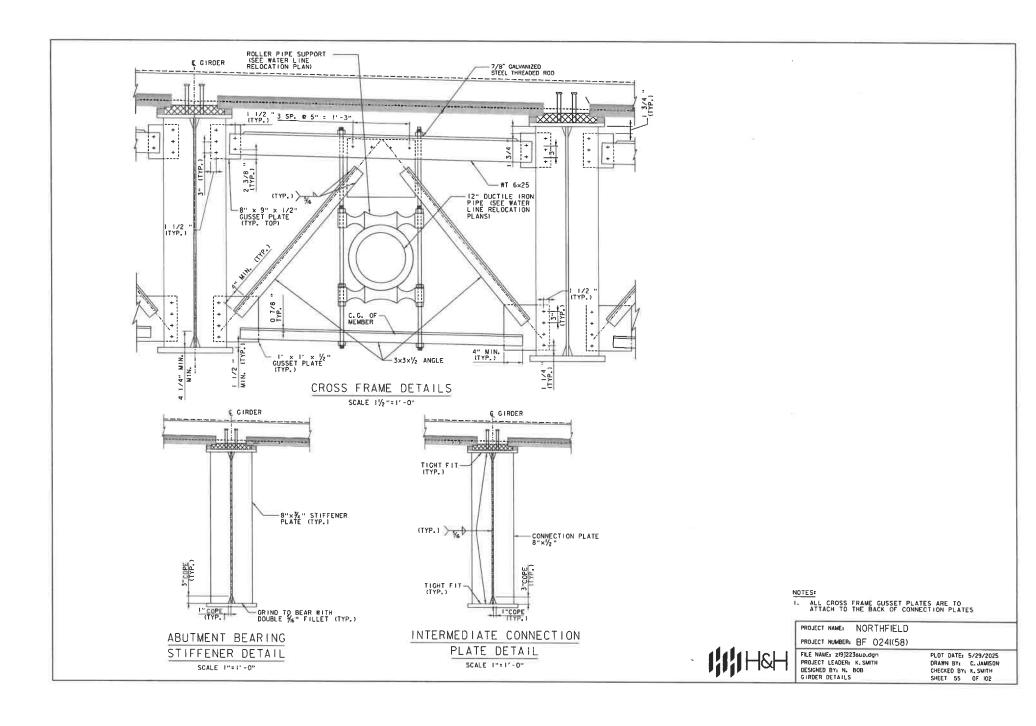



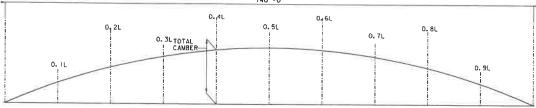

CAMBER DIAGRAM

NOT TO SCALE


			CA	MBER	TAB	LE						
GIRDER		BRG ABUT. I	0. IL	0.2L	0. 3L	0.4L	0.5L	0.6L	0.7L	0.8L	0.9L	BRG ABUT.
Î	I. STEEL DL (IN.)	0.00	-0.48	-0.90	-1.23	-1.45	-1,52	-1.45	-1.23	-0.90	-0.48	0.00
	(I. CONCRETE DL (IN.)	0,00	-1.39	-2.62	-3.59	-4.21	-4, 42	-4,21	-3.59	-2.62	-1.39	0,00
	III. SUPERIMPOSED DL (IN.)	0.00	-0.44	-0.83	-1,14	-1.33	-1.40	-1.33	-1.14	-0,83	-0.44	0.00
	TOTAL (IN.)	0.00	-2.30	-4.35	-5.96	-6.98	-7.33	-6.98	-5.96	-4.35	-2.30	0.00
	I. STEEL DL (IN.)	0,00	-0.48	-0.90	-1.23	-1.45	-1.52	-1.45	-1.23	-0.90	-0.48	0.00
	II. CONCRETE DL (IN.)	0.00	-1.72	-3.26	-4.46	-5.22	-5.48	-5.22	-4.46	-3.26	-1.72	0.00
2	III. SUPERIMPOSED DL (IN.)	0.00	-0.42	-0.79	-1.08	-1.27	-1.33	-1.27	-1.08	-0.79	-0.42	0.00
	TOTAL (IN.)	0.00	-2.62	-4.95	-6.78	-7.94	-B. 33	-7.94	-6.78	-4.95	-2.62	0.00
	1. STEEL DL (IN.)	0.00	-0.48	-0.90	-1.23	-1.45	-1.52	-1.45	-1.23	-0.90	-0.48	0.00
3	II. CONCRETE DL (IN.)	0.00	-1.72	-3.26	-4.46	-5.22	-5.48	-5.22	-4.46	-3.26	-1.72	0.00
	III. SUPERIMPOSED DL (IN.)	0.00	-0.42	-0.79	-1.08	-1.27	-1.33	-1.27	-1.08	-0.79	-0.42	0,00
	TOTAL (IN.)	0.00	-2.62	-4.95	-6.78	-7.94	-8.33	-7.94	-6.78	-4.95	-2.62	0,00
4	1. STEEL DL (IN.)	0.00	-0.48	-0.90	-1.23	-1.45	-1.52	-1.45	-1.23	-0.90	-0.48	0.00
	II. CONCRETE DL (IN.)	0.00	-1.72	-3.26	-4.46	-5,22	-5.48	-5.22	-4.46	-3, 26	-1.72	0.00
	III. SUPERIMPOSED DL (IN.)	0.00	-0.42	-0.79	-1.08	41.27	-1.33	-1.27	-1.08	-0.79	-0.42	0.00
	TOTAL (IN.)	0.00	-2.62	-4.95	-6.78	-7.94	-8.33	-7.94	-6.78	-4.95	-2.62	0.00
	I. STEEL DL (IN.)	0.00	-0.48	-0.90	-1,23	-1.45	-1.52	-1.45	-1.23	-0.90	-0.48	0.00
	II. CONCRETE DL (IN.)	0.00	-1.72	-3.26	-4.46	-5.22	-5.48	-5.22	-4.46	-3.26	-1,72	0.00
5	III. SUPERIMPOSED DL (IN.)	0.00	-0.42	-0.79	-1,08	-1.27	-1.33	-1.27	-1.08	-0.79	-0,42	0.00
_	TOTAL (1N.)	0.00	-2.62	-4.95	-6.78	-7.94	-8.33	-7.94	-6.78	-4.95	-2.62	0.00
6	I. STEEL DL (IN.)	0.00	-0.48	-0,90	-1.23	-1.45	-1.52	-1.45	-1.23	-0.90	-0.48	0.00
	II. CONCRETE DL (IN.)	0.00	-1.72	-3.26	- 4. 46	-5.22	-5.48	-5.22	-4.46	-3.26	-1.72	0.00
	III. SUPERIMPOSED DL (IN.)	0.00	-0.42	-0.79	-1.08	-1.27	-1.33	-1.27	-1.08	-0.79	-0.42	0.00
	TOTAL (IN.)	0.00	-2.62	-4.95	-6.78	-7.94	-8.33	-7.94	-6.78	-4.95	-2.62	0.00
7	I. STEEL DL (IN.)	0.00	-0.48	-0.90	-1.23	-1.45	-1.52	- 1. 45	-1.23	-0.90	-0.48	0.00
	II. CONCRETE DL (IN.)	0.00	-1.39	-2.62	-3.59	-4.21	-4.42	-4.21	-3.59	-2.62	-1.39	0.00
	III. SUPERIMPOSED DL (IN.)	0.00	-0.44	-0.83	-1.14	-1.33	-1.40	-1.33	-1.14	-0.83	-0.44	0.00
	TOTAL (IN.)	0,00	-2.30	-4, 35	-5.96	-6, 98	-7.33	-6.98	-5.96	-4.35	-2,30	0.00


1111H&H


PROJECT NAME: NORTHFIELD PROJECT NUMBER: BF 0241(58)

FILE NAME: z/9/223sup.dgn PROJECT LEADER: K. SMITH DESIGNED BY: N. BOB CAMBER TABLE


PLOT DATE: 5/29/2025 DRAWN BY: C. JAMISON CHECKED BY: K. SMITH SHEET 56 OF 102

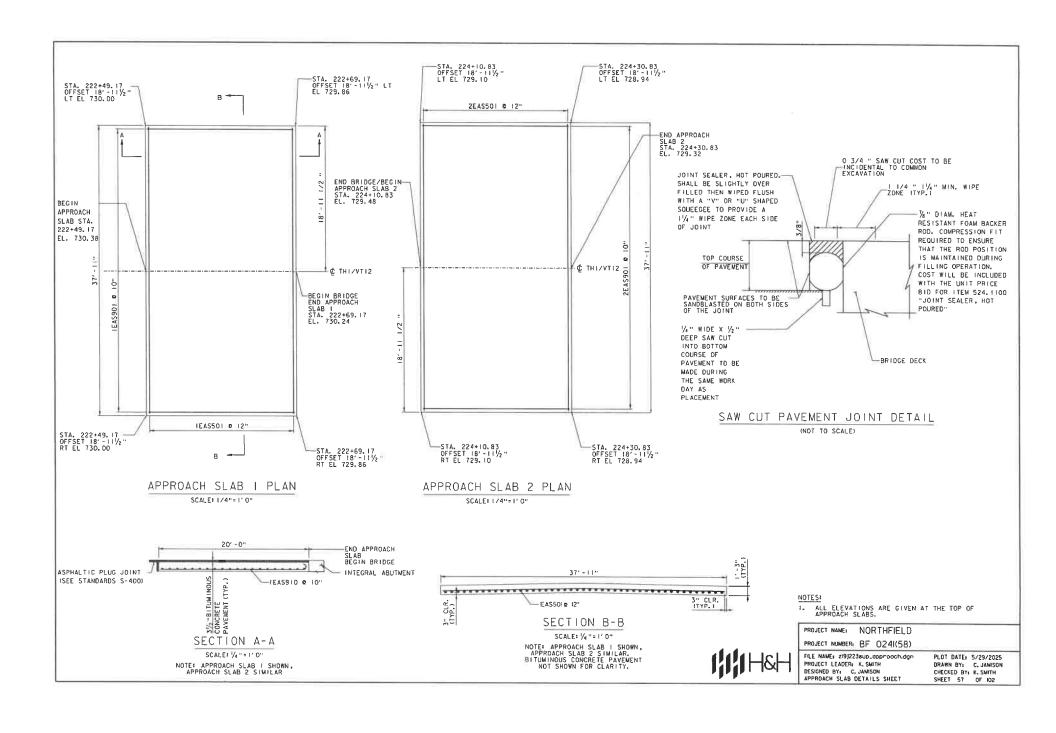

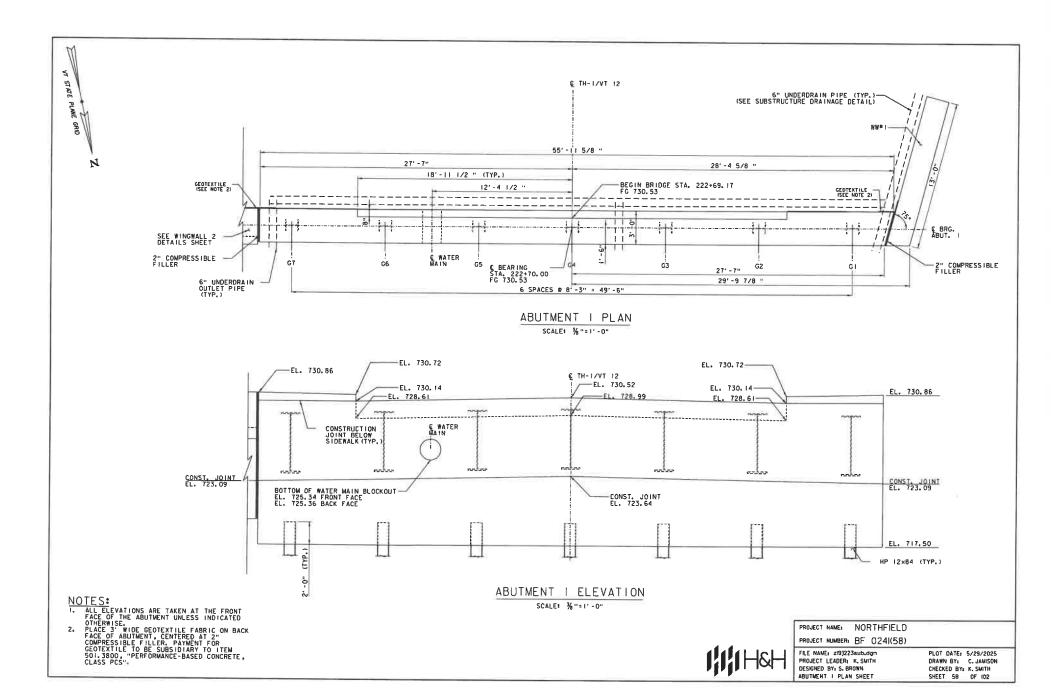

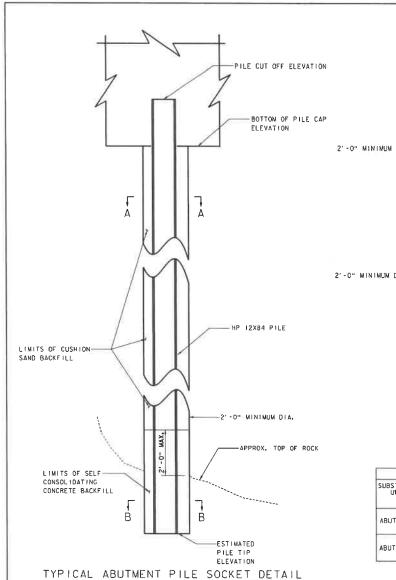

SCALE: NOT TO SCALE

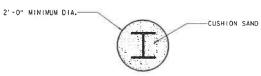

SECTION A-A



SECTION B-B


NOTES:

- FOR WINGWALL PILE INFORMATION REFER TO WINGWALL PILE DETAIL SHEET.
- 2. SELF-CONSOLIDATING CONCRETE (SCC) SHALL BE PLACED UNTIL UNCONTAMINATED SCC SURPASSES THE LIMITS OF THE ROCK SOCKET, BUT DOES NOT EXTEND PAST THE LIMITS OF SCC SHOWN ON THE PLANS. THE REMAINDER OF THE DRILLED PILE SOCKET SHALL BE BACKFILLED WITH CUSHION SAND.
- 3. THE CONTRACTOR SHALL IMMEDIATELY NOTIFY THE ENGINEER IF ACTUAL TOP OF ROCK ELEVATIONS ARE OUTSIDE THE RANGES SHOWN IN THE ABUTMENT PILE SUMMARY TABLE.

				ABUTMENT I	PILE SUMMARY TABLE			
SUBSTRUCTURE UNIT	PILE SIZE	MIN. DRILL HOLE DIA. (FT)	ESTIMATED TOP OF ROCK ELEVATION (FT)		REQUIRED ROCK SOCKET LENGTH (FT)	ESTIMATE: ELEVAT	PILE CUTOFF ELEVATION (FT)	
			FROM	TO		FROM	TO	
ABUTMENT I	HP 12×84	2	698.5	700. 3	7	691.5	693. 3	719.5
ABUTMENT 2	HP 12×84	2	701.6	706.0	7	694.6	699.0	718.5



PROJECT NAME: NORTHFIELD	
PROJECT NUMBER: BF 0241(58)	
FILE NAME: zi9J223h_plie_grouting.dgn PROJECT LEADER: K. SMITH	PLOT DATE: 5/29/2025 DRAWN BY: C. JAMISON
DESIGNED BY: S. BROWN ABUTMENT PILE DETAIL SHEET	CHECKED BY: K. SMITH SHEET 59 OF 102

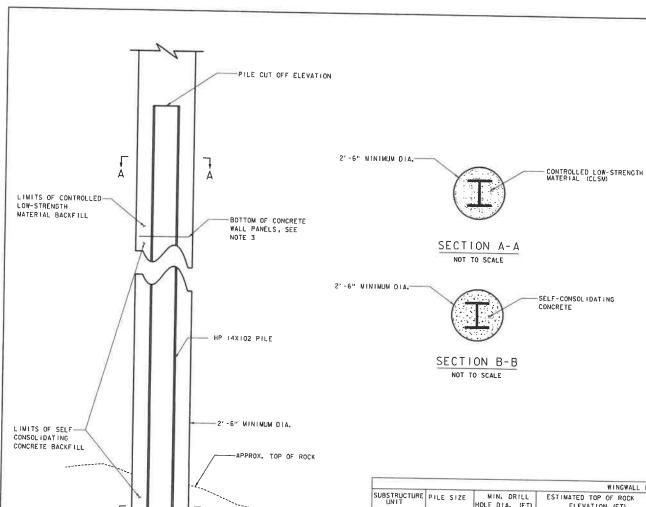

Ė

В

TYPICAL WINGWALL PILE SOCKET DETAIL

ESTIMATED
PILE TIP
ELEVATION


NOTES:


- FOR ABUTMENT PILE INFORMATION REFER TO ABUTMENT PILE DETAIL SHEET.
- SELF-CONSOLIDATING CONCRETE SHALL BE PLACED TO THE BOTTOM OF THE CONCRETE WALL PANELS. THE REMAINDER OF THE DRILLED PILE SOCKET SHALL BE BACKFILLED WITH CONTROLLED LOW-STRENGTH MATERIAL (CLSM).
- 3. CONCRETE WALL PANELS NOT SHOWN FOR CLARITY.
- 4. THE CONTRACTOR SHALL NOTIFY THE ENGINEER IF ROCK IS NOT ENCOUNTERED 5'-O" BELOW THE ESTIMATED TOP OF ROCK ELEVATION SHOWN IN THE WINGWALL PILE SUMMARY TABLE. ORILLING OPERATIONS SHALL CEASE AND THE ENCINEER SHALL BE NOTIFIED IF ROCK IS NOT ENCOUNTERED UPON REACHING THE MAXIMUM PILE TIP ELEVATION IN SOIL SHOWN IN THE WINGWALL PILE SUMMARY TABLE.


			WINGWALL	PILE SUMMARY TABLE		
SUBSTRUCTURE UNIT		MIN, DRILL HOLE DIA, (FT)	ESTIMATED TOP OF ROCK ELEVATION (FT)	REQUIRED ROCK SOCKET LENGTH (FT)	ESTIMATED PILE TIP ELEVATION IN ROCK (FT)	MAXIMUM PILE TIP ELEVATION IN SOIL (FT)
WINGWALL 2	HP 14X102	2.5	700. 3	7	693.3	690.0
WINGWALL 3	L 3 HP 14X102 2.5 701.6		7	694.6	690.0	



PROJECT NAME: NORTHFIELD	
PROJECT NUMBER: BF 0241(58)	
FILE NAME: zi9j223h.plie.grouting.dgn PROJECT LEADER: K.SMITH DESIGNED BY: S. BROWN WINGWALL PILE DETAIL SHEET	PLOT DATE: 5/29/2025 DRAWN BY: C. JAMISON CHECKED BY: K. SMITH SHEET 60 OF 102

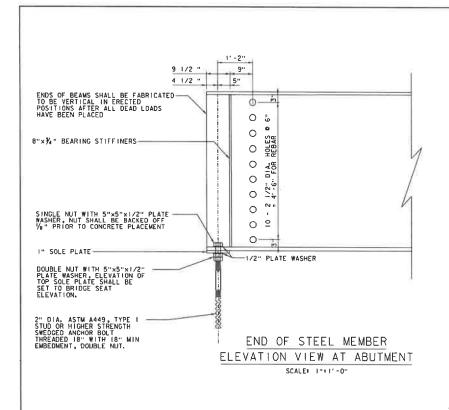

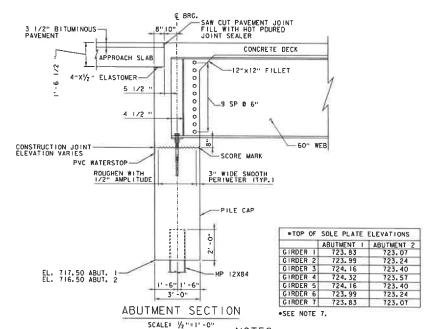

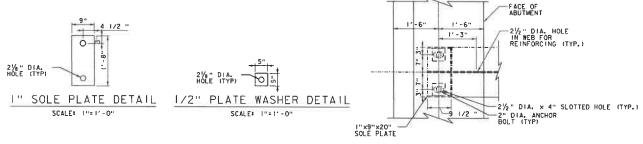

END OF STEEL MEMBER
PLAN VIEW AT ABUTMENT


SCALE: 1"=1'-0"


NOTES:


- 1. PAYMENT FOR THE SOLE PLATES, ANCHOR BOLTS, WASHERS AND NUTS SHALL BE INCIDENTAL TO ITEM 506.5500, STRUCTURAL STEEL, PLATE GIRDER.
- ANCHOR BOLTS SHALL BE 2" DIAMETER, TYPE I BOLTS MEETING ASTM F 1554, GR 55. NUTS SHALL MEET ASTM A563.
- ALL ANCHOR BOLTS SHALL BE SET BY TEMPLATE BEFORE CONCRETE IS PLACED. NO DRILLING WIL BE ALLOWED. ALL ASSOCIATED COSTS SHALL BE INCIDENTAL TO ITEM 501.3700, "PERFORMANCE-BASED CONCRETE, CLASS PCD".
- ALL STEEL IN BEARING DEVICE ASSEMBLY SHALL BE AASHTO M270M/M270 GR 50.
- 5. SUBSTITUTIONS FOR BEARING DEVICE ASSEMBLY COMPONENT MATERIALS AND SIZES SHALL BE DETAILED ON THE FABRICATION DAMINGS. ALL SUBSTITUTIONS SHALL BE APPROVED BY THE PROJECT MANAGER PRIOR TO FABRICATION AS PER SECTION 506.04.
- 6. THE CONTRACTOR SHALL GREASE THE TOP SURFACE OF THE SOLE PLATES PRIOR TO PLACEMENT OF THE GIRDERS. FOLLOWING GIRDER ERECTION ALL EXCESS GREASE SHALL BE WIFED FROM THE SOLE PLATES.
- THE CONTRACTOR SHALL VERIFY THAT ALL ANCHOR BOLTS ARE INSTALLED PLUMB AND REMAIN PLUMB FOLLOWING GIRDER ERECTION. THE ENGINEER SHALL BE NOTIFIED OF ANY DISCREPANCIES.


PROJECT NAME: NORTHFIELD PROJECT NUMBER: BF 0241(58)

FILE NAME: zi9j223sub.dgn PROJECT LEADER: K. SMITH DESIGNED BY: S. BROWN ABUTMENT CONNECTION DETAIL PLOT DATE: 5/29/2025 DRAWN BY: C. JAMISON CHECKED BY: K. SMITH SMEET 61 OF ID2

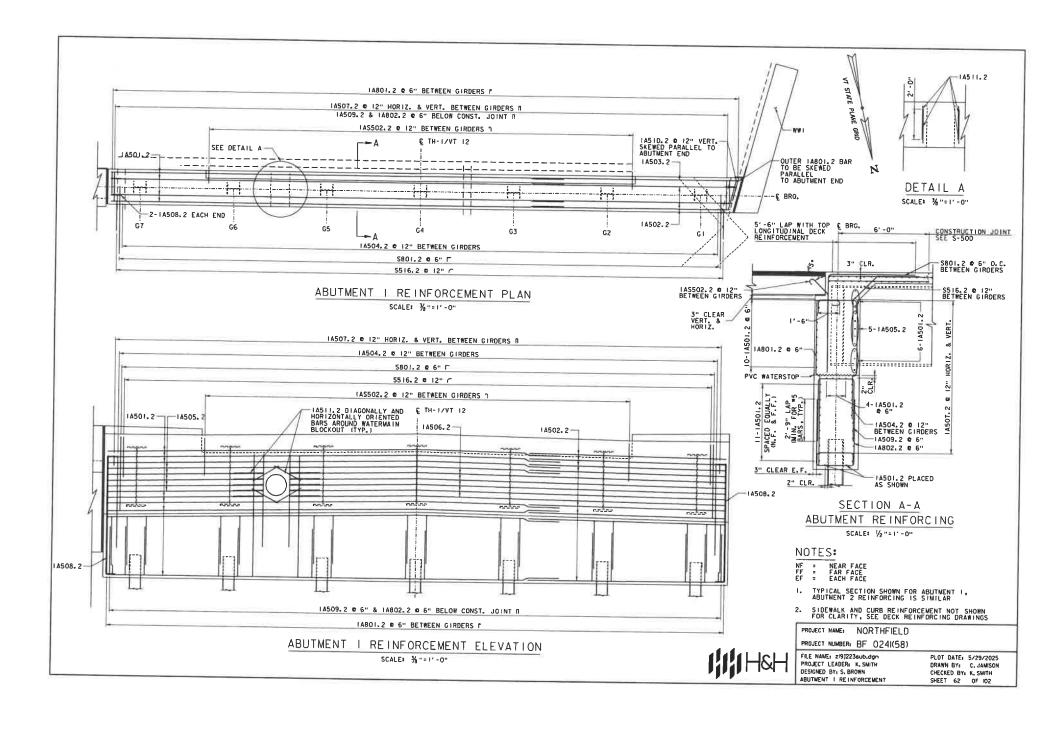

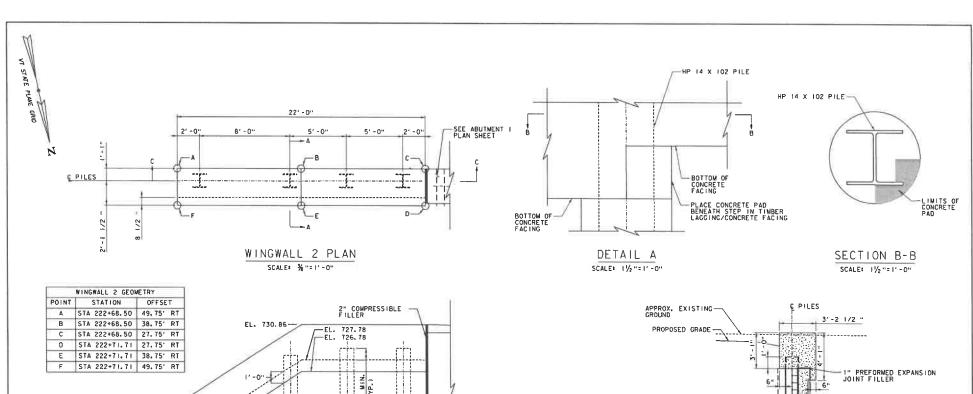

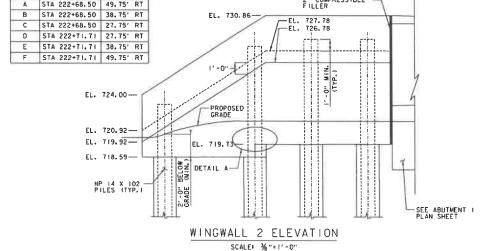

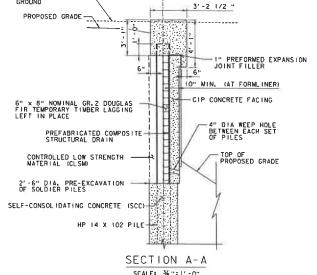

SCALE: 16"=1'-0"


NOTE


I. SEE "SOLDIER PILE WALL DETAILS 3" SHEET FOR SECTION C-C VIEW


PROJECT NAME: NORTHFIELD PROJECT NUMBER: BF 0241(58)

FILE NAME: z/9)223sub.dgn PROJECT LEADER: K. SMITH DESIGNED BY: S. BROWN WINGWALL 2 DETAILS

PLOT DATE: 5/29/2025 DRAWN BY: C. JAMISON CHECKED BY: K. SMITH SHEET 63 OF 102

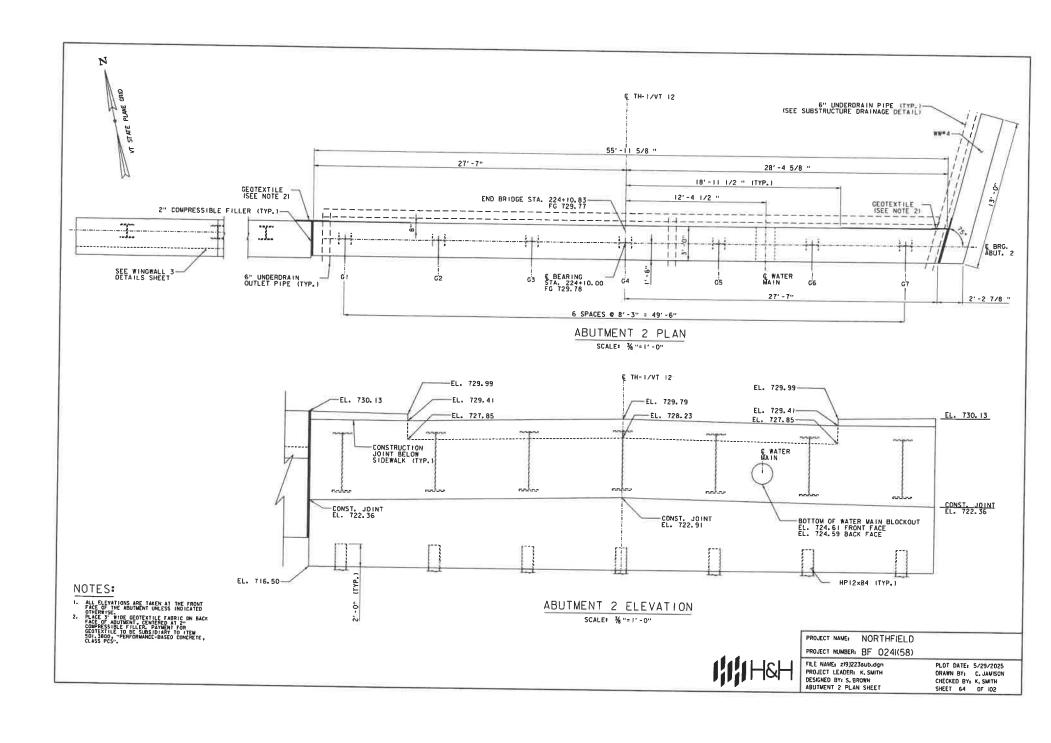

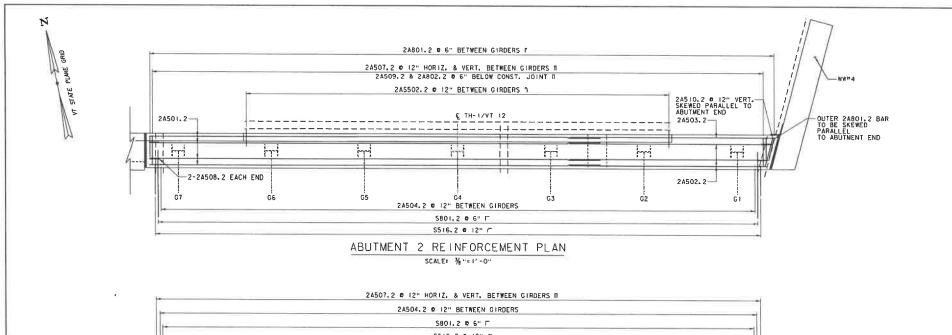

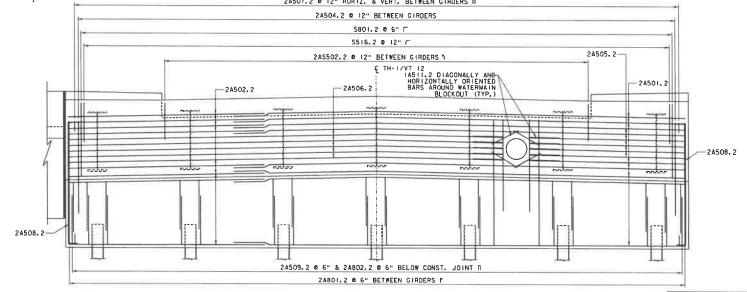

NOTES:

1. SIDEWALK AND CURB REINFORCEMENT NOT SHOWN FOR CLARITY, SEE DECK REINFORCING DRAWINGS ABUTMENT 2 REINFORCEMENT ELEVATION


SCALE: 36"=1'-0"





PROJECT NAME: NORTHFIELD
PROJECT NUMBER: BF 0241(58)


FILE NAME: zi9J223sub.dgn PROJECT LEADER: K, SMITH DESIGNED BY: S, BROWN ABUTMENT 2 REINFORCEMENT


PLOT DATE: 5/29/2025
DRAWN BY: C. JAMISON
CHECKED BY: K. SMITH
SHEET 65 OF 102

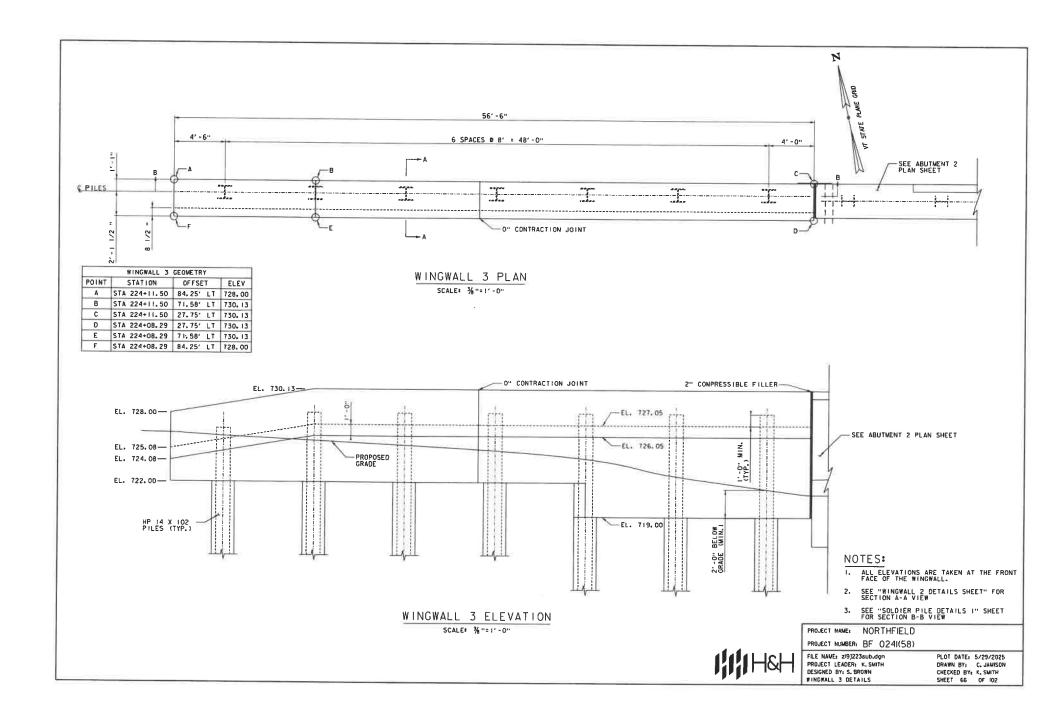


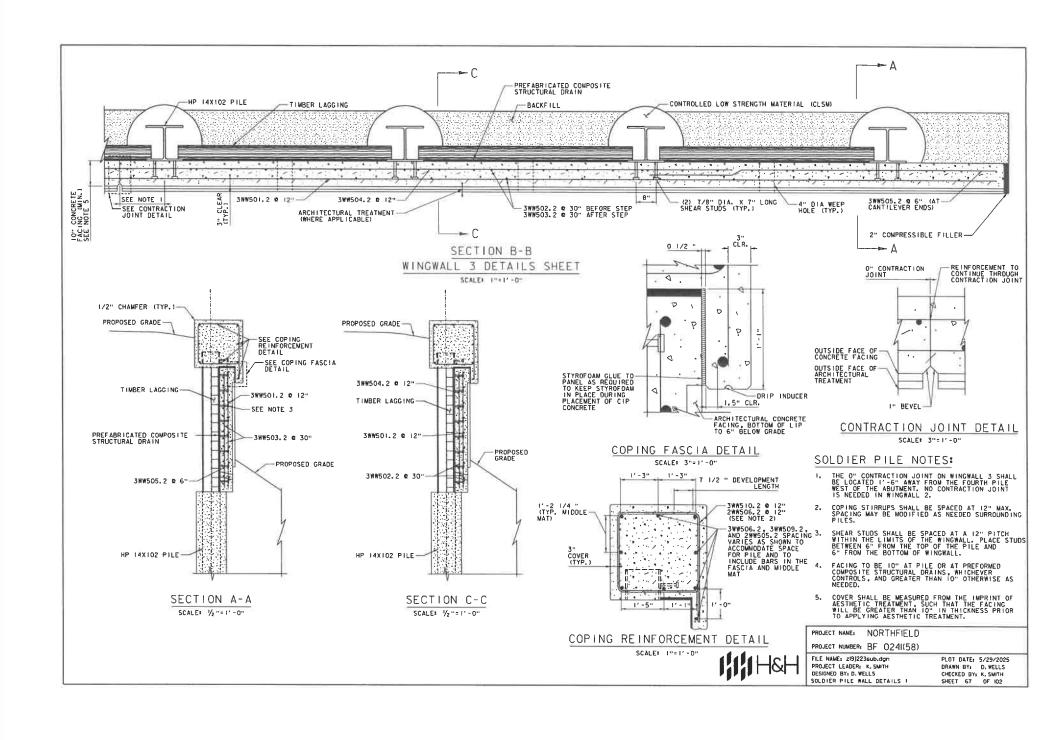


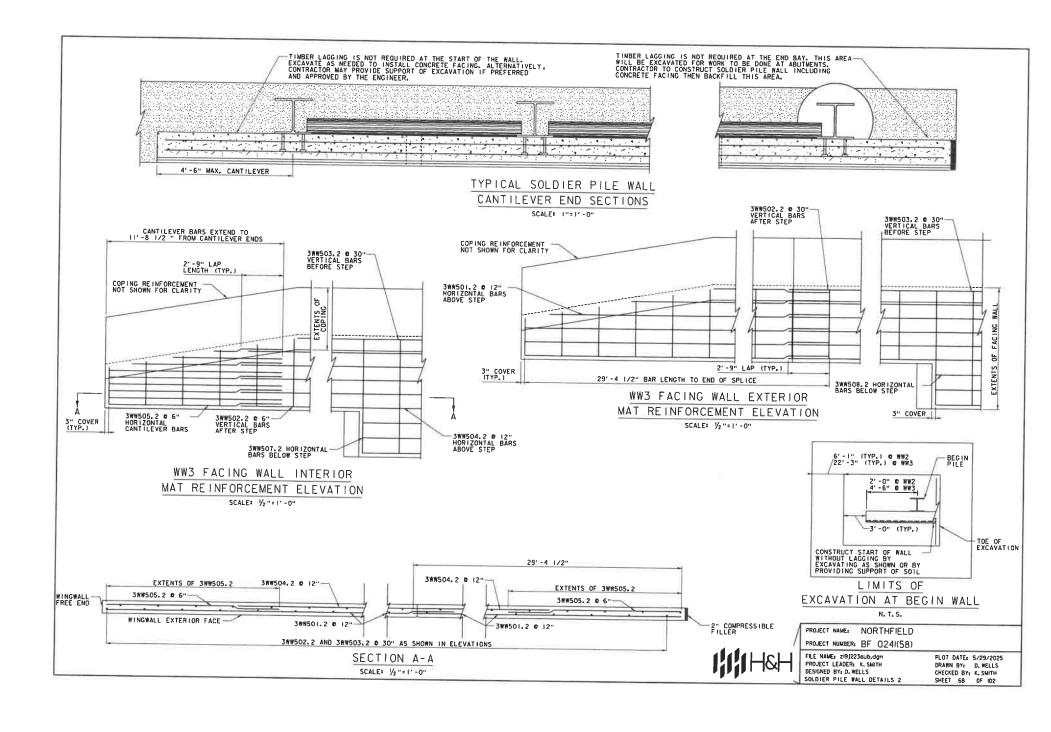


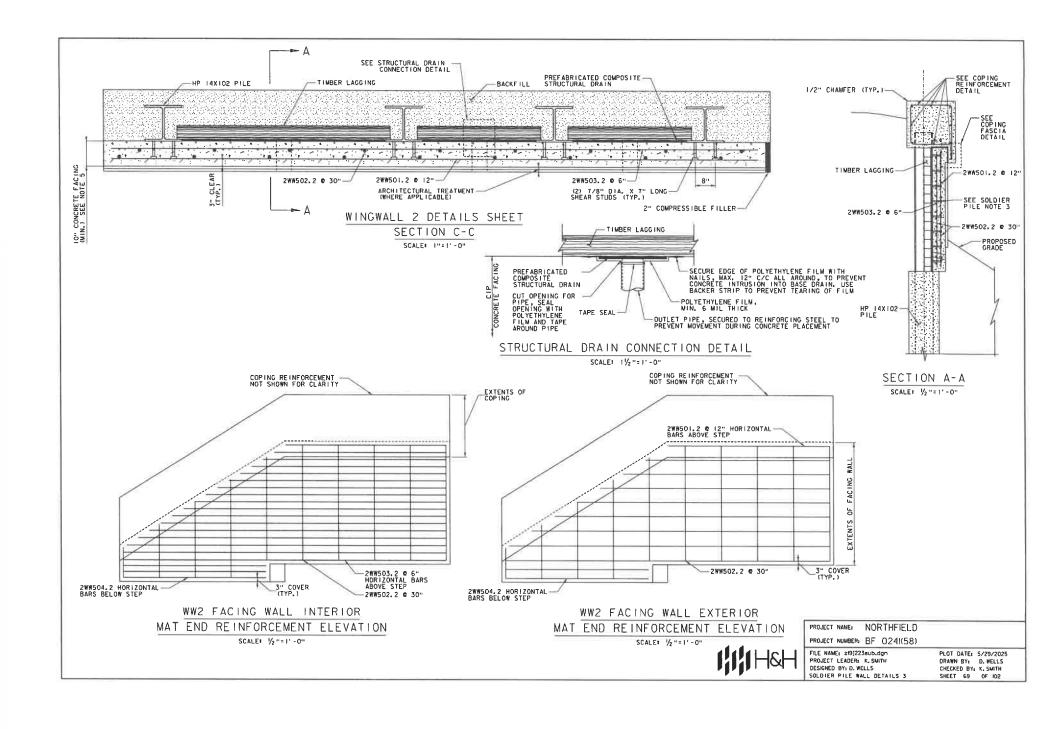


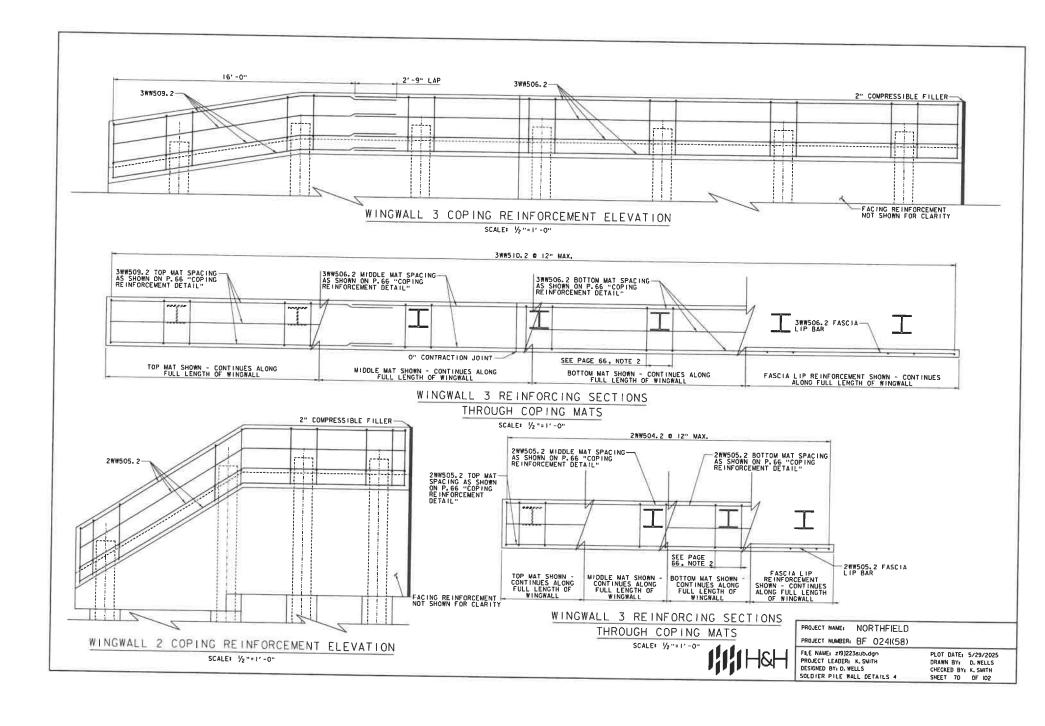


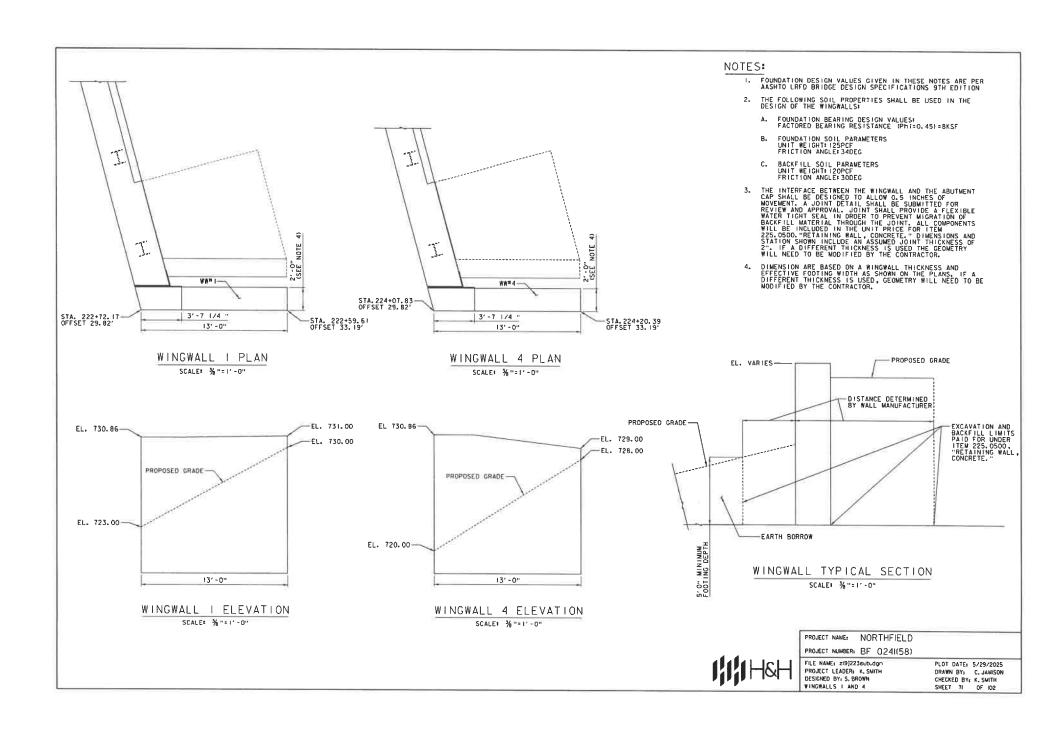

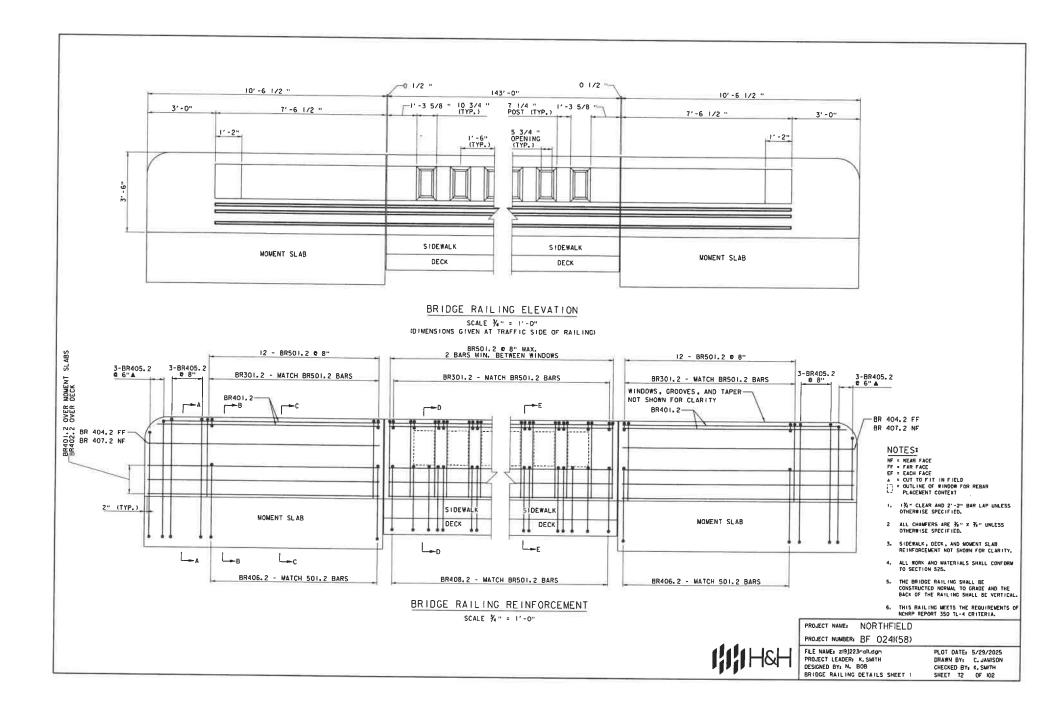

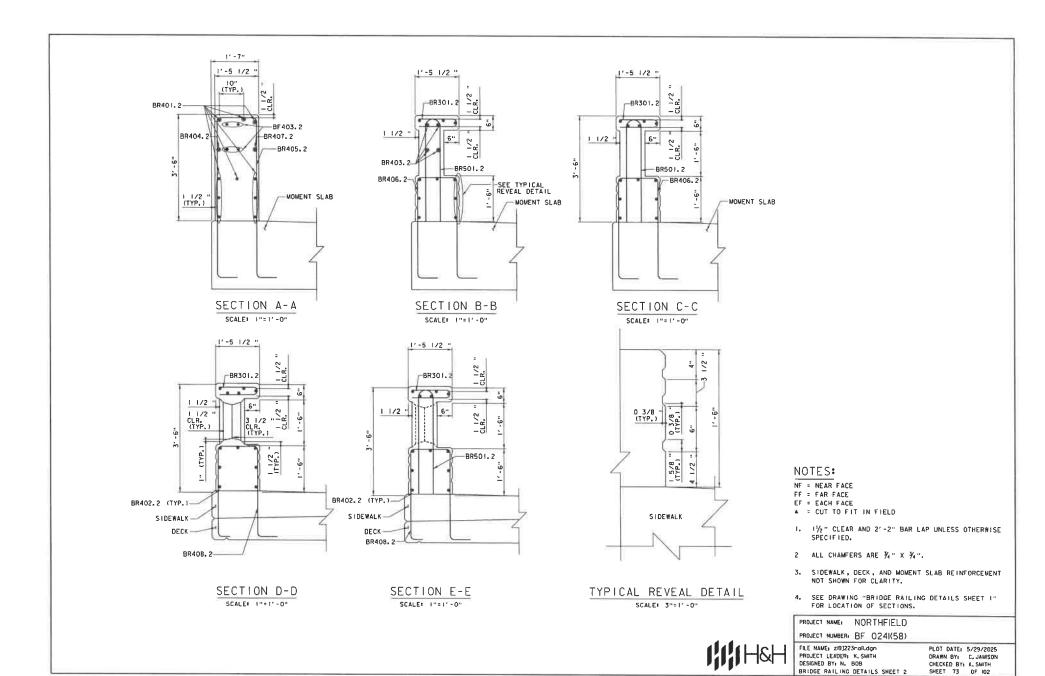

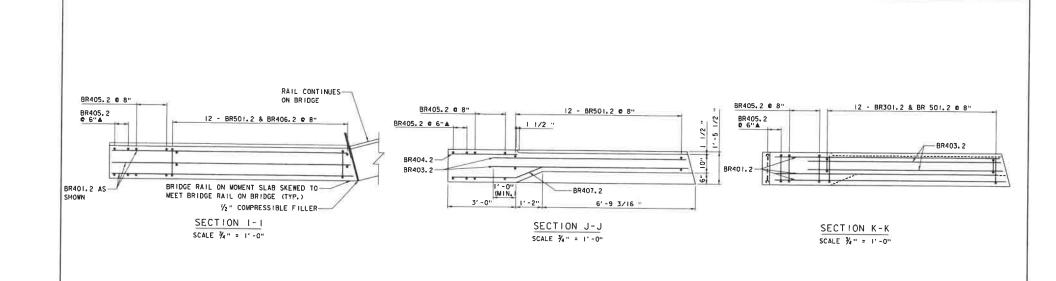


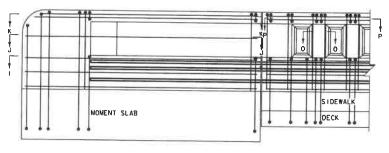


END OF BRIDGE RAILING

ELEVATION ON MOMENT SLAB

SCALE 1/4" = 1'-0"

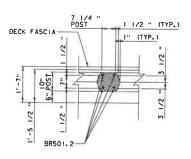

SECTION 0-0

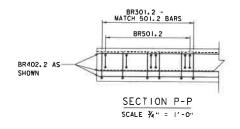


IIIIH&H

PROJECT NAME: NORTHFIELD
PROJECT NUMBER: 8F 024I(58)

FILE NAME: 2/9/223rd/l.dgn
PROJECT LEADER: K. SMITH
DESIGNED BY: N. BOB
BRIDGE RAILING DETAILS SHEET 3

PLOT DATE: 5/29/2025 DRAWN BY: C. JAMISON CHECKED BY: K, SMITH SHEET 74 DF 102



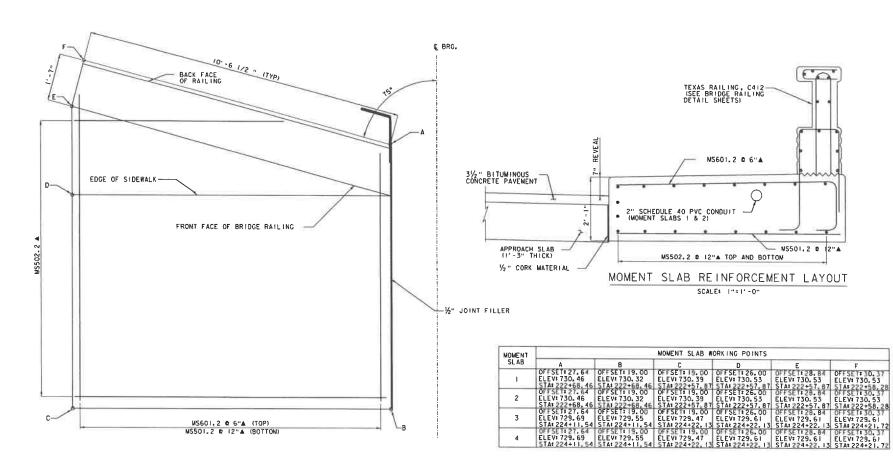

MOMENT SLAB PLAN SCALE: 1"=1"-0"

MS601.2 € 6"▲ (TOP)
MS501.2 € 12"▲ (BOTTOM)

LEGEND:

A DENOTES CUT IN FIELD


PROJECT NAME: NORTHFIELD PROJECT NUMBER: BF 0241(58)

FILE NAME: 219)223sub.dgn PROJECT LEADER: K. SMITH DESIGNED BY: N. BOB MOMENT SLAB DETAILS SHEET

PLOT DATE: 5/29/2025 DRAWN BY: C. JAMISON CHECKED BY: K. SMITH SHEET 75 OF 102



STATE OF VERMONT REINFORCING STEEL SCHEDULE AGENCY OF TRANSPORTATION TITEM EACH SIZE LENGTH WARK TYPE A B C D E TIEM EACH SIZE LENGTH MARK TYPE A 8 C D E F G H J K R O F G ~ NOTES ~ DECK ABUTMENT 2 1. UNLESS OTHERWISE DESIGNATED, ALL BAR REINFORCEMENT FOR CONCRETE IN SIZES UP TO AND INCLUDING NO. 18 36-10" \$501.2 STH 6-7" \$502.2 STR 40-0" \$503.2 STR 16'-8" \$504.2 STR 4'-3" \$505.2 STR 24501.2 STR 24502.2 STR 24502. SHALL COMFORM TO THE REQUIREMENTS OF THE "SPECIFICATIONS FOR DEFORMED BILLET-STEEL BARS FOR CONCRETE 23 | 5 | 17'-5" 21 | 5 | 18'-3" 54 | 5 | 8'-0" 5 | 5 | 13'-6" 5 | 5 | 38'-6" 5 40.0° 5 16.8° 5 4.3° 5 2.6° 6 1.0° 6 11.11° REINFORCEMENT", AASHTO M 31 (ASTM A 615-SI), ALL BARS SHALL BE GRADE 60, UNLESS OTHERWISE DESIGNATED. 2. FOR TYPICAL BENDING DETAILS, RECOMMENDED PIN DIAMETER "D" OF BENDS AND HOOKS, AND OTHER STANDARD S506 2 STR S507 2 STR S508 2 STR S509 2 1 PRACTICE. SEE CURRENT CONCRETE REINFORCING STEEL INSTITUTE THAMUAL OF STANDARD PRACTICE. 702 5 4'6' 4 5 12'8' 102 5 11'4" 3. BARS WHICH REQUIRE MORE ACCURATE BEHONG THAN STANDARD PRACTICES SHOULD HAVE LIMITS INDICATED. | 98092 | 5178 | 53992 | 7 | 6-17 | 11-07 | 55922 | 1 | 6-17 | 11-07 | 55922 | 1 | 6-17 | 12-07 | 55122 | 17 | 2-67 | 12-07 | 6-67 | 55122 | 17 | 12-07 | 12-07 | 6-67 | 55122 | 25 | 6-67 | 12-07 | 2-107 | 55152 | 25 | 6-67 | 12-07 | 2-107 | 55152 | 25 | 6-67 | 12-07 | 2-107 | 55152 | 25 | 6-67 | 12-07 | 2-107 | 55152 | 25 | 6-67 | 12-07 | 2-107 | 2-107 | 55152 | 25 | 6-67 | 12-07 | 2-107 | 2-107 508 b 11-11 514 5 3-4 116 5 0-2 12 5 4-4 12 5 3-7 12 5 3-7 18 5 8-6 286 5 11-2 106 5 7-7 4. ALL DIMENSIONS ARE OUT TO OUT OF BAR EXCEPT "A" AND "G" ON STANDARD 180 DEGREE AND 135 DEGREE HOOKS. 0-0 5. "IF DIMENSION ON 180 DEGREE HOOKS TO BE SHOWN ONLY WHERE NECESSARY TO RESTRICT HOOK SIZE. OTHERWISE, 106 8 13'-5' 2A601.2 21 1'-5' 1'-6' 10'-8' 102 8 13'-0' 2A802.2 510 5'-2' 2'-6' 5'-2' 1'-9' 1'-9' 2'-2' 2'-2" 6. "H" CIMENSION ON STIRRUPS TO BE SHOWN ONLY WHEN NECESSARY TO MAINTAIN CLEARANCES. 1-11" 1-11" 1-11" 1-11" APPROACH SLAB 1 7. WHERE SLOPE DIFFERS FROM 45 DEGREES, DIMENSIONS TH' AND TH' MUST BE SHOWN 284 6 40'-0" \$801.2 STR * 285 7 16'-5" \$602.2 STR 22 5 37'-5" 1EASS01 STR 54 5 5'-7" 1ASS02.2 11 0-11" 1'-5" 0'-6" 2'-9" 8. A DENOTES BARS TO BE CUT IN FIELD. 6-0" 6-5" 0-0" 222 8 12'-6" 5801,2 510 46 9 19'-9" TEASPOT 1 1'-2" 16'-7" 9. * DENOTES ONE EXTRA BAR ADDED FOR TESTING PURPOSES. 0.0 0-1T BRIDGE RAIL 10. △ DENOTES TWO EXTRA BARS ADDED FOR TESTING PURPOSES APPROACH SLAB 2 # 429 3 2"-7" BR301,2 S11 11. E IN BAR MARK PREFIX DENOTES EPOXY COATED REINFORCING STEEL. 1'-2' 4 10°.8" BR401.2 STR 4 30°.8" BR402.2 STR 4 8°.9" BR403.2 STR 4 2°.10" BR404.2 STR 4 12°.10" BR406.2 S5 LACT 45 9 19'-9' 2EAS901 1 1'-2' 18'-7" MOMENT SLAB Gj 44 5 10-10 MS5012 STR 0'-0" 0'-6" 0'-0" 1'-2" 0-6" 际 ▲ 88 6 12-5 MS501.2 S10 0'-8" 1'-8" 429 5 7'-3" BR501.2 511 WINGWALL 2 6'-10" 0'-0" WINGWALL 3 -------2-2" 0'-0" 12'-5" 0'-0" Zŀ 0 ABUTMENT 1 ASTM STANDARD - REINFORCING STEEL CORROSION RESISTANCE LEVEL -REINFORCING BARS THE REMPORCING STEEL MARKS IN THIS SCHEDILL INDICATE THE REQUIREDBAR CORROSIONNESSTALCE LEVEL CORROSIONNESSTALCE LEVEL CORROSIONNESSTALCE LEVEL IS DEMOTED WITH A 2 FOR LEVEL TWO SUFFIX OR, SPORLEVEL HERE SERVEY, A FOR LEVEL CARROSION TO BE COUNTED. THE REPARAMETERAL THE MOD BAY STEEL GARDE PROVIDED FOR EACH CORROSION LEVEL WILL BE RECORDED ON THE PLANSET OF SHEET FOR SA-BUILT RECORD PLANAGED AND THE WHOSE SCHOOL OUT SOME TOUR STORM 2'-6" 4'-3" 43 0.376 0.375 0.11 1.178 4 0.668 0.500 0.20 1.571 1'-5' 1'-6' 10'-5' 5'-1' 2'-6' : 106 8 13'-5' : 103 8 12'-6' *5 1.043 0.626 0.31 1.963 46 1.502 0.750 0.44 2.356 47 2.044 0.875 0.60 2.749 8 2.670 1.000 0.79 3.142 9 3.400 1.128 1.00 3.544 *10 4.303 1.270 1.27 3.990 PROJECT NAME: NORTHFIELD 411 5.313 1.410 1.56 4.430 PROJECT NUMBER: BF 0241(58) 14 7.85 1.693 2.25 5.32 FILE NAME: zi9)223rebor.don PLOT DATE: 5/29/2025 *18 13.60 2.257 4.00 7.09 PROJECT LEADER: K. SMITH DRAWN BY: C. JAMISON DESIGNED BY: CHECKED BY: K. SMITH REINFORCING STEEL SCHEDULE SHEET 76 OF 102

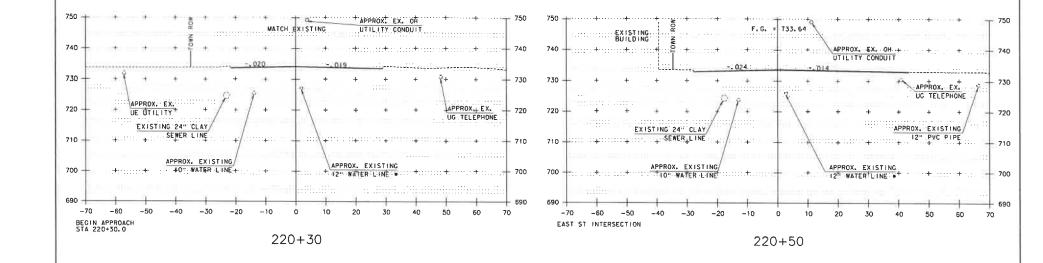

NOTE:

 EARTHWORK ASSOCIATED WITH PROPOSED UNDERGROUND UTILITIES INSTALLATION BY OTHERS IS NOT PART OF THE SCOPE OF THIS PROJECT UNLESS OTHERWISE SHOWN.


 APPROXIMATE LOCATION OF WATER UTILITY BUILT UNDER SEPARATE CONTRACT ASSUMED TO BE IN PLACE AT THE TIME OF THIS PROJECT'S CONSTRUCTION.





STA 220+30 TO STA 220+50


PROJECT NAME: NORTHFIELD
PROJECT NUMBER: BF 024I(58)


FILE NAME: 219J223xs.dgn PROJECT LEADER: K. SMITH DESIGNED BY: K. HO ROADWAY CROSS SECTIONS SHEET I PLOT DATE: 5/29/2025
DRAWN BY: T. MARQUETTE
CHECKED BY: C. JENNE
SHEET 77 OF 102

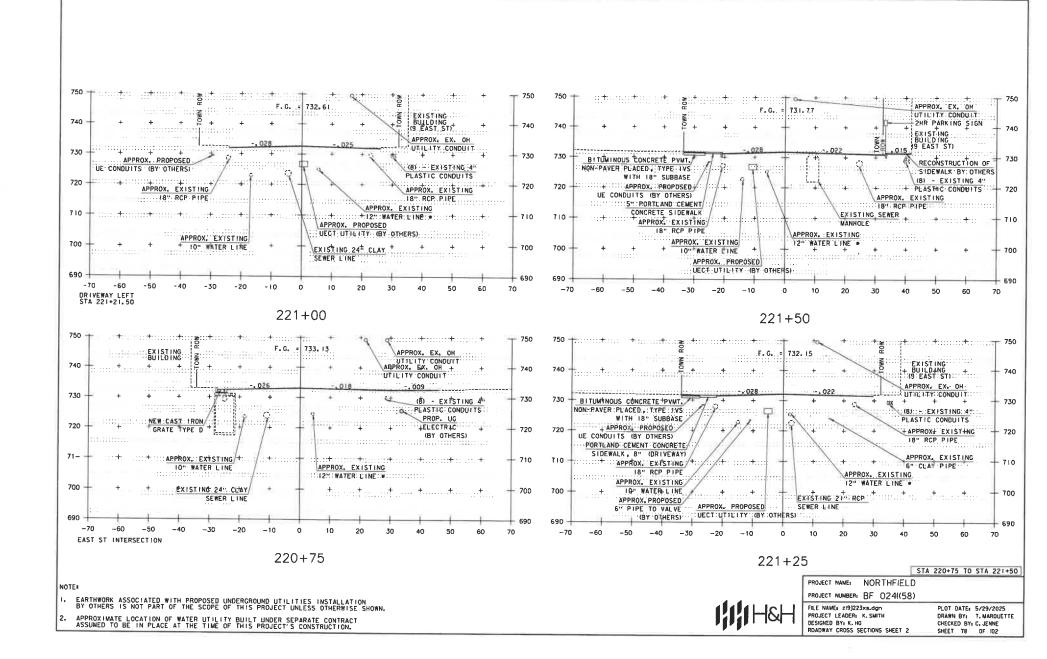


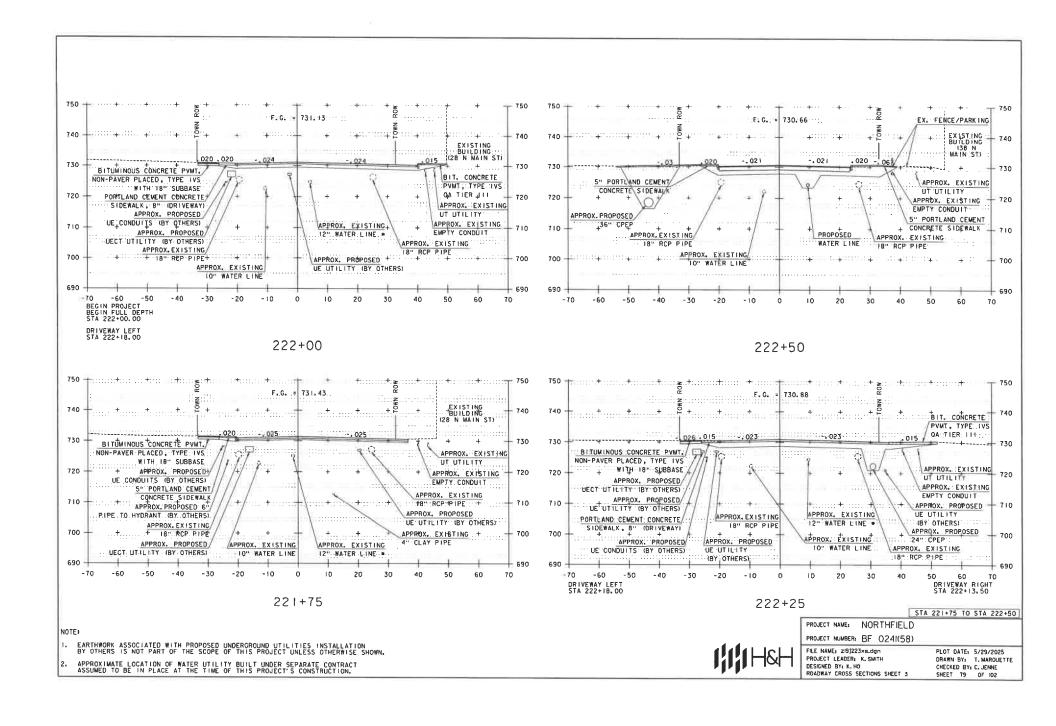


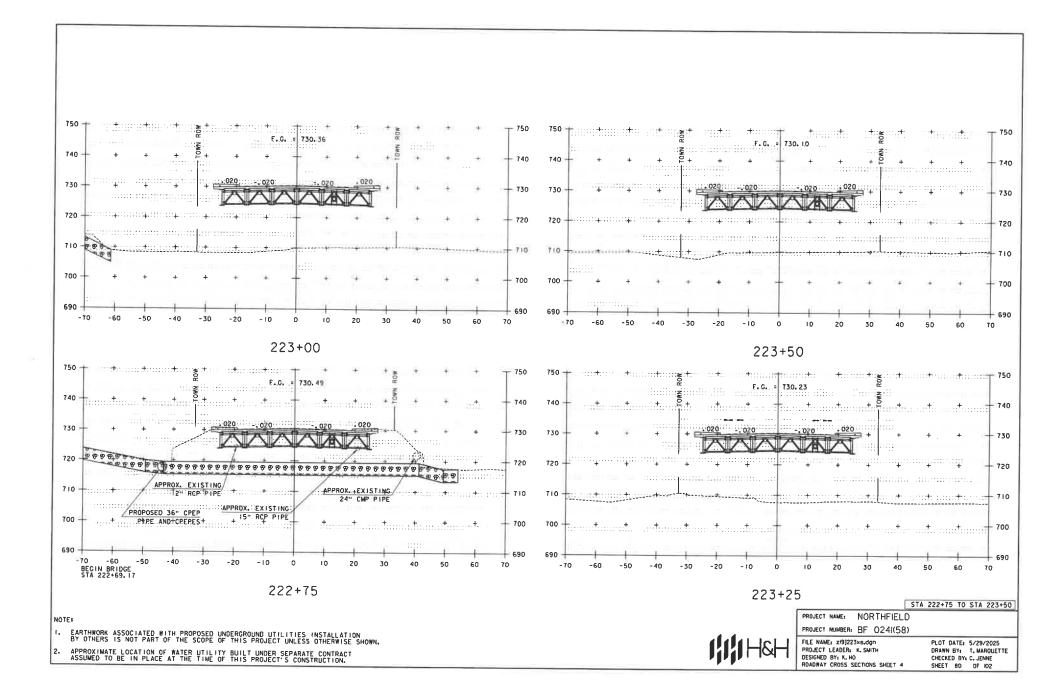


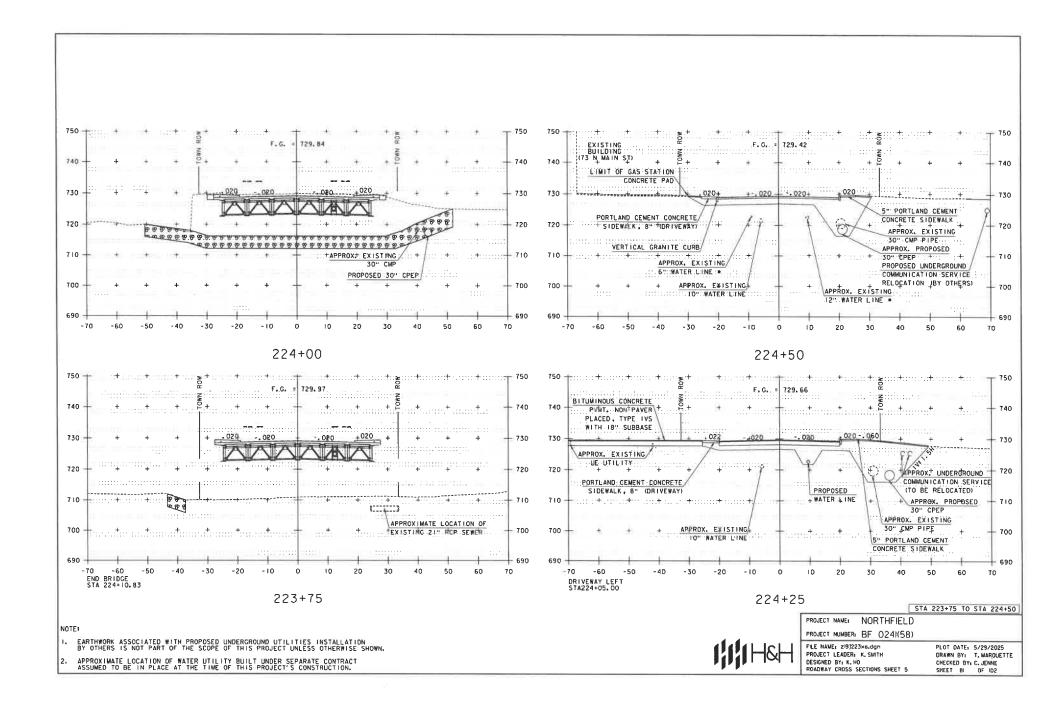

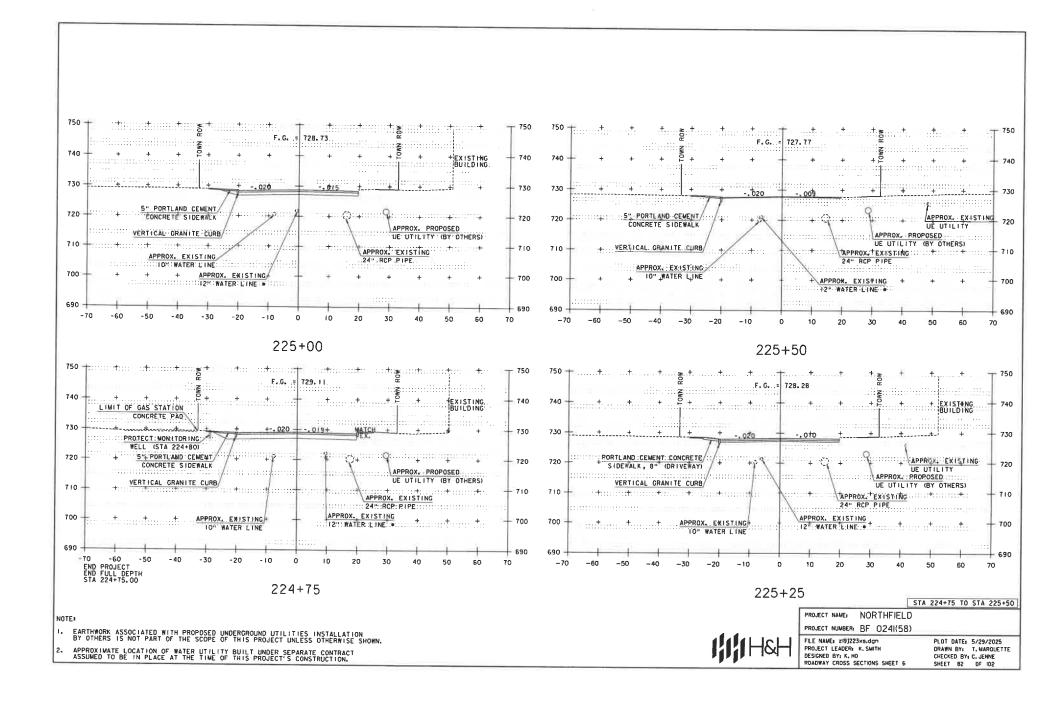

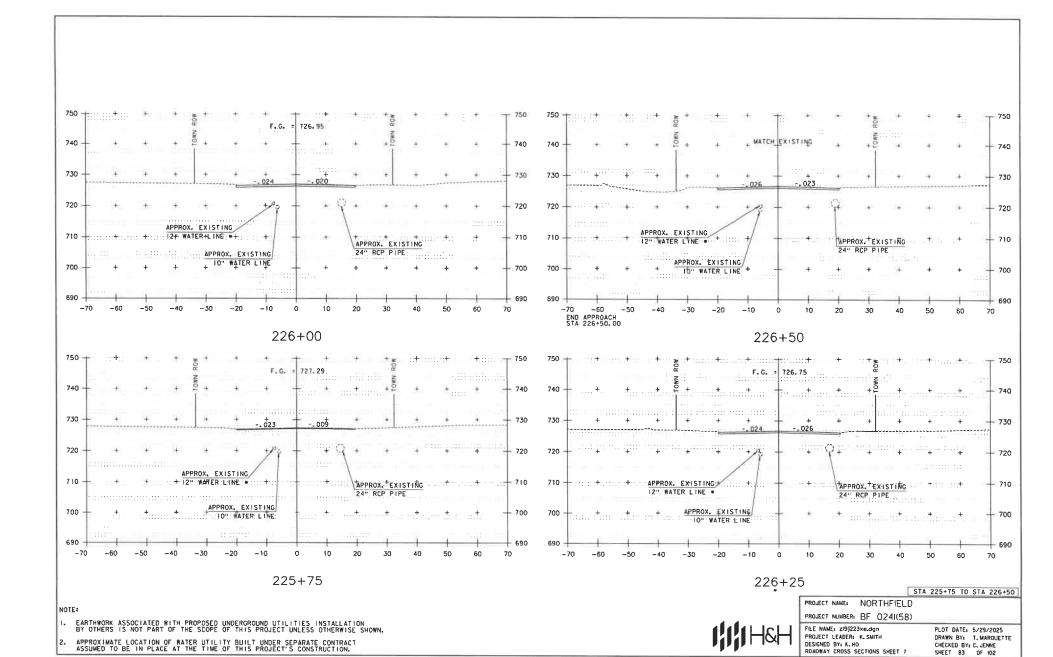

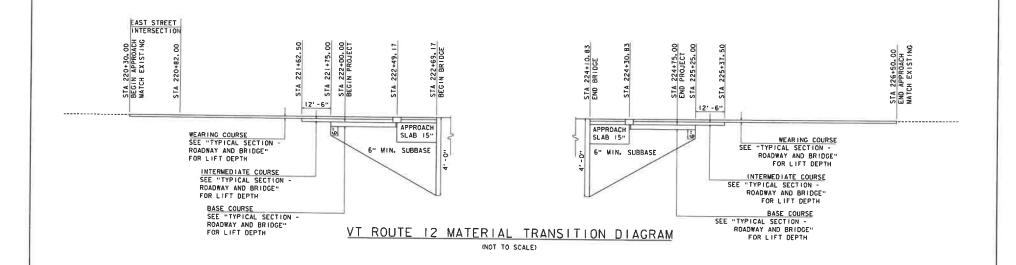

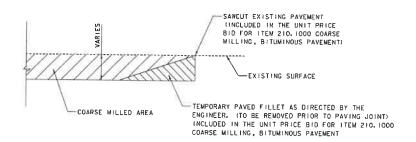


DETAIL AT VERTICAL COARSE MILLING JOINTS

NOTE: THIS DETAIL SHALL BE USED AT THE LOCATIONS SHOWN ABOVE AS DIRECTED BY THE ENGINEER.

HAH

PROJECT NAME: NORTHFIELD
PROJECT NUMBER: BF 024(58)

FILE NAME: z19J223m+d.dgn PROJECT LEADER: K. SMITH DESIGNED BY: K. HO MATERIAL TRANSITION DIAGRAM PLOT DATE: 5/29/2025 DRAWN BY: T. MARQUETTE CHECKED BY: C. JENNE SHEET 84 DF 102

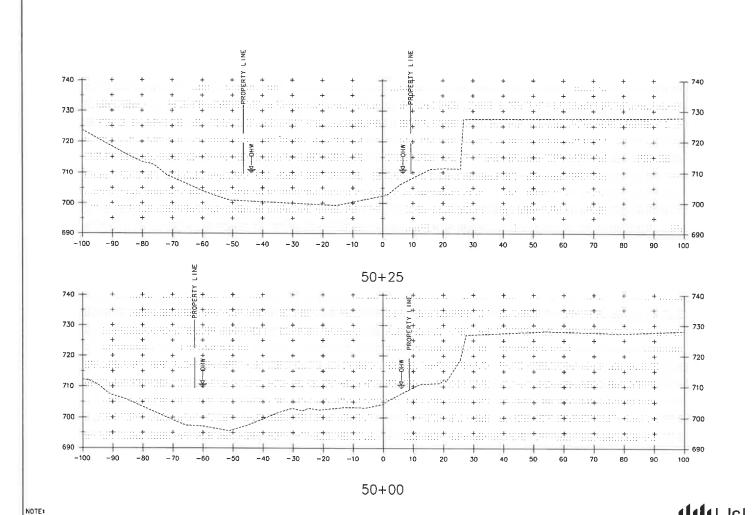


STA 50+00.00 TO STA 50+25.00

PROJECT NAME: NORTHFIELD

PROJECT NUMBER: BF 0241(58)

FILE NAME: zi9j223xs.chonnel.dgn PROJECT LEADER: K. SMITH DESIGNED BY: K. HO CHANNEL CROSS SECTIONS SHEET I PLOT DATE: 5/29/2025 DRAWN BY: T. MARQUETTE CHECKED BY: C. JENNE SHEET 85 OF 102

. EARTHWORK ASSOCIATED WITH PROPOSED WALLS, BRIDGE AND DRAINAGE ELEMENTS ARE SHOWN SCHEMATICALLY AND FOR REFERENCE PURPOSES ONLY.

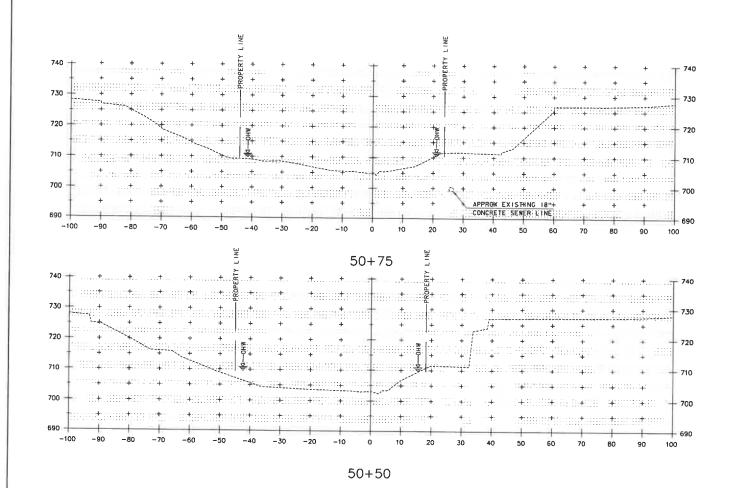

NOTES


EARTHWORK ASSOCIATED WITH PROPOSED WALLS, BRIDGE AND DRAINAGE ELEMENTS ARE SHOWN SCHEMATICALLY AND FOR REFERENCE PURPOSES ONLY.


STA 50+50.00 TO STA 50+75.00

PROJECT NAME: NORTHFIELD PROJECT NUMBER: BF 024(58)

FILE NAME: 219]223xs.chonnel.dgn PROJECT LEADER: K. SMITH OESIGNED BYs K. HO CHANNEL CROSS SECTIONS SHEET 2

PLOT DATE: 5/29/2025 DRAWN BY: 7. MARQUETTE CHECKED BY: C. JENNE SHEET 86 OF 102

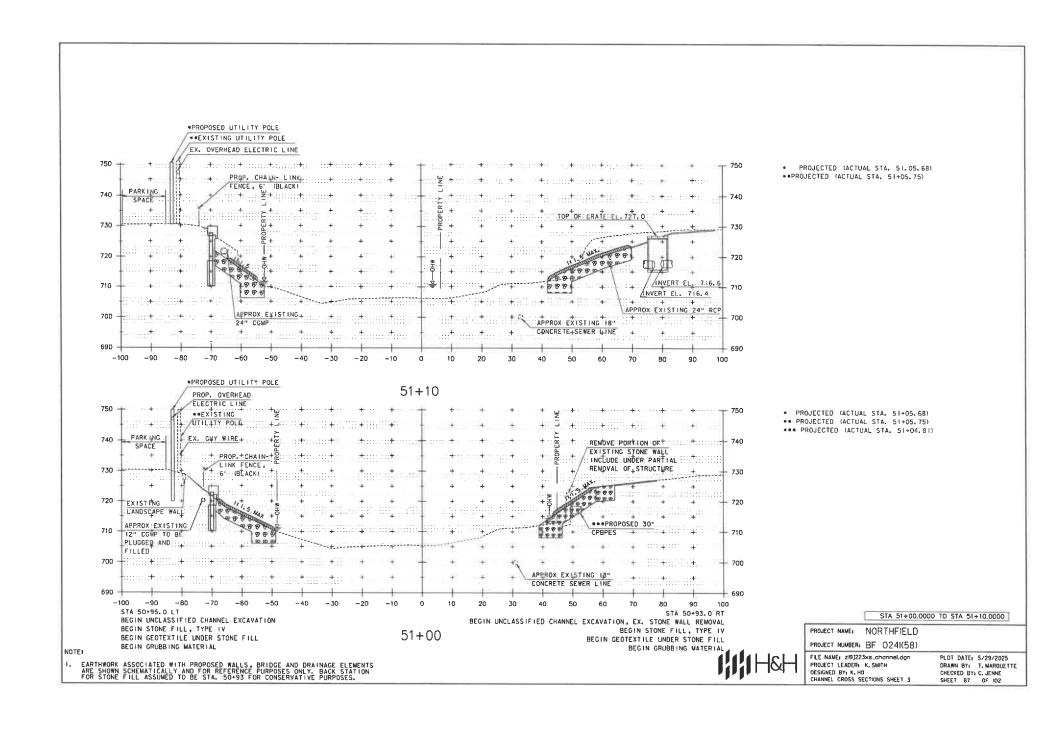

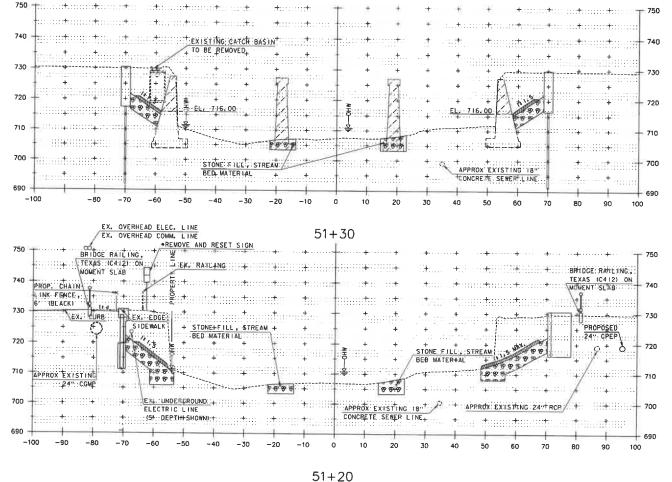

* SEE SIGN AND LINE TABLE SHEET FOR DETAIL

STA 51+20.0000 TO STA 51+30.0000

PROJECT NAME: NORTHFIELD PROJECT NUMBER: BF 0241(58)


FILE NAME: zi91223xs_channel.dan PROJECT LEADER: K, SMITH

DESIGNED BY: K. HO CHANNEL CROSS SECTIONS SHEET 4

PLOT DATE: 5/29/2025 DRAWN BY: T. MARQUETTE CHECKED BY: C. JENNE SHEET 88 OF 102

NOTER

EARTHWORK ASSOCIATED WITH PROPOSED WALLS, BRIDGE AND DRAINAGE ELEMENTS ARE SHOWN SCHEMATICALLY AND FOR REFERENCE PURPOSES ONLY.

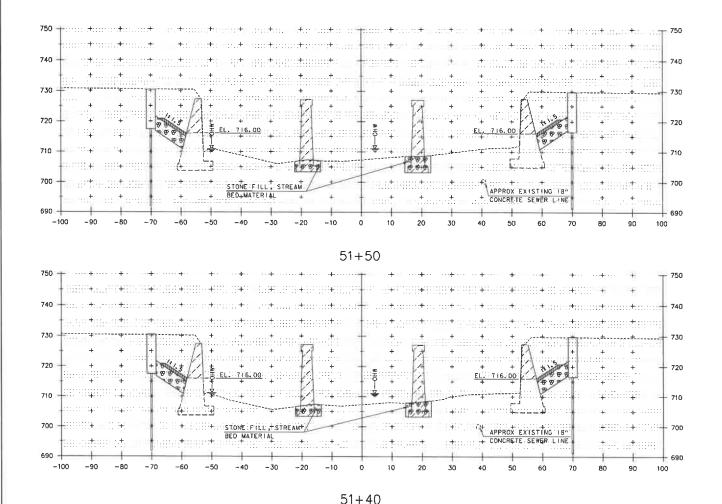

STA 51+40,0000 TO STA 51+50,0000

PROJECT NAME: NORTHFIELD
PROJECT NUMBER: BF 0241(58)


FILE NAME: zi9j223xs_channel,dan

PROJECT LEADER: K. SMITH
DESIGNED BY: K. HO
CHANNEL CROSS SECTIONS SHEET 5

PLOT DATE: 5/29/2025
DRAWN BY: T. MARQUETTE
CHECKED BY: C. JENNE
SHEET B9 OF 102

NOTE:

1. EARTHWORK ASSOCIATED WITH PROPOSED WALLS, BRIDGE AND DRAINAGE ELEMENTS ARE SHOWN SCHEMATICALLY AND FOR REFERENCE PURPOSES ONLY.

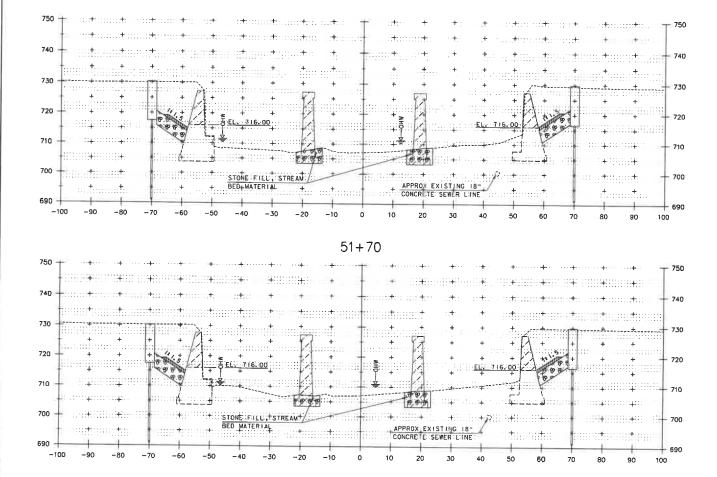

51 + 60

STA 51+60.0000 TO STA 51+70.0000


PROJECT NAME: NORTHFIELD
PROJECT NUMBER: BF 0241(58)

FILE NAME: z19J223xs_channel.dgn PROJECT LEADER: K. SMITH DESIGNED BY: K. HO CHANNEL CROSS SECTIONS SHEET 6

PLOT DATE: 5/29/2025 DRAWN BY: T. MARQUETTE CHECKED BY: C. JENNE SHEET 90 OF 102

EARTHWORK ASSOCIATED WITH PROPOSED WALLS, BRIDGE AND DRAINAGE ELEMENTS ARE SHOWN SCHEMATICALLY AND FOR REFERENCE PURPOSES ONLY.

NOTE:

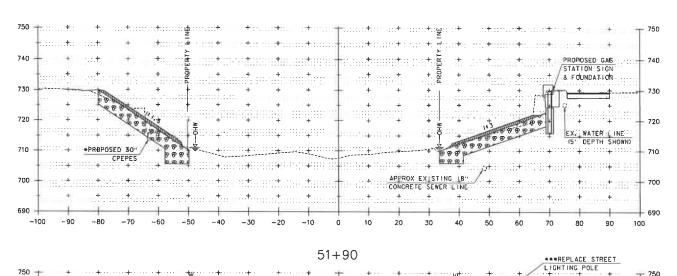

* PROJECTED (ACTUAL STA. 51+94.2)

- * PROJECTED (ACTUAL STA. 51+82.0) ** PROJECTED (ACTUAL STA, 51+81.4) ***SEE LIGHTING PLAN SHEET FOR DETAIL
- LIGHTING POLE **750** EX. RAILING BRIDGE RAILING. 4 TEXAS (C412) ON BRIDGE RATILING , MOMENT SLAB TEXAS (C412) ON **EX. FIRE 740 MOMENT SLAB 730 720 MONITORTNG #ELL + *EX. WATER VALVE 710 B 80 80 180 80 80180 APPROX EXISTING 18" .:: CONCRETE: SEWER: LINE:: 700 STONE FILL, STREAM 700 CONTRACTOR TO FIELD VERFEY - MAINTAIN+ AND PROTECT SEWER) 690 -70 -60 -30 -20 100

STA 51+80.0000 TO STA 51+90.0000

PROJECT NAME: NORTHFIELD

PROJECT NUMBER: BF 0241(58)


FILE NAME: zi9j223xs.channel.dgn PROJECT LEADER: K. SMITH DESIGNED BY: K. HO CHANNEL CROSS SECTIONS SHEET T

PLOT DATE: 5/29/2025 DRAWN BY: T. MARQUETTE CHECKED BY: C. JENNE SHEET 91 OF 102


51+80

NOTE:

EARTHWORK ASSOCIATED WITH PROPOSED WALLS, BRIDGE AND DRAINAGE ELEMENTS ARE SHOWN SCHEMATICALLY AND FOR REFERENCE PURPOSES ONLY.

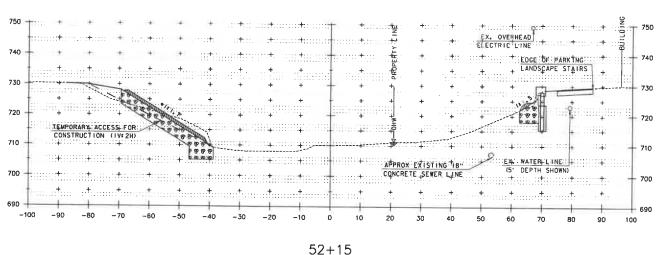

* IS I. 5 SLOPE MEASURED NORMAL TO CONTOUR

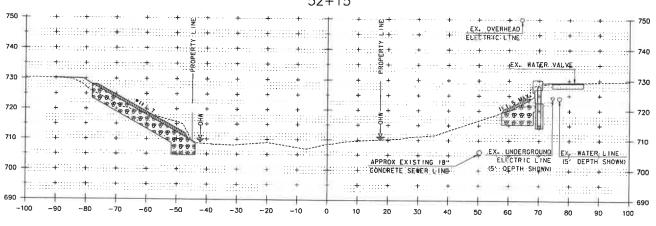

* I: 1.5 SLOPE MEASURED NORMAL TO CONTOUR

STA 52+00.00 TO STA 52+15.00

PROJECT NAME: NORTHFIELD

PROJECT NUMBER: BF 0241(58)

FILE NAME: zi9]223xe_channel.dgn


PROJECT LEADER: K, SMITH
DESIGNED BY: K. HO
CHANNEL CROSS SECTIONS SHEET B

PLOT DATE: 5/29/2025 DRAWN BY: T. MARQUETTE CHECKED BY: C. JENNE SHEET 92 OF 102

52+00

NOTE:

 EARTHWORK ASSOCIATED WITH PROPOSED WALLS, BRIDGE AND DRAINAGE ELEMENTS ARE SHOWN SCHEMATICALLY AND FOR REFERENCE PURPOSES ONLY.

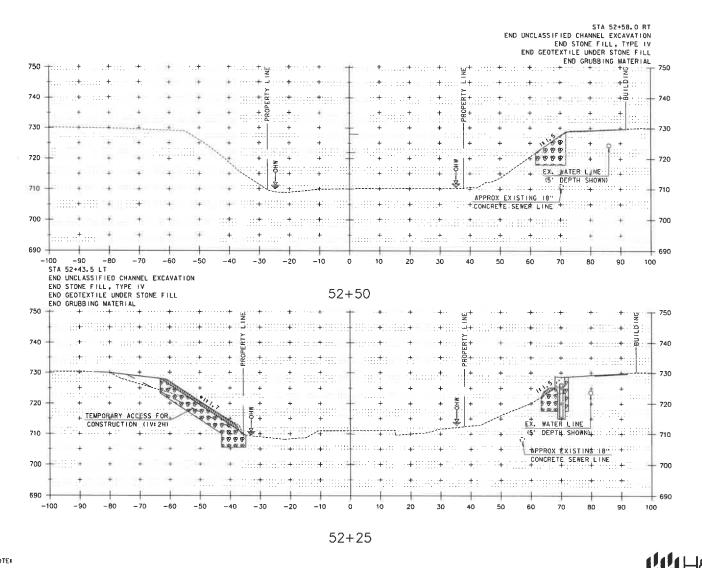

* I: I.5 SLOPE MEASURED NORMAL TO CONTOUR

STA 52+25.00 TO STA 52+50.00


PROJECT NAME: NORTHFIELD PROJECT NUMBER: BF 0241(58)

FILE NAME: zi9]223xs_channel.dgn

PROJECT LEADERS K. SMITH DESIGNED BY: K. HO CHANNEL CROSS SECTIONS SHEET 9 PLOT DATE: 5/29/2025 DRAWN BY: T. MARQUETTE CHECKED BY: C. JENNE SHEET 93 OF 102

NOTE:

EARTHWORK ASSOCIATED WITH PROPOSED WALLS, BRIDGE AND DRAINAGE ELEMENTS ARE SHOWN SCHEMATICALLY AND FOR REFERENCE PURPOSES ONLY.

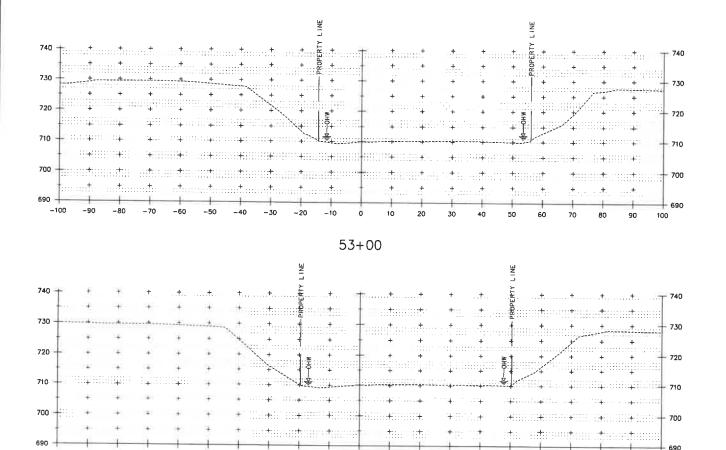

-30 -20

-10

52 + 75

STA 52+75.00 TO STA 53+00.00

PROJECT NAME: NORTHFIELD

PROJECT NUMBER: BF 0241(58)

FILE NAME: z19323xs_chonnel.dgn PROJECT LEADER: K. SMITH DESIGNED BY; K. HO CHANNEL CROSS SECTIONS SHEET IO

PLOT DATE: 5/29/2025 DRAWN BY: 1. MARQUETTE CHECKED BY: C. JENNE SHEET 94 OF 102

 EARTHWORK ASSOCIATED WITH PROPOSED WALLS, BRIDGE AND DRAINAGE ELEMENTS ARE SHOWN SCHEMATICALLY AND FOR REFERENCE PURPOSES ONLY.

NOTE

EPSC PLAN NARRATIVE

1. PROJECT DESCRIPTION

THIS PROJECT INVOLVES THE REPLACEMENT OF BRIDGE 60 WITH RELATED ROADWAY APPROACH WORK.
BRIDGE 60 OVER DOG RIVER IS LOCATED IN THE TOWN OF NORTHIFIELD, ON YT ROUTE 12,
APPROXIMATELY 1.1 MILES NORTH OF THE JUNCTION WITH YT ROUTE 12A SOUTH. THE PROJECT
LOCATION BEGINS AT MILE POST 4.197 (STA 222400,00) AND ENDS AT MILE POST 4.249 (STA 224475,00),

THE NEW STRUCTURE WILL BE APPROXIMATELY 141.66 FEET IN LENGTH WITH 133.34 FEET OF ROADWAY WORK, CONSTRUCTED ON NEW FOOTINGS ALONG THE SAME ALIGNMENT.

NOTE: AREA OF DISTURBANCE INCLUDES LIMITS OF EARTH DISTURBANCE WITHIN THE PROJECT AREA, AS WELL AS WASTE, BOROW AND STAGING AREA, AND OTHER EARTH DISTURBING ACTIVITIES WITHIN OR DIRECTLY ADJACENT TO THE PROJECT LIMITS AS SHOWN ON THE ATTACHED ESSE PLAN.

IT IS ANTICIPATED THAT CONSTRUCTION WILL LAST ONE CONSTRUCTION SEASON.

2. AMOUNT OF DISTURBANCE & RISK EVALUATION

TOTAL AREA OF DISTURBANCE AS SHOWN ON THE ATTACHED EPSC PLAN IS APPROXIMATELY 0.92 ACRES.

THE MAXIMUM CONCURRENT EARTH DISTURBANCE USED TO SCORE THIS PROJECT IN APPENDIX A RISK ASSESSMENT IS 2 ON ACRES

ANY MODIFICATIONS TO THE PROJECT THAT INCREASE THE RISK TO ENVIRONMENTAL RESOURCES SHALL BE EVALUATED IN ACCORDANCE WITH THE PERMIT REQUIREMENTS. THE CONTRACTOR WILL BE RESPONSIBLE FOR ANY ADDITIONAL PERMITTING.

3. MAJOR COMPONENTS & SEQUENCING

THE CONTRACTOR SHALL SEQUENCE CONSTRUCTION ACTIVITIES TO MINIMIZE THE EXTENT OF DISTURBED SOILS LEFT OPEN TO EROSION AT ANY GIVEN TIME. PROJECT DEMARCATION FENCING WILL BE INSTALLED AT THE PROJECT LIMITS. EROSION PREVENTION AND SEDIMENT CONTROLS WILL BE UTILIZED, AS SHOWN IN THE PLANS, THROUGHOUT THE DURATION OF CONSTRUCTION. THE EXISTING SUPERSTRUCTURE AND PORTIONS OF THE EXISTING ADUTMENTS AND PRESS WILL BE REMOVED. EXCAVATION AND GRADING WILL TAKE PLACE AT THE PROPOSED ABUTMENTS. WATER DIVERSION AND DEWATERING WILL BE UTILIZED BY THE CONTRACTOR TO ACCESS THE EXISTING PIERS. EXISTING PAYEMENT AND ROJADWAY BASE WILL BE EXCAVATED AND REPLACED WITH THE PROPOSED ROJADWAY AT THE APPROACHES, PROPOSED UTILITIES WILL BE PLACED CONCURRENTLY WITH THE PROPOSED ROJADWAY AT THE APPROACHES, PRIES AND PIECCAPS WILL BE INSTALLED, FOLLOWED BY THE STELL BEAMS, DECK, AND APPROACH SLABS. FOLLOWING BY THE STELL BEAMS, DECK, AND APPROACH SLABS. FOLLOWING BY THE STELL BEAMS, DECK, AND APPROACH SLABS. FOLLOWING BY THE STELL BEAMS, DECK, AND APPROACH SLABS. FOLLOWING FINAL GRADING, TURF WILL BE ESTABLISHED ON DISTRIBED AREAS, PROPOSED SIDEWALKS WILL BE INSTALLED, AND PAVEMENT WILL BE PLACED. LASTLY, ALL EROSION PREVENTION AND SEDIMENT CONTROL TEXTS WILL BE PROVED.

4. SITE DESCRIPTION

4.1 VEGETATED BUFFERS

MAINTAINING VEGETATED BUFFERS ALONG STREAM BANKS, WETLANDS OR OTHER SENSITIVE AREAS IS A CRUCIAL EROSION AND SEDIMENT CONTROL MEASURE THAT SHOULD BE IMPLEMENTED WHEREVER POSSIBLE.

THIS PROJECT DOES NOT RELY ON VEGETATED BUFFERS AS A MITIGATING RISK FACTOR,

4.2 STREAM CROSSINGS

THIS PROJECT INCLUDES (1) STREAM CROSSINGS, AS DESCRIBED IN SECTION 5.1 BELOW. WORK WITHIN THE WATER IS BEING AUTHORIZED THROUGH THE VANR DEC RIVER MANAGEMENT PROGRAM AND THE US ARMY CORPS OF ENGINEERS.

4.3 WETLANDS

THERE ARE NO WETLANDS OR WETLAND BUFFERS BEING IMPACTED WITHIN THE PROJECT LIMITS.

4.4 TOPOGRAPHY

THE TOPOGRAPHY OF THE PROJECT AREA IS GENERALLY FLAT. THE BRIDGE IS LOCATED IN A DOWNTOWN VILLAGE SETTING, WITH A CROSSWALK LOCATED AT THE NORTH OF THE BRIDGE AND ON-STREET PARKING LOCATED JUST OFF THE SOUTH END OF THE BRIDGE RESTLED BETWEEN DRIVEWAYS, COMMERCIAL BUSINESSES WITH PAVED PARKING LOTS ARE LOCATED JALONG THE SOUTHWEST AND NORTHWEST QUADRANTS. THERE IS A COMMERCIAL BUSINESS WITH CORRESPONDING DRIVEWAY LOCATED JUST OUTSIDE OF THE PROJECT LIMITS IN THE NORTHEAST QUADRANT.

4.5 VEGETATION

THE VEGETATION IN THE PROJECT AREA CONSISTS OF INTENTIONALLY PLANTED AND NATURALLY OCCURING DECIDIOUS TREES, SHRUBS, AND HERBACEOUS GROWTH. THERE IS MOWED GRASS FRONTAGE ALONG THE SOUTHEAST AND NORTHEAST OF DATAT WHICH IS DIRECTLY AFFECTED BY THE PROJECT. UPON COMPLETION, THE DISTURBED VEGETATION SHALL BE RESTABLISHED WITH LIVE STAKES, DECIDIOUS TREES AND SHRUBS, SEED, AND MULCH PER THE LANDSCAPE PLAN.

4.6 SOILS

ALL SOIL DATA CAME FROM THE U.S. DEPARTMENT OF AGRICULTURE NATURAL RESOURCES CONSERVATION SERVICE. SOILS ON THE PROJECT SITE INCLUDE:

MACHIAS FINE SANDY LOAM, 3 TO 8 PERCENT SLOPES, "K FACTOR" = 0.20 COLTON GRAVELLY SANDY LOAM, 3 TO 8 PERCENT SLOPES, "K FACTOR" = 0.17

ADDITIONALLY, THERE ARE CONTAMINATED SOILS AND POTENTIAL HAZARDOUS WASTE WITHIN THE PROJECT LIMITS. PER VANR HAZARDOUS STESS ARE LOCATED IN THE NORTHWEST AND SOUTHWEST QUADRANTS OF THE PROJECT, AND A HAZARDOUS STESS ARE LOCATED IN THE NORTHEAST GUADRANT. THERE IS ALSO AN UNDERGROUND STORAGE TANK LOCATED IN THE NORTHWEST QUADRANT. THE ENTIRE PROJECT STEE IS LOCATED WITHIN A MAPPED URBAN SOILS BACKGROUND AREA. THE DISTURBANCE OF SOILS WITHIN THE PROJECT AND THE METHOD BY WHICH THEY ARE HANDLED, TRANSPORTED, AND DISPOED OF WILL BE IN COMPULANCE WITH THE SOIL MANAGEMENT PLAN THAT HAS BEEN PREPARED FOR THIS PROJECT.

NOTE: K-VALUES GENERALLY INDICATE THE FOLLOWING: 0.0-0.23 = LOW EROSION POTENTIAL 0.24-0.36 = MODERATE EROSION POTENTIAL 0.37 AND HIGHER = HIGH EROSION POTENTIAL

4.7 OTHER SENSITIVE RESOURCES

WHILE RRIDGE 60 IS NOT A HISTORICALLY SIGNIFICANT STRUCTURE, IT IS LOCATED WITHIN THE VERNORT STATE REGISTER-LISTED DEPOT SQUARE HISTORIC DISTRICT. THREE CONTRIBUTING BUILDINGS TO THE DEPOT SQUARE HISTORIC DISTRICT ARE LOCATED AT THE SOUTHEASTERN CORNER OF THE BRIDGE; 38 NORTH MAIN STREET, AND 9 EAST STREET. THE CONTRACTOR SHALL NOT TEMPORARILY OR PERMANENTLY IMPACT ANY OF THESE PROPERTIES JURING CONSTRUCTION OF THIS PROJECT. IF ANY OF THE AFOREMENTIONED PROPERTIES ARE AFFECTED, SECTION 4(F) REVIEW WILL BE NECESSARY UNDER THAN REGULATION 23 CFR 774. THE NEW STRUCTURE'S DESIGN, MATERIALS, MASSING, RAILING AND ANY OTHER PERMANENT FEATURES SHALL BE COMPATIBLE WITH THE HISTORIC DISTRICT.

5. DRAINAGE

5.1 RECEIVING WATERS

DOG RIVER, A WATER-COURSE REGULATED BY THE US ARMY CORPS OF ENGINEERS, IS A NORTH-FLOWING TRIBUTARY OF THE WINDOSKI RIVER, AND IS THE ONLY WATER SOURCE ON THE PROJECT SITE. MUNICIPAL WATER SUPPLIES WATER TO RESIDENCES AND BUSINESSES IN THE IMMEDIATE VICINITY OF THE BRIDGE, THE DOG RIVER IS PROME TO A MODERATE TO HIGH DEBRIS LOAD, AND THE STREAM BED CONSISTS OF GRAVEL, COBBLES AND BOULDERS. THE TRIBUTARY AREA AT THE BRIDGE CROSSING IS 9.6 MILES?

5.2 DISCHARGE POINTS

THIS PROJECT HAS THREE DISCRETE DISCHARGE POINTS WHICH CONVEY RUNOFF FROM WITHIN THE CURBED AREAS OF THE ROADWAY INTO THE RECEIVING WATER FROM DRAINGE OUTFALLS. OUTSIDE OF THE CURBED AREAS, ALL WATER FROM THE PROJECT AREA DRAINS TOWARD THE RIVER AND ENTERS THE RECEIVING WATER IN MULTIPLE LOCATIONS IN THE AREAS DIRECTLY ADJACENT TO THE BRIDGE.

5.3 CONVEYANCE/FLOW PATH FROM PROJECT TO WATERS

A PORTION OF THE PROJECT IS NOT CURRED AND RUNOFF DRAINS OVERLAND ACROSS ADJACENT VEGETATED SIDE SLOPES BEFORE REACHING THE DOG RIVER, FOR THE REMAINING CURBED SEGMENTS, THERE EXIST A NUMBER OF DROP INLETS THAT COLLECT ROADWAY RUNOFF WHICH DRAIN TO OUTFALLS IN THE SOUTHWEST, NORTHEAST AND SOUTHEAST QUADRANTS VIA 24" DRAINAGE PIPES THAT EXTEND TOWARDS THE DOG RIVER STREAMBAIN.

6. EROSION PREVENTION AND SEDIMENT CONTROL MEASURES

THE MEASURES INCLUDED IN THIS PLAN ARE PROVIDED AS A GUIDELINE FOR PREVENTING EROSION AND CONTROLLING SEDIMENT TRANSPORT. IT IS EXPECTED THAT THE CONTRACTOR MAY USE THIS PLAN, WITH ADJUSTMENTS AS NECESSARY, BASED ON THEIR SPECIFIC MEANS AND METHODS OF CONSTRUCTION.

APPLYING THESE MEASURES THROUGHOUT CONSTRUCTION IS CRITICAL TO THEIR SUCCESS IN MINIMIZING SEDMENT TRANSPORT TO THE RECEIVING WATERS. REFER TO THE DETAILS INCLUDED IN THESE PLANS AND THE DEPARTMENT OF ENVIRONMENTAL CONSERVATION'S VERMIONT STANDARDS AND SPECIFICATIONS FOR EROSION PREVENTION AND SEDMENT CONTROL FOR SPECIFIC GUIDANCE.

6.1 IDENTIFY LIMITS OF DISTURBANCE

SITE BOUNDARIES AND AREAS CONSTRUCTION EQUIPMENT CAN ACCESS SHALL BE DELINEATED.

PROJECT DEMARCATION FENCING (POF) SHALL BE USED TO PHYSICALLY MARK SITE BOUNDARIES. BARRIER FENCE SHALL BE USED INSTEAD OF PROJECT DEMARCATION FENCE WITHIN 100 FEET OF A WATER RESOURCE (STREAM, BROOK, LAKE, POND, WETLAND, ETC.)

6.2 LIMIT CONCURRENT DISTURBANCE

LIMITING THE AMOUNT OF SOIL EXPOSED AT ONE TIME REDUCES THE POTENTIAL EROSION ON SITE. CONCURRENT EARTH DISTURBANCE CAN BE MINIMIZED THROUGH CONSTRUCTION PHASING BY ONLY OPENING UP EARTH AS NECESSARY AND EMPLOYING STABILIZATION PRACTICES IN INCREMENTAL STAGES AS PHASES CHANGE.

6.3 STABILIZE DISTURBED AREAS

6.3.1 ACCESS POINTS/ENTRANCE/EXITS

TRACKING OF SEDIMENT ONTO PUBLIC HIGHWAYS SHALL BE MINIMIZED TO REDUCE THE POTENTIAL FOR RUNOFF ENTERING BECEIVING WATERS. INSTALLATION SHALL COINCIDE WITH THE CONTRACTORS PROGRESS CHEQULE.

STABILIZED CONSTRUCTION ENTRANCES ARE ANTICIPATED ON THIS PROJECT AND SHALL BE LOCATED AS SHOWN ON THIS EPSC PLAN AND ANYWHERE EQUIPMENT WILL BE GOING FROM AREAS OF EXPOSED SOILS TO PAYED SURFACES.

6.3.2 TEMPORARY MEASURES FOR EXPOSED AREAS DURING CONSTRUCTION

ALL AREAS OF EARTH DISTURBANCE MUST HAVE STABILIZATION IN PLACE WITHIN 14 DAYS OF INITIAL DISTURBANCE. AFTER THIS TIME, DISTURBED AREAS MUST BE STABILIZED IN ADVANCE OF ANY RUNOFF PRODUCING EVENT.

SURFACE ROUGHENING OF EXPOSED SLOPES, SEEDING OF TEMPORARY SLOPES AND STOCKPILES, AND STANDARD MULCHING PRACTICES DESCRIBED IN SPECIFICATION SECTION 653.07 SHALL BE UTILIZED TO TEMPORARILY STABILIZED STURBED AREAS.

6.3.3 PERMANENT STABILIZATION AT FINAL GRADE

EXPOSED SOIL MUST BE STABILIZED WITHIN 48 HOURS OF REACHING FINAL GRADE.

SEED, MULCH, FERTILIZER AND LIME SHALL BE USED TO ESTABLISH PERMANENT VEGETATION. FOR SLOPES STEEPER THAN 1:3, ROLLED EROSION CONTROL PRODUCT, TYPE I SHALL BE USED INSTEAD OF MULCH.

CONTRACT ITEM 613.13 - STONE FILL, TYPE IV SHALL BE USED TO ARMOR THE CHANNEL BANK IN THE VICINITY OF BRIDGE ABUTMENTS AND WINGWALL SLOPES.

6.4 DIVERT UPLAND RUNOFF

DIVERSIONARY MEASURES SHALL BE USED TO INTERCEPT RUNOFF FROM ABOVE THE CONSTRUCTION AND DIRECT IT AROUND THE DISTURBED AREA SO THAT CLEAN WATER DOES NOT BECOME MUDDIED WHILE TRAVELING OVER EXPOSED SOILS ON THE CONSTRUCTION SITE.

THE PROJECT AREA IS RELATIVELY FLAT; HOWEVER, YT ROUTE 12 SOUTH OF THE PROJECT AREA DRAINS TOWARD THE PROJECT AREA. RUNOFF FROM THESE AREAS MAY NEED TO BE DIVERTED AWAY FROM THE PROJECT AREA. THE CONTRACTOR SHALL REFER TO THE LOW RISK HANDBOOK FOR GUIDANCE.

6.5 INSTALL SEDIMENT BARRIERS

SEDIMENT BARRIERS SHALL BE UTILIZED TO INTERCEPT RUNOFF AND ALLOW SUSPENDED SEDIMENT TO SETTLE OUT. THEY SHALL BE INSTALLED ON THE DOWNHILL SIDE OF CONSTRUCTION ACTIVITIES, PRIOR TO ANY UP-SLOPE WORK.

IN-WATER SEDIMENT ISOLATION DEVICE SHALL BE ANY MEASURE WHICH EFFECTIVELY SEPARATES SEDIMENTS OR POLLUTANTS FROM WATERS OF THE STATE AS DEFINED IN THE VERMONT WATER QUALITY STANDARDS,

SILT FENCE WILL BE INSTALLED ALONG THE CONTOURS AND AS PROPOSED ON THE EPSC PLAN. WOVEN WIRE REINFORCED SILT FENCE SHALL BE USED INSTEAD OF SILT FENCE WITHIN 100 FEET UPSLOPE OF RECEIVING WATERS.



PROJECT NAME: NORTHFIELD

PROJECT NUMBER: BF 0241(58)

FILE NAME: z/9)223epsc.norrotive.don PROJECT LEADER: K. SMITH DESIGNED BY: K. HO EPSC NARRATIVE SHEET 1 PLOT DATE: 5/29/2025
DRAWN BY: T. MARQUETTE
CHECKED BY: C. JENNE
SHEET 95 OF 102

6.6 SLOW DOWN CHANNELIZED RUNOFF

CHECK STRUCTURES SHALL BE UTILIZED TO REDUCE THE VELOCITY, AND THUS THE EROSIVE POTENTIAL, OF CONCENTRATED FLOW IN CHANNELS.

TERMPORARY STONE CHECK DAMS ARE NOT ANTICIPATED TO BE NEEDED AS DESIGNED SINCE THE STREAMBED. WITHIN THE PROJECT AREA IS RELATIVELY FLAT, AND THE CHANNEL'S FLOW VELOCITY DOES NOT WARRANT

7. CONSTRUCT PERMANENT CONTROLS

PERMANENT STORMWATER TREATMENT DEVICES SHALL BE INSTALLED AS SHOWN ON THE PLANS AND IN ACCORDANCE WITH PERMIT CONDITIONS

PERMANENT STORMWATER TREATMENT DEVICES ARE NOT ANTICIPATED TO BE NEEDED AS DESIGNED.

8. DEWATERING

DISCHARGE FROM DEWATERING ACTIVITIES THAT FLOWS OFF OF THE CONSTRUCTION SITE MUST NOT CAUSE OR CONTRIBUTE TO A VIOLATION OF THE VERMONT WATER QUALITY STANDARDS. DEWATERED STORMWATER OR GROUNDWATER MUST BE FILTERED AND ROUTED IN A MANNER THAT DOES NOT RESULT. IN VISIBLY TURBID DISCHARGES TO WATERS

DEWATERING OF SURFACE WATER WITHIN THE COFFERDAM IS ANTICIPATED. THE FILTER BAG DETAIL AND PAY ITEM HAVE BEEN INCLUDED AS A POTENTIAL TREATMENT MEASURE FOR THIS PURPOSE, HOWEVER THE SPECIFIC MEANS FOR TREATMENT OF DISCHARGE SHALL BE PROVIDED BY THE CONTRACTOR. ALL COSTS FOR TREATMENT OF DISCHARGE SHALL BE PAID FOR UNDER CONTRACT ITEM 653.45.

9. OFF-SITE AREAS

OFF-SITE WASTE AND BORROW AREAS HAVE NOT BEEN IDENTIFIED FOR THIS PROJECT. IT WILL BE THE CONTRACTOR'S RESPONSIBILITY TO IDENTIFY AND PERMIT, AS NECESSARY, ANY OFF-SITE AREAS THAT ARE NEEDED IN ACCORDANCE WITH STANDARD SPECIFICATIONS 105.25 - 105.28. ALL EROSION PREVENTION AND SEDIMENT CONTROL MEASURES NECESSARY FOR WASTE, BORROW, AND STAGING AREAS OUTSIDE THE PROJECT LIMITS SHALL BE PAID FOR PER 105.29 OF THE STANDARD SPECIFICATIONS FOR CONSTRUCTION.

VEHICLE AND EQUIPMENT STORAGE AREAS OR AREAS ADJACENT TO CONSTRUCTION TRAILERS OR OTHER HIGH TRAFFIC AREAS SHALL BE COVERED WITH GEOTEXTILE FABRIC AND 12" OF GRAVEL. FOLLOWING COMPLETION OF CONSTRUCTION, ALL NON-NATIVE MATERIALS SHALL BE REMOVED FROM THE STAGING AREA. COMPACTED, RUTTED, OR OTHERWISE DISTURBED SOILS SHALL BE TILLED, RAKED, SEEDED AND

ERODIBLE MATERIALS STOCKPILED WITHIN THE MATERIAL STORAGE AREAS SHALL BE ISOLATED WITH SILT FENCE OR OTHER ACCEPTABLE SEDIMENT BARRIER. SOIL STOCKPILED ON THE SITE SHALL BE SEEDED AND

10. WINTER CONSTRUCTION

CONSTRUCTION ACTIVITIES MAY CONTINUE INTO THE WINTER CONSTRUCTION SEASON, DEPENDING ON ACTUAL FIELD AND WEATHER CONDITIONS. IF ACTIVITIES ARE ON-GOING BETWEEN OCTOBER 15 AND APRIL 15, THE CONTRACTOR SHALL FOLLOW REQUIREMENTS FOR WINTER CONSTRUCTION, AS DEFINED IN SPECIFIC PERMIT CONDITIONS AND AS FOLLOWS:

- ENLARGED ACCESS POINTS, STABILIZED TO PROVIDE FOR SNOW STOCKPILING.
 LIMITS OF DISTURBANCE MOVED OR REPLACED TO REFLECT BOUNDARY OF WINTER WORK.
- DEVELOPMENT OF A SNOW MANAGEMENT PLAN THAT INCLUDES:
- ADEQUATE STORAGE AND CONTROL OF MELT-WATER
- STORAGE OF CLEARED SNOW TO BE PLACED DOWN SLOPE OF DISTURBED AREAS AND OUT OF STORMWATER TREATMENT STRUCTURES
- AREAS OF DISTURBANCE WITHIN 100 FT OF A WATERBODY MUST HAVE REINFORCED (WOVEN WIRE) SILT FENCE INSTALLED ACROSS THE SLOPE, DOWNGRADIENT OF THE EARTH DISTURBANCE.
 ALTERNATIVELY, REGULAR, NON-WOVEN WIRE SILT FENCE MAY BE USED IF COMBINED WITH EROSION CONTROL BERM, EROSION LOG, OR STRAW WATTLE.
- DRAINAGE STRUCTURES MUST BE KEPT OPEN AND FREE OF SNOW AND ICE DAMS.
- SILT FENCE AND OTHER PRACTICES REQUIRING EARTH DISTURBANCE MUST BE INSTALLED AHEAD OF
- MULCH TO BE APPLIED AT A MINIMUM OF 2 INCHES DEPTH WITH 80-90% COVERAGE.
- AREAS OF DISTURBED SOILS MUST BE STABILIZED PRIOR TO ANY RUNOFF-PRODUCING EVENT, WITH THE FOLLOWING EXCEPTION:
- STABILIZATION IS NOT REQUIRED IF THE WORK IS OCCURRING IN A SELF-CONTAINED EXCAVATION WITH NO OUTLET AND A DEPTH OF 2 FT OR GREATER (OPEN UTILITY TRENCHES), PROVIDED THAT ANY DEWATERING, IF NECESSARY, IS CONDUCTED AS REQUIRED.
- PRIOR TO STABILIZATION, SNOW OR ICE MUST BE REMOVED TO LESS THAN 1" THICKNESS.
- USE STONE TO STABILIZE AREAS WHERE CONSTRUCTION VEHICLE TRAFFIC IS ANTICIPATED.

11. INSPECTION & MAINTENANCE

INSPECTION AND MONITORING OF THE PROJECT'S EPSC MEASURES SHALL BE CONDUCTED IN ACCORDANCE WITH STANDARD SPECIFICATION 653.04 MONITORING EROSION PREVENTION AND SEDIMENT CONTROL PLAN, ALONG WITH PERMIT SPECIFIC INSPECTION REQUIREMENTS.


THE CONTRACTOR SHALL PROVIDE A COPY OF THEIR INSPECTION FORM AS PART OF THEIR EPSC PLAN.


ALL EPSC MEASURES SHALL BE REGULARLY MAINTAINED AND SHALL BE CHECKED FOR SEDIMENT BUILD-UP. SEDIMENT SHALL BE DISPOSED OF AT AN APPROVED SITE WHERE IT WILL NOT BE SUBJECT TO EROSION.


PROJECT NAME: NORTHFIELD PROJECT NUMBER: BF 0241(58)


FILE NAME: zi9j223epsc_narrative.dan PROJECT LEADER: K. SMITH DESIGNED BY: K. HO EPSC NARRATIVE SHEET 2

PLOT DATE: 5/29/2025 DRAWN BY: T, MARQUETTE CHECKED BY: C. JENNE SHEET 96 OF 102

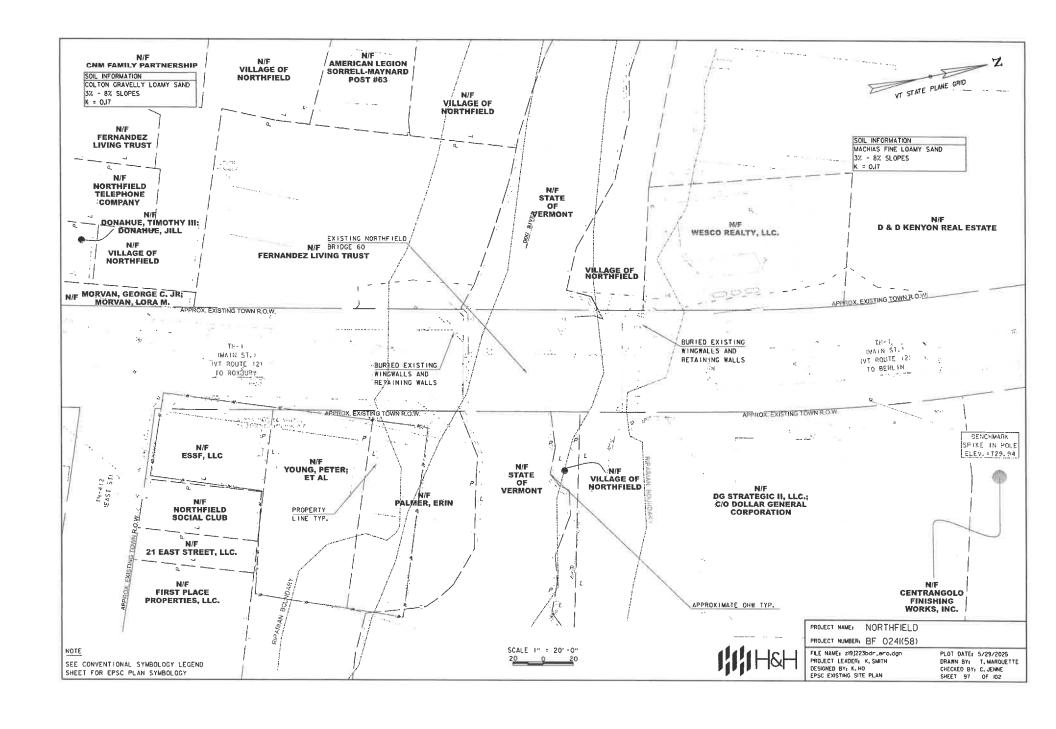

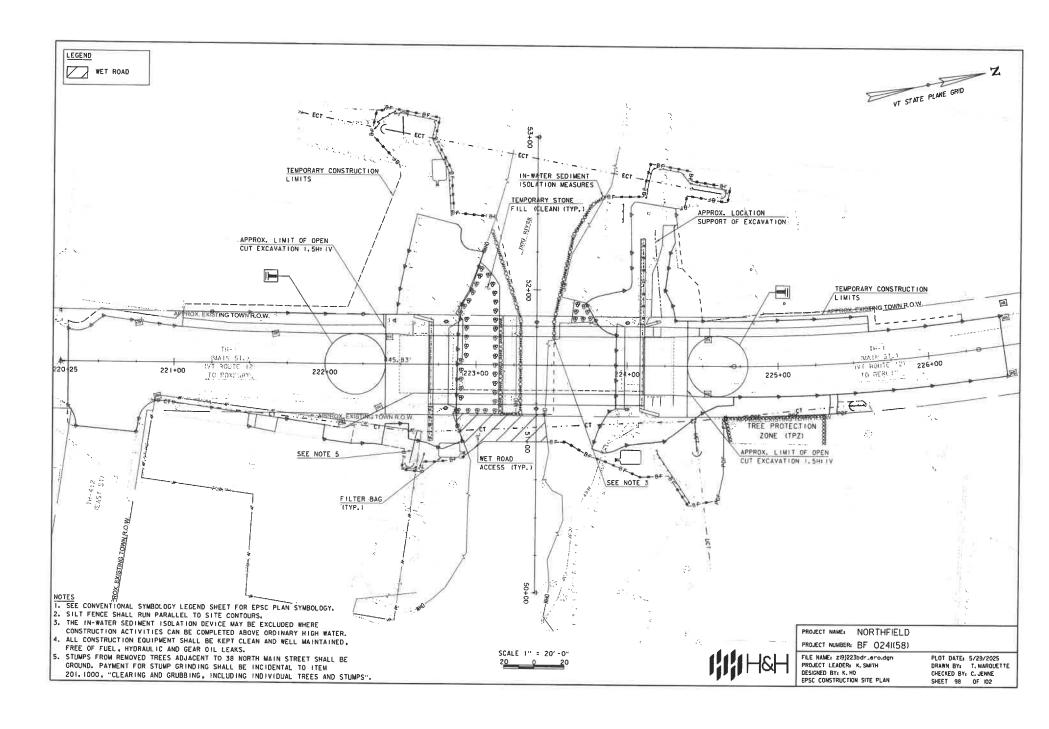

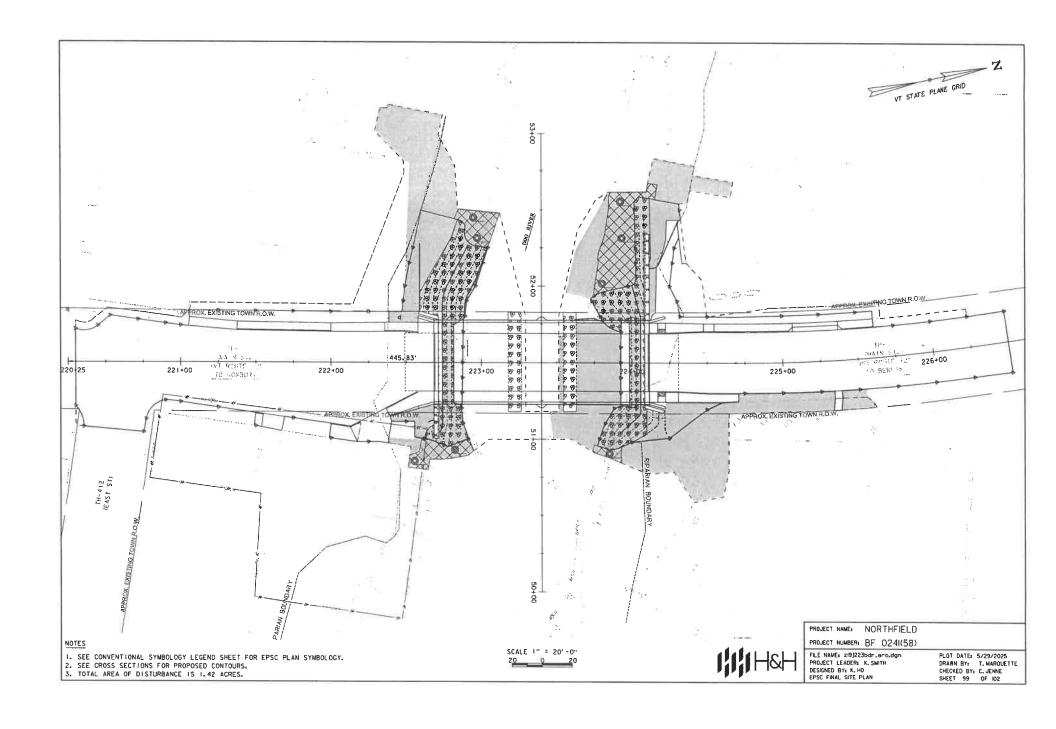

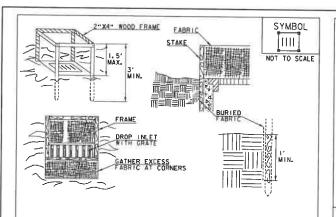

CONSTRUCTION SPECIFICATIONS

- 1. FILTER FABRIC SHALL HAVE AN APPARENT OPENING SIZE OF 40-85. BURLAP MAY BE USED FOR SHORT TERM APPLICATIONS.
- 2. CUT FABRIC FROM A CONTINUOUS ROLL TO ELIMINATE JOINTS. IF JOINTS ARE NEEDED THEY WILL BE OVERLAPPED TO THE NEXT STAKE.
- 3. STAKE MATERIALS WILL BE STANDARO 2"× 4" WOOD OR EQUIVALENT METAL WITH A MINIMUM LENGTH OF 3'.
- 4.SPACE STAKES EVENLY AROUND INLET 3' APART AND DRIVE A MINIMUM 18" DEEP. SPANS GREATER THAN 3' MAY BE BRIDGED WITH THE USE OF WIRE MESH BEHIND THE FILTER FABRIC FOR SUPPORT.
- 5. FABRIC SHALL BE EMBEDDED I' MINIMUM BELOW GROUND AND BACKFILLED. IT SHALL BE SECURELY FASTENED TO THE STAKES AND FRAME.
- 6. A 2" × 4" WOOD FRAME SHALL BE COMPLETED AROUND THE CREST OF THE FABRIC FOR OVER FLOW STABILITY.
- 7. MAXIMUM DRAINAGE AREA I ACRE


ADAPTED FROM DETAILS PROVIDED BY NEW YORK STATE DEC ORIGINALLY DEVELOPED BY USDA-NRCS VERMONT DEPARTMENT OF ENVIRONMENTAL CONSERVATION

FILTER FABRIC DROP INLET PROTECTION

REFER TO "THE VERMONT STANDARDS & SPECIFICATIONS FOR EROSION PREVENTION & SEDIMENT CONTROL -2006- "FROM THE YT AGENCY OF NATURAL RESOURCES FOR ADDITIONAL GUIDANCE.

THIS WORK SHALL BE PERFORMED IN ACCORDANCE WITH SECTION 653 FOR INLET PROTECTION DEVICE, TYPE KPAY

REVISIONS	
MARCH 7, 2008	WHF
JANUARY 13, 2009	WHE

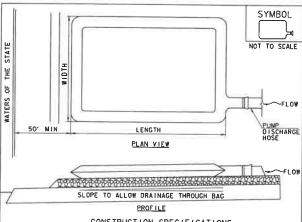

CONSTRUCTION SPECIFICATIONS

- I. THE PRIMARY PURPOSE OF FILTER BAG IS TO RETAIN SILT, SAND, AND FINES DURING DEWATERING OPERATIONS.
- 2. FILTER BAGS SHALL BE INSTALLED ON A VEGETATED SLOPE GRADED TO ALLOW INCOMING WATER TO FLOW THROUGH THE BAG.
- 3. FILTER BAGS MAY ALSO BE PLACED ON COARSE AGGREGATE, STONE, OR HAYBALES TO INCREASE FILTRATION EFFICIENCY,
- 4. FILTER BAGS SHALL BE LOCATED A MINIMUM OF 50' FROM WATERS OF THE STATE UNLESS OTHERWISE APPROVED BY THE ENGINEER.
- 5. THE NECK OF THE FILTER BAG SHALL BE STRAPPED TIGHTLY TO THE DISCHARGE HOSE.
- 6. A FILTER BAG IS FULL WHEN IT NO LONGER CAN EFFICIENTLY FILTER SEDIMENT OR ALLOW WATER TO PASS AT A REASONABLE RATE.
- 7. FILTER BAG SHALL BE DISPOSED OF AS APPROVED IN THE EPSC PLAN OR AS DIRECTED BY THE ENGINEER.

FILTER BAG

NOTES:

REFER TO "THE VERMONT STANDARDS & SPECIFICATIONS FOR EROSION PREVENTION & SEDIMENT CONTROL -2006- FROM THE VT AGENCY OF NATURAL RESOURCES FOR ADDITIONAL

THIS WORK SHALL BE PERFORMED IN ACCORDANCE WITH SECTION 653 FOR FILTER BAG (PAY ITEM 653.4500) AND AS SPECIFIED IN THE CONTRACT.

REVISIONS MARCH 24, 2008 WHF JANUARY 13, 2009 WHF

			VAOT URBAN L	AWN MIX		
LBS/AC						
WEIGHT	BROADCAST	HYDROSEED	NAME	LATIN NAME	GERM	PURITY
42.5%	34	68	CREEPING RED FESCUE	FESTUCA RUBRA X RUBRA	85%	98%
20.0%	16	32	PERENNIAL RYE GRASS	LOLIUM PERENNE	90%	95%
32.5%	26	52	KENTUCKY BLUE GRASS	POA PRATENSIS	85%	85%
5.0%	- 4	8	ANNUAL RYE GRASS	LOLIUM MULTIFLORUM	85%	95%
100%	80	160		1		

GENERAL	AMENDMEN	T GUIDANCE
FERTILIZER	LIME	
		PELLITIZED
500 LBS/AC	2 TONS/AC	1 TONS/AC

CONSTRUCTION GUIDANCE

- I.SEED MIX: THE URBAN AREA MIX SHALL NOT BE USED IN WETLANDS OR ANY WATERS OF THE STATE OF VERMONT.
- 2. SEED MIXE USE ONLY AS INDICATED IN THE PLANS.
- 3. SEED MIX: SHALL NOT HAVE A WEED CONTENT EXCEEDING 0.40% BY WEIGHT AND SHALL BE FREE OF ALL NOXIOUS SEED.
- 4-FERTILIZER AND LIMESTONE: SHALL FOLLOW RATES SHOWN ON PLAN OR AS DIRECTED BY THE ENGINEER
- 5.HAY MULCH: TO BE PLACED ON EARTH SLOPES AT THE RATE OF 2 TONS/ACRE, ACHIEVE 90% GROUND COVER OR AS DIRECTED BY THE ENGINEER.
- 6-HYDROSEEDING: ALTHOUGH CUIDANCE IS GIVEN ABOVE THE SITE CONDITIONS AND THE TYPE OF HYDROSEED WILL ULTIMATELY DICTATE THE AMOUNTS AND TYPES OF SOIL AMENDMENTS TO BE APPLIED.
- .TURF ESTABLISHMENT: PLACING SEED, FERTILIZER, LIME AND MULCH PRIOR TO SEPTEMBER IS AND AFTER APRIL IS CAN BETTER ENSURE A VIGOROUS GROWTH OF GRASS.

ADAPTED FROM VTRANS TECHNICAL LANDSCAPE MANUAL FOR ROADWAYS AND TRANSPORTATION FACILITIES TURF ESTABLISHMENT EVISIONS

THIS WORK SHALL BE PERFORMED IN ACCORDANCE WITH SECTION 651 FOR SEED (PAY ITEM 651,1500)


JANUARY 22, 2015 WHF




PROJECT NAME: NORTHFIELD PROJECT NUMBER: BF 0241(58)

FILE NAME: z/9)223epsc_det,dgn PROJECT LEADER: K, SMITH DESIGNED BY: K. HO EPSC DETAILS ~ I

PLOT DATE: 5/29/2025 DRAWN BY: T. MARQUETTE CHECKED BY: C. JENNE SHEET 100 OF 102

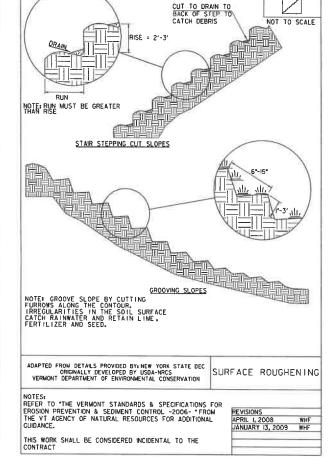


SYMBOL

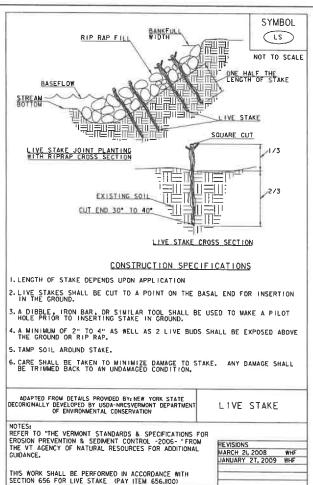



PROJECT NAME: NORTHFIELD PROJECT NUMBER: BF 0241(58)

FILE NAME: zi9j223epsc.det,dgn PROJECT LEADER: K.SMITH DESIGNED BY: K.HO EPSC DETAILS - 2 PLOT DATE: 5/29/2025
DRAWN BY: T. MARQUETTE
CHECKED BY: C. JENNE
SHEET 101 OF 102

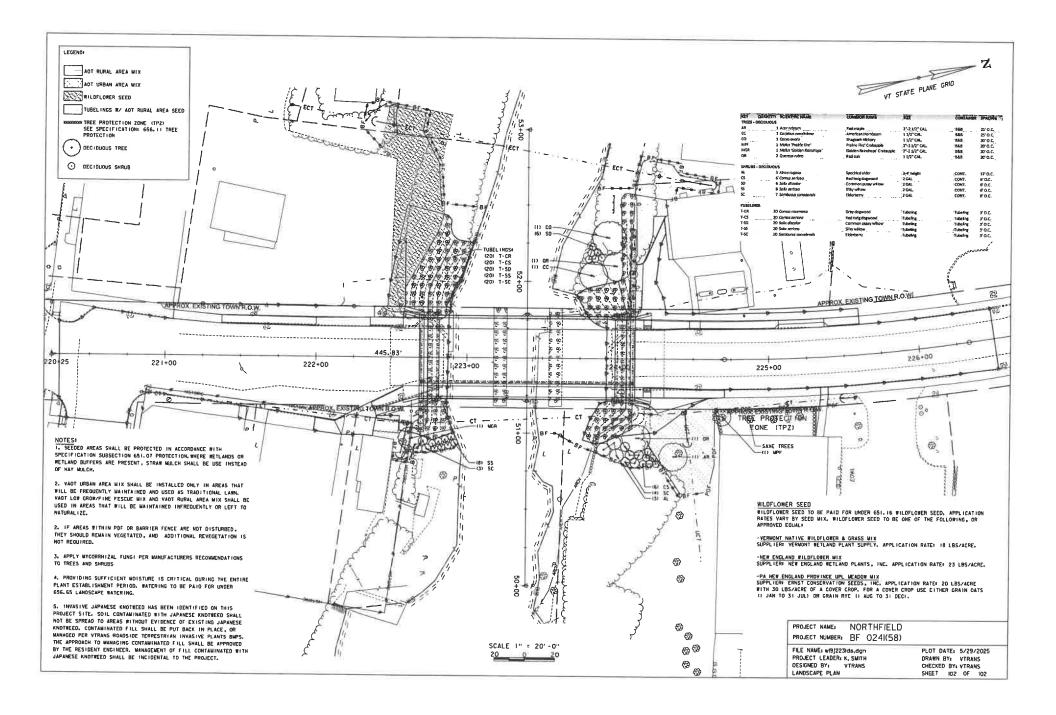

TOWN OF NORTHFIELD, VERMONT SELECT BOARD REGULAR MEETING Minutes of July 22, 2025

I. ROLL CALL. Chair Charles Morse, Board members K. David Maxwell, Lydia Petty, Merry Shernock (absent), and John Stevens. Also present were Manager Jeff Schulz, Acting Clerk Kenneth McCann, Pierre Gomez (Northfield Police Chief), Ron Tucker (RE Tucker, Inc.), Sherrie Tucker (RE Tucker, Inc.), Anne Donahue (Vermont State Representative), Tim Swartz (Accessibility, Walkability, and Pedestrian Safety [AWPS] Task Force), Dan Anderson (AWPS Task Force), Mary Nadon Scott (AWPS Task Force), DeLane McIlvene (AWPS Task Force), Janan Hamm (AWPS Task Force), Bill Clements (AWPS Task Force), Royal DeLegge (Chair, Planning Commission), Jeremy Whalen (Chair, Town Forest Stewardship Committee), Gerard LaVarnway, Lorna Doney, Don Doyon, Susan Stillinger, Laura Hill-Eubanks, Carolyn Stevens, Pam Ricker, and Elroy C. Hill.

Chair Morse called the meeting to order at 7:00 p.m.

II. SET/ADJUST AGENDA. (7:02 p.m.) Chair Morse said Gary Laroche from the Vermont Agency of Transportation (VTrans) was to address the Select Board members tonight about the Main Street Bridge Replacement Project but had to postpone his presentation for another time. He did email this afternoon and reported that the original cost estimate for this project (\$8,000,000) has now increased to \$11,500,000. The municipality must pay five percent (5%) of this as a local match amount so there will need to be a discussion at the next budget meetings regarding how to pay for this.

III. PUBLIC PARTICIPATION (SCHEDULED):

- Ron Tucker & Sherrie Tucker, RE Tucker, Inc.: Availability of Tucker Sand Pit for a. Municipal Purchase. (7:03 p.m.) Chair Morse said R.E. Tucker, Inc. has sold road material to the Northfield Highway Department for several years. They have a sand pit located off Vermont Route 12A that they are willing to sell to the municipality with an estimated 100,000 cubic yards of road material. Mr. Tucker said they want to sell the sand pit due to increasing business permitting costs as well as higher shared costs for maintaining a railroad bridge on the property. Mr. Tucker felt the municipality should be able to handle both these costs better due to less stringent permitting rules for municipalities and the possibility of obtaining grant funds for railroad bridge maintenance. It also might be possible to create a public road running through the site to lower the bridge maintenance costs. The Tuckers have an initial sale price of \$600,000 for the sand pit and Mr. Tucker said it should provide a lifetime of sand and gravel for the community. He also noted that it has become more difficult in recent years for Vermont highway departments to obtain acceptable road materials. Board member Stevens asked if the sale price included the railroad bridge. Mr. Tucker confirmed that it did and noted that there is a migrating right-of-way for a property located above the sand pit. The municipality would need to maintain the roadway for the property owner once the right-of-way has been established. Chair Morse said this matter would need to be investigated further by the Select Board members (perhaps by the Highway Subcommittee?) before they can enter into negotiations with the Tuckers regarding the sale price, etc. Mr. Tucker fully understands this and said this was just a preliminary outreach to determine if there is any municipal interest in a possible sale. Chair Morse said the municipality would need to conduct a cost-benefit analysis (CBA) as it probably would need to borrow funds to complete the purchase. Mr. Tucker will provide the Select Board members with all the information they will require to make this decision. There had been earlier negotiations with the Town of Braintree to purchase the sand pit and that documentation will be provided as well. Mr. Tucker hopes that once all the relevant information has been provided, a site visit can be scheduled as part of the negotiation process. Chair Morse then thanked the Tuckers for bringing forward this proposal and said the Select Board members will remain in touch.
- b. Anne Donahue, Vermont State Representative: Habitat for Humanity. (7:27 p.m.)

 Ms. Donahue said she was not here as a state representative tonight but rather as Interim Chair for a Habitat for Humanity committee that is working on a proposal to build a duplex building that would provide two (2) Northfield families with affordable housing. The location would be the vacant lot at the intersection of North Main Street and Dogwood Glen Drive.

 Ms. Donahue said the RFPs for this project have already been distributed and there will be a community meeting held this fall in order to fully describe the project. Her committee will be holding a meeting tomorrow night where they will finalize the flyer for this community meeting. Ms. Donahue added that Northfield Economic Development Director (EDD) Town Davis has attended several of their past meetings and has been of great assistance.

Board member Maxwell asked if there are eligibility criteria for the new homeowners. Ms. Donahue said the committee would determine eligibility and a major factor is whether the new homeowners would be able to make their mortgage payments. In addition, one of the families must be headed by a veteran. Board member Petty thanked Ms. Donahue and the other Habitat for Humanity committee members for working on this project.

- Tim Swartz, Accessibility, Walkability, and Pedestrian Safety Task Force: C. Pedestrian Safety Improvements (Warning Signs, Roadside Trimming, etc.). (7:36 p.m.) Mr. Swartz said he and the other AWPS Task Force members have been on the lookout for locations in the community that present pedestrian safety hazards. They have identified a few locations including near the new flashing crosswalk sign in Northfield Falls. Mr. Swartz felt drivers travelling southward towards the crosswalk don't see the new crosswalk sign until it is too late because of the sharp curve north of the crosswalk. Therefore, it would be very helpful to have a warning sign installed further north of the crosswalk approach. In addition, there are some areas where roadside bushes, shrubs, and tree branches need to be trimmed in order to create greater visibility for pedestrian crossings, road signs, etc. Mr. Swartz will provide a full list of these locations to Manager Schulz and the Select Board members. Manager Schulz said he has contacted VTrans about the need to make the Northfield Falls crosswalk more visible and also is working with them to improve road drainage in the area. He noted, however, that working with VTrans usually includes some delay before the requested work is actually completed. Bill Clements also is concerned about pedestrian safety when detours are put in place for the Main Street Bridge Replacement project scheduled for next year. He had hoped to ask Mr. Laroche about this as he has concerns about the diversion of traffic mostly along Water Street while the bridge is closed. This is a heavy traffic area and he had hoped to see some significant pedestrian safety measures installed that might include temporary traffic lights, etc. Mr. Clements said the AWPS Task Force members will be watching for any developments regarding pedestrian safety as the bridge replacement project develops. Chair Morse noted that an early decision was to bar heavy tractor trailers from the traffic detours along Wall Street, Water Street, etc. He does agree that more needs to be done to ensure pedestrian safety during this project. Manager Schulz said VTrans has submitted its final project plans and these do include improved pedestrian safety measures that include barricades, etc. Chair Morse feels there will need to be a full discussion with VTrans representatives about this matter. He then thanked Mr. Swartz and the other AWPS Task Force members for bringing their concerns to the attention of the Select Board members.
- Royal DeLegge, Planning Commission Chair: Town Forest Zoning Issues. (7:55 d. p.m.) Mr. DeLegge said that the Planning Commission (PC) members worked last year on updating the local zoning regulations to make them fully compliant with new state laws and more user-friendly. Since then, the PC members have been working on additional upgrades that included addressing public concerns that the current zoning regulations do not provide sufficient protection from future development for the Town Forest. The PC members have looked at several options such as further revising the zoning regulations, establishing conservation easements for some or all of the Town Forest, etc. They recently have focused on defining a "Forest Reserve Overlay District." The purpose of a this district "is to produce wood products, maintain wildlife habitat, protect water supplies, and provide forest recreation and conservation education. Within the Forest Reserve Overlay District, permitted uses include sustainable commercial forestry and related uses, and all other land development is prohibited." Mr. DeLegge said he and the other PC members wanted to learn how the Select Board members would feel about this course of action before proceeding further. Board member Petty thanked the PC members for working on this as she feels (along with many Northfield residents) that protection of the Town Forest is a very important concern. She asked if Cheney Field would be included in this district. Mr. DeLegge said they only have a preliminary map of the area to be included in this district. The boundaries of the district can be changed very easily if requested. This is what makes a Forest Reserve Overlay District very different from an easement, which is very difficult to adjust once it has been adopted. Board member Maxwell also thanked Mr. DeLegge and the PC members for the work they have done on this to date. He added that his chief concern regarding Town Forest protection is to make sure that the water supply on Cheney Field is not impeded by any new land use restrictions. Mr. DeLegge said there would be no problem in excluding Cheney Field from the new district. Chair Morse asked if there has been any PC discussion of establishing an overall easement for the Town Forest. Mr. DeLegge said that possibility has not been a part of their recent conversations.

Chair Morse said he has heard some public views expressed by Northfield Farmers Market patrons stating support for establishing easements for the Town Forest that would ban any future development forever. He then added that the Northfield Conservation Commission (NCC) will be meeting tomorrow night and one agenda item focuses on the future of Cheney Field. Chair Morse then thanked Mr. DeLegge for the valuable information provided tonight.

IV. APPROVAL OF MINUTES

- **a. July 8, 2025 (Regular Meeting). (8:07 p.m.)** Motion by Board member Maxwell, seconded by Board member Stevens, to approve the minutes. Chair Morse requested a minor wording revision. **Motion passed 3-0-1, with Board member Petty abstaining.**
- b. July 11, 2025 (Special Meeting). (8:09 p.m.) Motion by Board member Stevens, seconded by Board member Maxwell, to approve the minutes. Motion passed 4-0-0.
- c. July 15, 2025 (Special Meeting). (8:10 p.m.) Motion by Board member Stevens, seconded by Board member Petty, to approve the minutes. Motion passed 3-0-1, with Board member Maxwell abstaining.

V. APPROVAL OF BILLS

- a. Approval of Warrant #02-26. (8:12 p.m.) Prior to the motion for warrant approval, Chair Morse asked that the invoice submitted by Queen City P.I. be removed from the warrant. This would reduce the warrant amount by \$11,889.80. There was no objection. Motion by Board member Maxwell, seconded by Board member Stevens, to approve Warrant #02-26 in the amount of \$635,448.91. Board member Stevens noted that the allocation for the Brown Public Library was incorrect. It should be \$11,000 and not \$9,334. Manager Schulz said this would be corrected on the next warrant. Motion passed 4-0-0.
- b. Receipt of Biweekly Payroll through July 6, 2025. (8:20 p.m.) Motion by Board member Stevens, seconded by Board member Maxwell, to receive the biweekly payroll in the amount of \$117,300.71. Motion passed 4-0-0.

VI. SELECT BOARD

- **a. Board of Listers Appointment. (8:21 p.m.)** Motion by Board member Stevens, seconded by Board member Petty, to appoint Alexandria Najduch to fill the vacancy on the Board of Listers. **Motion passed 4-0-0.**
- b. Ethics Training Requirements for Municipal Officers. (8:22 p.m.) Chair Morse said there is a new state requirement that certain municipal officers and board members must complete online ethics training. The deadline for completing the initial training course is September 25, 2025 and he felt those persons affected by this requirement should be contacted by letter to inform them of this. Board member Petty noted that there is a limited number of town officials and board members affected by this requirement. The Vermont League of Cities & Towns (VLCT) website has a good list of the municipal officials that fall under this requirement.

VII. TOWN MANAGER'S REPORT

- a. Main Street Water Line and Cheney Farm Tank Replacement Projects. (8:26 p.m.)

 Manager Schulz said the water line project is progressing well and remains on schedule. The work on Prospect Street will be starting soon and he will post notices on local social media so residents are kept aware of the work schedule. The old reservoir tanks on Cheney Farm have been removed from the site and the new water tank will be installed in coming weeks.
- **b. Vine Street Sidewalk Project. (8:26 p.m.)** Manager Schulz said this project also remains on schedule for completion by August 1, 2025.
- c. Property Tax Sale. (8:26 p.m.) Manager Schulz said there are now about fifteen (15) properties that have accumulated at least two (2) years of delinquent taxes. That makes them subject to tax sale. Manager Schulz will be working with the property owners to see if full or partial payments can be made to keep them out of the tax sale. The tax sale is now scheduled for the end of September 2025.
- d. Street Sign Replacement (8:26 p.m.) Manager Schulz said a good number of street signs have been damaged or stolen recently. The missing signs will be replaced as soon as possible. Board member Maxwell said there are traffic sign locks that discourage, if not fully prevent, these type of thefts.

e. New Accounting Department Bookkeeper. (8:27 p.m.) Manager Schulz announced that Kristin Paya has been hired to replace retired bookkeeper Deb O'Grady. Ms. Paya will start work on Monday, August 4, 2025.

VIII. BOARD MEMBERS' COMMENTS, CONCERNS, QUESTIONS

- **a. Main Street Repaving. (8:29 p.m.)** Board member Maxwell asked how much of Main Street will be repaved after the water line project has been completed. Manager Schulz said the area south of the Main Street Bridge to South Street will be fully repaved. Other areas will be patched and the whole street is scheduled for full repaving in about five (5) years.
- **b. Improved Public Notification. (8:34 p.m.)** Board member Petty believes there needs to be better communication with the public regarding the water line project as to when residents' water source is switched over to a temporary line, etc. Manager Schulz said there have been a few occasions when the contractor didn't inform him before making these switchovers. Board member Petty would like additional social media postings about the project so there are no future surprises.
- c. VLCT Compensation Study. (8:36 p.m.) Board member Petty asked if Northfield participates in the annual VLCT compensation study. Manager Schulz said it does and free copies of the completed study are provided to participating municipalities.
- d. Central Vermont Select Board Member Meeting. (8:38 p.m.) Board member Petty attended the meeting of Central Vermont Select Board members hosted by VLCT and the Central Vermont Regional Planning Commission (CVRPC). There was much information provided and she is glad that Northfield doesn't have the same financial problems as those communities that have suffered significant summer storm damage in recent years.
- e. Vermont Youth Conservation Corps (VYCC). (8:39 p.m.) Board member Petty noted the VYCC members have done considerable trail work in the Town Forest recently. Town Forest Stewardship Committee (TFSC) Chair Jeremy Whalen said some work still needs to be done on the Garvey Hill trails located near the public schools.
- f. Clark Road Public Health Problems. (8:40 p.m.) Board member Stevens asked about the current status of this public health concern. Manager Schulz said the municipality went to the environmental court and the people living in a structure without a septic hookup were required to vacate the property. The structure still remains unoccupied. The property owner was fined \$10,000 for allowing the situation to deteriorate. The funds have not yet been collected so the municipality might have to return to the environmental court for relief.
- g. Crosswalk Painting. (8:46 p.m.) Board member Stevens asked when the crosswalk painting would begin. Manager Schulz said the new contractor said it would start next week. He had hired a different contractor in early spring to get the job done sooner but that contractor subsequently went out of business. There will be some crosswalks in the water line project area that will not be repainted at this time.
- h. Vine Street Pedestrian Bridge. (8:48 p.m.) Board member Stevens asked about the planned repairs for this footbridge. Manager Schulz said Daniels Construction will be providing an inspection and repair quotes in the next few weeks.
- i. Slaughterhouse Road Covered Bridge. (8:49 p.m.) Chair Morse has heard complaints from residents living on Slaughterhouse Road above the bridge that the maximum weight limit currently listed for the bridge (6,000 lbs.) is too low. Some want to move hay loads across the bridge that would be in excess of the current weight limit. VTrans will be reevaluating the bridge soon and that should eliminate any confusion.
- IX. PUBLIC PARTICIPATION (UNSCHEDULED). There was none.
- X. ADJOURNMENT. Motion by Board member Stevens, seconded by Board member Maxwell, to adjourn. Motion passed 4-0-0.

The Board adjourned at 8:50 p.m.

Respectfully submitted,

Kenneth L. McCann

Kenneth L. McCann, Acting Clerk

A video recording of this meeting is available at: https://youtu.be/LBWHuLDDCbI

These minutes are subject to approval at the next Select Board regular meeting.

TOWN OF NORTHFIELD

THE UNDERSIGNED HEREBY AUTHORIZE THE EXPENDITURES LISTED HEREIN, ACCORDING TO THE LAWS OF THE STATE OF VERMONT.

DISBURSEMENT DATE:

08/15/25

WARRANT 03-26, 03-26A-F

	NORTHFIELD TOWN SEL	ECT BOARD	
K. DAVID MAXWELL			
CHARLIE MORSE, Chair			
LYDIA PETTY			
MERRY SHERNOCK, Vice Chair			
JOHN B. STEVENS	K.	_	
JEFFREY SCHULZ, Manager			
TOWN CENERAL	06 504 00	ELECTRIC FUND	269,529.31
TOWN GENERAL	96,594.00		
MUNICIPAL PLANNING GRANT	*****	WATER FUND	9,571.47
FLOOD BUYOUT GRANT		SEWER FUND	41,561.58
COMMON FUND			
COMMUNITY DEVELOPMENT FUND	3 		
ARPA FUND	+		
TOWN CIP	99,583.91		
AMBULANCE DONATION FUND	-		
FIRE DONATION FUND			
RECREATION COMMITTEE FUND			
POOL DONATION FUND			
CONSERVATION FUND			
POLICE DONATION FUND			
ENERGY COMMITTEE DONATION FUND			
AGENCY FUND			
SUBTOTAL	\$196,177.91	SUBTOTAL	\$320,662.36

\$516,840.27

GRAND TOTAL

∠025 11:17 | TOWN OF NORTHFIELD | INVOICE LIST BY GL ACCOUNT

Law | INVOICE DIST BT GD ACC

YEAR/PERIOD: 2025/1 TO ACCOUNT/VENDOR	2026/2 DOCUMENT	r voucher	PO YEAR/PR TYP S	WARRANT	DESCRIPTION
10000		TOWN GEN	- BALANCE SHEET		
10000 01340 040191 NEOPOST-NEOFUNDS	86411		UNUSED POSTAGE INVENTORY 0 2025 12 INV A	1,500.00 03-26	6/25/25 POSTAGE
INVOICE: 040191 NEOPOST-NEOFUNDS	86527	FULL DESC:	6/25/25 POSTAGE 0 2026 2 INV A	1,500.00 03-26	JUL 25,2025POSTAGE
INVOICE:		FULL DESC:	JUL 25,2025POSTAGE		
				3,000.00	
			ACCOUNT TOTAL	3,000.00	
10000 02015	86440		PARK DEPOSIT PAYABLE 0 2026 2 INV A	75.00 03-26	7/19 PK DEPOSIT REF
011028 ALLEN, ANGELA INVOICE:	80440	FULL DESC:	7/19 PK DEPOSIT REFUND-PICNIC	73.00 03-20	//IS IN BBIODII NEI
			ACCOUNT TOTAL	75.00	
			ORG 10000 TOTAL	3,075.00	
10130		TOWN MAN			
10130 07010 010495 VERIZON WIRELESS	86581		TELEPHONE 0 2026 2 INV A	25.67 03-26	6/17-7/16 CELL PHON
INVOICE: 6118698477		FULL DESC:	6/17-7/16 CELL PHONE		
042768 TDS TELECOM INVOICE:	86571	FULL DESC:	0 2026 2 INV A 8/4-PHONE 8024855411	67.27 03-26	8/4-PHONE 802485541
			ACCOUNT TOTAL	92.94	
10130 07020 042896 NFLD TOWN GEN FUND	86511		POSTAGE 0 2026 2 INV A	88.29 03-26	JUL 25 POSTAGE
INVOICE:		FULL DESC:	JUL 25 POSTAGE		
			ACCOUNT TOTAL	88.29	
10130 07050			OFFICE SUPPLIES		
035892 MAGEE OFFICE PLUS INVOICE:	86471	FULL DESC:	0 2026 2 INV A 6 CASES 8.5X11 COPY PAPER	59.33 03-26	6 CASES 8.5X11 COPY
055824 TRANS-VIDEO	86575		0 2026 2 INV A	14.17 03-26	AUG25 INTERNET MUN
INVOICE:		FULL DESC:	AUG25 INTERNET MUN BLD		
			ACCOUNT TOTAL	73.50	
9			ORG 10130 TOTAL	254.73	
10140		TOWN CLE	RK/TREASURER		
10140 06220 054400 SYMOUEST GROUP INC.	86568		MAINTENANCE CONTRACTS 0 2026 2 INV A	25.25 03-26	7/25-8/24 PRINTER C
INVOICE: 2018290		FULL DESC:	7/25-8/24 PRINTER CONTRACT		
			ACCOUNT TOTAL	25.25	

08/07/2025 11:17 | TOWN OF NORTHFIELD

|INVOICE LIST BY GL ACCOUNT

| P 2 apinvgla

YEAR/PERIOD: 2025/1 TO ACCOUNT/VENDOR	DOCUMENT			PR TYP S		WARRANT	CHECK	DESCRIPTION
10140 07010 042768 TDS TELECOM INVOICE:	86571	FULL DESC:	TELEPHONE 0 2026 8/4-PHONE 80248	2 INV A 355411	69.91	03-26		8/4-PHONE 802485541
			ACCOUNT	TOTAL	69.91			
10140 07020 042896 NFLD TOWN GEN FUND INVOICE:	86511	FULL DESC:	POSTAGE 0 2026 JUL 25 POSTAGE	2 INV A	1,357.98	03-26		JUL 25 POSTAGE
			ACCOUNT	' TOTAL	1,357.98			
10140 07050 035892 MAGEE OFFICE PLUS INVOICE:	86471	FULL DESC:	OFFICE SUP 0 2026 6 CASES 8.5X11	2 INV A	52.50	03-26		6 CASES 8.5X11 COPY
055824 TRANS-VIDEO INVOICE:	86575	FULL DESC:	0 2026 AUG25 INTERNET	2 INV A	25.07	03-26		AUG25 INTERNET MUN
			ACCOUNT	TOTAL	77.57			
10140 07070 057880 VMCTA INVOICE:	86585	FULL DESC:		NGS/SUBSCRIPTION 2 INV A -J DONEY		03-26		MEMBERSHIP DUES-J D
			ACCOUNT	TOTAL	45.00			
			ORG 10140	TOTAL	1,575.71			
10230		ACCOUNTI	1G					
10230 06010 013521 LAURIE A BAROFFIO INVOICE: 103	86466	FULL DESC:	0 2026 ACCTING/CONSULT		2,700.00			ACCTING/CONSULTING
013521 LAURIE A BAROFFIO INVOICE: 102	86467	FULL DESC:	0 2026 ACCTING/CONSULT	2 INV A ING 7/14-7/27	7,830.00	03-26		ACCTING/CONSULTING
					10,530.00			
			ACCOUNT	TOTAL	10,530.00			
10230 06220 054400 SYMQUEST GROUP INC. INVOICE: 2018290		FULL DESC:		E CONTRACTS 2 INV A ER CONTRACT	57.22	03-26		7/25-8/24 PRINTER C
			ACCOUNT	TOTAL	57.22			
10230 07010 042768 TDS TELECOM INVOICE:	86571	FULL DESC:	TELEPHONE 0 2026 8/4-PHONE 80248	2 INV A 55411	103.35	03-26		8/4-PHONE 802485541
			ACCOUNT	TOTAL	103.35			

08/07/2025 11:17 tlaw

08/07/2025 11:17 | TOWN OF NORTHFIELD

|INVOICE LIST BY GL ACCOUNT

YEAR/PERIOD: 2025/1 TO ACCOUNT/VENDOR	DOCUMENT		R PO YEAR/		WAR	RANT CHECK	DESCRIPTION
10230 07020 042896 NFLD TOWN GEN FUND INVOICE:		FULL DESC:	POSTAGE 0 2026 JUL 25 POSTAGE	2 INV A	106.41 03-:	26	JUL 25 POSTAGE
			ACCOUNT	r TOTAL	106.41		
10230 07050 035892 MAGEE OFFICE PLUS INVOICE:	86471	FULL DESC:	OFFICE SUI 0 2026 6 CASES 8.5X11	2 INV A	52.50 03-	26	6 CASES 8.5X11 COPY
052902 SECURSHRED INVOICE: 497619	86538	FULL DESC:	0 2026 7/24 SHREDDING		24.00 03-2	26	7/24 SHREDDING PICK
055824 TRANS-VIDEO	86575	FULL DESC:	0 2026 AUG25 INTERNET		37.12 03-2	26	AUG25 INTERNET MUN
			ACCOUNT	r total	113.62		
			ORG 10230	TOTAL	10,910.60		
10260 10260 06220 054400 SYMQUEST GROUP INC.		LISTERS	0 2026		8.42 03-2	26	7/25-8/24 PRINTER C
INVOICE: 2018290		FULL DESC:	7/25-8/24 PRINT		8.42		
10260 07010 042768 TDS TELECOM INVOICE:	86571	FULL DESC:	TELEPHONE 0 2026 8/4-PHONE 80248	2 INV A 355411	69.21 03-2	26	8/4-PHONE 802485541
			ACCOUNT	TOTAL	69.21		
10260 07020 042896 NFLD TOWN GEN FUND INVOICE:		FULL DESC:	POSTAGE 0 2026 JUL 25 POSTAGE	2 INV A	1.43 03-2	26	JUL 25 POSTAGE
			ACCOUNT	TOTAL .	1.43		
10260 07050 055824 TRANS-VIDEO INVOICE:	86575	FULL DESC:	OFFICE SUR O 2026 AUG25 INTERNET	2 INV A	25.07 03-2	26	AUG25 INTERNET MUN
			ACCOUNT	TOTAL	25.07		
			ORG 10260	TOTAL	104.13		
10320 10320 07010 010495 VERIZON WIRELESS	86581	FIRE DEP	TELEPHONE 0 2026		20.22 03-2	:6	6/17-7/16 CELL PHON
INVOICE: 6118698477		FULL DESC:	6/17-7/16 CELL	PHONE			

ACCOUNT/VENDOR

053855 SPOTLESS CLEANING

053855 SPOTLESS CLEANING

INVOICE:

06220

10330

86565

tlaw

08/07/2025 11:17 | TOWN OF NORTHFIELD

YEAR/PERIOD: 2025/1 TO 2026/2

INVOICE LIST BY GL ACCOUNT

DOCUMENT VOUCHER PO

CHECK DESCRIPTION 042768 TDS TELECOM 86571 0 2026 2 INV A 38.12 03-26 8/4-PHONE 802485541 INVOICE: FULL DESC: 8/4-PHONE 8024855411 ACCOUNT TOTAL 58.34 10320 08013 ELECTRIC-SOLAR 052905 SENIOR RENEWABLES, L 86539 0 2026 2 INV A 101.87 03-26 BULLRUN SOLAR-JULY INVOICE: 190 FULL DESC: BULLRUN SOLAR-JULY ACCOUNT TOTAL 101.87 10320 08030 043552 NORTHFIELD 86513 2026 2 INV A 28.03 03-26 7/18-FIRE STATION INVOICE: FULL DESC: 7/18-FIRE STATION ACCOUNT TOTAL 28.03 10320 08050 SEWER 043552 NORTHFIELD 86513 2026 2 INV A 29.02 03-26 7/18-FIRE STATION INVOICE: FULL DESC: 7/18-FIRE STATION ACCOUNT TOTAL 29.02 10320 08070 GASOLINE/DIESEL 028560 GILLESPIE FUELS 86377 0 2025 12 INV A 57.82 03-26 21.9 GALS DIESEL 6/ INVOICE: FULL DESC: 21.9 GALS DIESEL 6/5 FD 028560 GILLESPIE FUELS 86378 0 2025 12 INV A 41.45 03-26 15.7 GALS DIESEL 6/ INVOICE: FULL DESC: 15.7 GALS DIESEL 6/9 FD ------99.27 ACCOUNT TOTAL 99.27 ORG 10320 TOTAL 316.53 POLICE DEPARTMENT 10330 10330 06090 JANITORIAL SERVICES 0 2026 2 INV A 053855 SPOTLESS CLEANING 200.00 03-26 6/29-7/5 CLEANING S 86563 INVOICE: FULL DESC: 6/29-7/5 CLEANING SRVCS 0 2026 2 INV A 053855 SPOTLESS CLEANING 86564 200.00 03-26 7/6-7/12 CLEANING S INVOICE: FULL DESC: 7/6-7/12 CLEANING SRVCS

0 2026 2 INV A

0 2026 2 INV A

ACCOUNT TOTAL

FULL DESC: 7/13-7/19 CLEANING SRVCS

FULL DESC: 7/20-7/26 CLEANING SRVCS

YEAR/PR TYP S

P 4

apinvgla

WARRANT

200.00 03-26

200.00 03-26

800.00

800.00

7/13-7/19 CLEANING

7/20-7/26 CLEANING

MAINTENANCE CONTRACTS

08/07/2025 11:17 | TOWN OF NORTHFIELD tlaw

INVOICE LIST BY GL ACCOUNT

,	DOCUMENT		R PO YEAR/F	PR TYP S		WARRANT CHECK	DESCRIPTION
016370 CANON SOLUTIONS AMER INVOICE: 6012714486	86359		0 2025 4/26-7/25 COPIE	12 INV A	97.17		4/26-7/25 COPIER-PD
054400 SYMQUEST GROUP INC. INVOICE: 2011948		FULL DESC:	0 2025 JUNE25 SERVER L	ICENSE PD	1,566.00		JUNE25 SERVER LICEN
054400 SYMQUEST GROUP INC. INVOICE: 2011947	86567	FULL DESC:	0 2026 OFFICE 365-PD 5	/25-5/26	2,160.00	03-26	OFFICE 365-PD 5/25-
					3,726.00		
			ACCOUNT	TOTAL	3,823.17		
10330 06391 055824 TRANS-VIDEO INVOICE:	86576			T RECORDS MGMNT 2 INV A PD	237.98	03-26	AUG25 INTERNET PD
			ACCOUNT	TOTAL	237.98		
10330 07010 010495 VERIZON WIRELESS	86581		TELEPHONE 0 2026	2 INV A	321.86	03-26	6/17-7/16 CELL PHON
INVOICE: 6118698477		FULL DESC:	6/17-7/16 CELL	PHONE			
028854 GOMEZ, PIERRE INVOICE:	86462	FULL DESC:	0 2026 AUG 25 CELL PHO		75.00	03-26	AUG 25 CELL PHONE
042768 TDS TELECOM INVOICE:	86571	FULL DESC:	0 2026 8/4-PHONE 80248		378.63	03-26	8/4-PHONE 802485541
			ACCOUNT	TOTAL	775.49		
10330 07020 042896 NFLD TOWN GEN FUND INVOICE:	86511	FULL DESC:	POSTAGE 0 2026 JUL 25 POSTAGE	2 INV A	19.41	03-26	JUL 25 POSTAGE
			ACCOUNT	TOTAL	19.41		
10330 08013 052905 SENIOR RENEWABLES, L INVOICE: 190	86539	FULL DESC:	ELECTRIC-SG 0 2026 BULLRUN SOLAR-JU	2 INV A	283.07	03-26	BULLRUN SOLAR-JULY
			ACCOUNT	TOTAL	283.07		
10330 08030 043552 NORTHFIELD INVOICE:	86514	FULL DESC:	WATER 0 2026 7/18-PD	2 INV A	28.03	03-26	7/18-PD
			ACCOUNT	TOTAL	28.03		
10330 08050 043552 NORTHFIELD INVOICE:	86514	FULL DESC:	SEWER 0 2026 7/18-PD	2 INV A	29.02	03-26	7/18-PD

08/07/2025 11:17 | TOWN OF NORTHFIELD

INVOICE LIST BY GL ACCOUNT

|P 6 apinvgla

YEAR/PERIOD: 2025/1 TO 2026/2

ACCOUNT/VENDOR	DOCUMENT	VOUCHER	PO	YEAR/PR	TYP S		WARRANT	CHECK	DESCRIPTION

				ACCOUNT T	OTAL	29.02			
10330 08070			(GASOLINE					
042896 NFLD TOWN GEN FUND	86399		0	2025 12	INV A	501.79	03-26		JUNE 25 GAS/DIESEL
INVOICE:		FULL DESC:	JUNE 2	25 GAS/DIESE	L				
042896 NFLD TOWN GEN FUND	86400		0	2025 12	INV A	588.66	03-26		MAY 25 GAS/DIESEL
INVOICE:		FULL DESC:	MAY 25	GAS/DIESEL					
042896 NFLD TOWN GEN FUND	86401		0	2025 12	INV A	581.66	03-26		APRIL25 GAS/DIESEL
INVOICE:		FULL DESC:	APRIL	25 GAS/DIESE	L				
						1,672.11			
053596 SO. VILLAGE	86540		0	2026 2	INV A	29.89	03-26		9.644 GALS GASOLINE
INVOICE: 2981		FULL DESC:							
053596 SO. VILLAGE	86541		0	2026 2	INV A	37.07	03-26		11.587 GALS GAS 7/2
INVOICE: 4946		FULL DESC:	11.587	GALS GAS 7	/2PD				
053596 SO. VILLAGE	86542		0	2026 2	INV A	35.22	03-26		11.009 GALS GAS 7/3
INVOICE: 5143		FULL DESC:	11.009	GALS GAS 7	/3PD				
053596 SO. VILLAGE	86543		0	2026 2	INV A	30.91	03-26		9.662 GALS GAS 7/3
INVOICE: 5192		FULL DESC:	9.662	GALS GAS 7/	3				
053596 SO. VILLAGE	86544		0	2026 2	INV A	35.04	03-26		10.952 GALS GAS 7/8
INVOICE: 6897		FULL DESC:	10.952						
053596 SO. VILLAGE	86546		0	2026 2		24.82	03-26		7.758 GALS GASOLINE
INVOICE: 9455		FULL DESC:			•				
053596 SO. VILLAGE	86548		0	2026 2		35.05	03-26		10.955 GALS GAS 7/1
INVOICE: 637	06550	FULL DESC:				21 25	00.06		0.00= 00=0 = /
053596 SO. VILLAGE	86550	BULL DEGG	0	2026 2		31.37	03-26		9.805 GALS GAS 7/17
INVOICE: 2844 053596 SO. VILLAGE	86551	FULL DESC:	9.805	2026 2		40.05	03.06		10 510 0010 000 7/1
INVOICE: 2678	80331	FULL DESC:	_			40.05	03-20		12.519 GALS GAS 7/1
053596 SO. VILLAGE	86553	TOBE DESC.	0	2026 2		40.63	03-26		13.112 GALS 7/22 PD
INVOICE: 5794		FULL DESC:				20.02			10:110 0:00 // 22 15
053596 SO. VILLAGE	86554		0	2026 2		38.45	03-26		12.406 GALS GAS 7/2
INVOICE: 6418		FULL DESC:	12.406						, , , , , , , , , , , , , , , , , , , ,
053596 SO. VILLAGE	86556		0	2026 2	INV A	10.76	03-26		3.473 GALS GAS 7/25
INVOICE: 8170		FULL DESC:	3.473	GALS GAS 7/2	25				
053596 SO. VILLAGE	86557		0	2026 2	INV A	30.37	03-26		9.801 GALS GAS 7/25
INVOICE: 8173		FULL DESC:	9.801	GALS GAS 7/2	25 PD				
053596 SO. VILLAGE	86558		0	2026 2	INV A	27.57	03-26		8.897 GALS GAS 7/26
INVOICE: 8567		FULL DESC:	8.897	GALS GAS 7/2	26 PD				
053596 SO. VILLAGE	86560		0	2026 2	INV A	24.20	03-26		7.810 GALS GAS 7/30
INVOICE: 8371		FULL DESC:	7.810	GALS GAS 7/3	30 PD				
053596 SO. VILLAGE	86562		0	2026 2		26.09	03-26		8.155 GALS GAS 7/31
INVOICE: 1958		FULL DESC:	8.155	GALS GAS 7/3	31PD				
						407.40			
						497.49			
				ACCOUNT TO	OTAL	2,169.60			
10330 08160			v	EHICLE MAIN	PENANCE				
037470 MCGEE FORD	86389		0	2025 12		336.47	03-26		19 EXPLORER-WHEEL B
INVOICE: 5021000		FULL DESC:							

08/07/2025 11:17 tlaw

08/07/2025 11:17 | TOWN OF NORTHFIELD

INVOICE LIST BY GL ACCOUNT

YEAR/PERIOD: 2025/1 TO 2026/2 ACCOUNT/VENDOR DOCUMENT VOUCHER PO YEAR/PR TYP S WARRANT CHECK DESCRIPTION -----052611 SANEL NAPA 86413 0 2025 12 INV A 40.02 03-26 19FORD EXP-OIL&FILT INVOICE: 531520 FULL DESC: 19FORD EXP-OIL&FILTER ACCOUNT TOTAL 376.49 10330 08300 DEPARTMENT SUPPLIES 2026 2 INV A 105.00 03-26 7/25-10/25 WATER CO 042767 TDS LEASING INC 86570 INVOICE: 1091199 FULL DESC: 7/25-10/25 WATER COOLER RENT PD PD-SHREDDING PICKUP 2026 2 INV A 24.00 03-26 052902 SECURSHRED 86537 INVOICE: 497631 FULL DESC: PD-SHREDDING PICKUP 7/24 ACCOUNT TOTAL 129.00 BUILDING MAINT/SUPPLIES 10330 08380 2025 12 INV A 27.83 03-26 TRASH LINERS 035892 MAGEE OFFICE PLUS 86384 FULL DESC: TRASH LINERS INVOICE: 035892 MAGEE OFFICE PLUS 0 2025 12 CRM A -27.83 03-26 RETURN LINERS-PD 86385 FULL DESC: RETURN LINERS-PD INVOICE: -----.00 ACCOUNT TOTAL **00 ORG 10330 TOTAL 8,671.26 10340 AMBULANCE DEPARTMENT 10340 06220 MAINTENANCE CONTRACTS 0 2026 2 INV A 46.00 03-26 7/19 COPIER CONTRAC 034875 LEAF 86469 FULL DESC: 7/19 COPIER CONTRACT AMB/HWY INVOICE: 18729456 ACCOUNT TOTAL 46.00 10340 07010 TELEPHONE 2025 12 INV A 82.46 03-26 012544 AT & T 86357 3/4 MOBILE-AMB 2872 FULL DESC: 3/4 MOBILE-AMB 287293977820 INVOICE: 012544 AT & T 86358 0 2025 12 INV A 82.46 03-26 7/4-MOBILE-AMB28729 INVOICE: FULL DESC: 7/4-MOBILE-AMB287293977820 50.00 03-26 AUG25 CELL PHONE 037459 MCCUSKER, MEGGAN 86473 0 2026 2 INV A FULL DESC: AUG25 CELL PHONE INVOICE: 042768 TDS TELECOM 86571 0 2026 2 INV A 103.78 03-26 8/4-PHONE 802485541 FULL DESC: 8/4-PHONE 8024855411 INVOICE: 2026 2 INV A 50.02 03-26 AUG25 INTERNET AMB/ 055824 TRANS-VIDEO 86577 FULL DESC: AUG25 INTERNET AMB/HWY INVOICE:

ACCOUNT TOTAL

368.72

08/07/2025 11:17 | TOWN OF NORTHFIELD

INVOICE LIST BY GL ACCOUNT

|apinvgla

YEAR/PERIOD: 2025/1 TO 2026/2

YEAR/PERIOD: 2025/1 TO ACCOUNT/VENDOR	2026/2 DOCUMENT	r vouche	r po year/	PR TYP S		WARRANT	CHECK	DESCRIPTION
10340 07020			POSTAGE					
042896 NFLD TOWN GEN FUND INVOICE:	86511	FULL DESC:	0 2026 JUL 25 POSTAGE	2 INV A	.74	03-26		JUL 25 POSTAGE
			ACCOUN	T TOTAL	.74			
10340 07050			OFFICE SU	PPI.TES				
035892 MAGEE OFFICE PLUS INVOICE:	86471	FULL DESC:		2 INV A	26.25	03-26		6 CASES 8.5X11 COPY
055824 TRANS-VIDEO	86575	DIV. 2 DDGG		2 INV A	.51	03-26		AUG25 INTERNET MUN
INVOICE: 055824 TRANS-VIDEO	86577	FULL DESC:	AUG25 INTERNET 0 2026	MUN BLD 2 INV A	39.95	03-26		AUG25 INTERNET AMB/
INVOICE:		FULL DESC:	AUG25 INTERNET		33.33	05 20		THOUSE THE PARTY
					40.46			
			ACCOUNT	r TOTAL	66.71			
10340 08010			ELECTRICIT	ГУ				
041616 NFLD ELEC DEPT INVOICE:	86492	FULL DESC:	0 2026 7/18-AMB DEPT	2 INV A	35.11	03-26		7/18-AMB DEPT
			ACCOUNT	r TOTAL	35.11			
10340 08070			GASOLINE/I	TECET.				
042896 NFLD TOWN GEN FUND	86399		•	12 INV A	699.21	03-26		JUNE 25 GAS/DIESEL
INVOICE:		FULL DESC:	JUNE 25 GAS/DIE	ESEL				,
042896 NFLD TOWN GEN FUND	86400			12 INV A	503.46	03-26		MAY 25 GAS/DIESEL
INVOICE: 042896 NFLD TOWN GEN FUND	86401	FULL DESC:	MAY 25 GAS/DIES 0 2025		000 64	22.06		
INVOICE:	00401	FULL DESC:	APRIL25 GAS/DIE	12 INV A ESEL	823.64	03-26		APRIL25 GAS/DIESEL
					2,026.31			
063377 WEX BANK	86589		0 2026	2 INV A	41.01	03-26		7/4-AMB 10.2 GAL DI
INVOICE: 71948	00003	FULL DESC:	7/4-AMB 10.2 GA		11.01	03 20		7,4 AM 10.2 GAI DI
			ACCOUNT	TOTAL	2,067.32			
10340 08150			MEDICAL SU	IDDI TEC				
010461 HAUN WELDING SUPPLIY	86380			12 INV A	32.88	03-26		JUNE CYLINDER RENT
INVOICE: 514269		FULL DESC:	JUNE CYLINDER R					
014864 BOUND TREE	86443		0 2026	2 INV A	1,773.52	03-26		STAT PADZ,ELECTRODE
INVOICE: 85835331	00445	FULL DESC:		RODES, SLINGS, ETC	1,773.32	05-20		SIAI FADA, BUBCIRODE
017936 CVH INVOICE:	86368	FULL DESC:	0 2025 JAN25-PHARMACY	12 INV A	411.78	03-26		JAN25-PHARMACY
065810 ZOLL MEDICAL CORP	86592		0 2026	2 INV A	750.00	03-26		PEDIATRIC SENSORS

08/07/2025 11:17 | TOWN OF NORTHFIELD

INVOICE LIST BY GL ACCOUNT

YEAR/PERIOD: 2025/1 TO 2026/2 ACCOUNT/VENDOR DOCUMENT VOUCHER PO YEAR/PR TYP S WARRANT CHECK DESCRIPTION FULL DESC: PEDIATRIC SENSORS INVOICE: 4240934 065810 ZOLL MEDICAL CORP 86593 NEONATE SENSORS 770.00 03-26 0 2026 2 INV A FULL DESC: NEONATE SENSORS INVOICE: 4237868 _____ 1,520.00 ACCOUNT TOTAL 3,738.18 VEHICLE MAINTENANCE 10340 08160 037470 MCGEE FORD 2025 12 INV A 52.80 03-26 RESTOCK FEE-WATER P 86390 FULL DESC: RESTOCK FEE-WATER PUMP 17AMB INVOICE: 6020586 MICRO VBELT-AMB 046265 O'REILLY AUTO PARTS 86402 0 2025 12 INV A 88.06 03-26 FULL DESC: MICRO VBELT-AMB INVOICE: RETURN MICRO VBELT-0 2025 12 CRM A -88.06 03-26 046265 O'REILLY AUTO PARTS 86403 FULL DESC: RETURN MICRO VBELT-AMB INVOICE: _____ .00 0 2025 12 INV A 64.60 03-26 22AMBA2-TUBING-EXHA 052611 SANEL NAPA 86412 INVOICE: 531431 FULL DESC: 22AMBA2-TUBING-EXHAUST PIPE 052611 SANEL NAPA 86530 0 2026 2 INV A 51.96 03-26 DEF-AMBULANCE INVOICE: 531827 FULL DESC: DEF-AMBULANCE -----ACCOUNT TOTAL 169.36 DEPARTMENT SUPPLIES 10340 08300 CAR WASH/WAX-AMB 129.48 03-26 021684 BUSINESS CREDIT CARD 86596 Ω 2025 12 INV A FULL DESC: CAR WASH/WAX-AMB INVOICE: ACCOUNT TOTAL 129.48 ORG 10340 TOTAL 6,621.62 HIGHWAY DEPT 10420 HRA 10420 05152 125.71 03-26 3368 JULY 8,2025 HRA CLA 0 2026 1 DIR P 039617 MVP-HRA 86313 FULL DESC: JULY 8,2025 HRA CLAIMS CARD INVOICE: ACCOUNT TOTAL 125.71 MAINTENANCE CONTRACTS 10420 06220 0 2026 2 INV A 46.00 03-26 7/19 COPIER CONTRAC 034875 LEAF 86469 FULL DESC: 7/19 COPIER CONTRACT AMB/HWY INVOICE: 18729456 46.00 ACCOUNT TOTAL TELEPHONE 10420 07010 6/17-7/16 CELL PHON 40.44 03-26 0 2026 2 INV A 010495 VERIZON WIRELESS 86581 FULL DESC: 6/17-7/16 CELL PHONE INVOICE: 6118698477

08/07/2025 11:17 | TOWN OF NORTHFIELD

INVOICE LIST BY GL ACCOUNT

P 10 apinvgla

YEAR/PERIOD: 2025/1 TO : ACCOUNT/VENDOR	2026/2 DOCUMENT	VOUCHER	. PO	YEAR/PR	TYP S		WARRANT	CHECK	DESCRIPTION
042768 TDS TELECOM INVOICE:	86571	FULL DESC:	0 8/4-PHONI	2026 2 E 8024855		42.24	03-26		8/4-PHONE 802485541
055824 TRANS-VIDEO INVOICE:	86577	FULL DESC:	0 AUG25 INT	2026 2 TERNET AME		50.01	03-26		AUG25 INTERNET AMB/
			1	ACCOUNT TO	OTAL	132.69			
10420 07050			OFF	CE SUPPL	IES				
035892 MAGEE OFFICE PLUS INVOICE:	86471	FULL DESC:	0 6 CASES 8	2026 2 3.5X11 CO			03-26		6 CASES 8.5X11 COPY
			1	ACCOUNT TO	OTAL	26.25			
10420 07250 046265 O'REILLY AUTO PARTS INVOICE:	86406	FULL DESC:	0	OOL/TRAIN 2025 12 AIR BRAKE	INV A	275.00	03-26		P MARTIN-AIR BRAKES
			F	ACCOUNT TO	OTAL	275.00			
10420 08010 041616 NFLD ELEC DEPT INVOICE:	86493	FULL DESC:	0	TRICITY 2026 2		16.09	03-26		7/18-TUCKERS PIT ON
041616 NFLD ELEC DEPT INVOICE:	86494	FULL DESC:	0	2026 2	INV A	16.09	03-26		7/18-FALLS-SALT SHE
					-	32.18			
			A	CCOUNT TO	TAL	32.18			
10420 08070			GASC	LINE/DIES	SEL				
028560 GILLESPIE FUELS INVOICE:	86372	FULL DESC:	0 443.1 GAL	2025 12 S DIESEL-		1,183.07	03-26		443.1 GALS DIESEL-6
028560 GILLESPIE FUELS INVOICE:	86373	FULL DESC:	.0	2025 12		864.01	03~26		323.6 GALS DIESEL 6
028560 GILLESPIE FUELS	86374		0	2025 12	INV A	992.17	03-26		371.6 GALS DIESEL 6
INVOICE: 028560 GILLESPIE FUELS	86375	FULL DESC:	0	2025 12	INV A	1,140.00	03-26		398.6 GALS DIESEL 6
INVOICE:		FULL DESC:	398.6 GAL	S DIESEL					
						4,179.25			
042896 NFLD TOWN GEN FUND INVOICE:	86399	FULL DESC:	0 JUNE 25 G	2025 12 AS/DIESEL		3,091.54	03-26		JUNE 25 GAS/DIESEL
042896 NFLD TOWN GEN FUND INVOICE:	86400	FULL DESC:	0	2025 12		3,131.67	03-26		MAY 25 GAS/DIESEL
042896 NFLD TOWN GEN FUND INVOICE:	86401	FULL DESC:	0	2025 12	,	3,591.11	03-26		APRIL25 GAS/DIESEL
					-	9,814.32			

08/07/2025 11:17 tlaw

08/07/2025 11:17 | TOWN OF NORTHFIELD

INVOICE LIST BY GL ACCOUNT

ACCOUNT/VENDOR	DOCUMENT		·			WARRANT	CHECK	DESCRIPTION
053596 SO. VILLAGE	86559		0 2026	2 INV A	82.04	03-26		26.472 GALS GASOLIN
INVOICE: 8361		FULL DESC:	26.472 GALS GASO	LINE-7/30-25CHEVY				
			ACCOUNT	TOTAL	14,075.61			
10420 08160			VEHICLE/EQU	IPMENT MAINTENANC	E			
020368 CODY CHEVROLET	86360			2 INV A	49.77	03-26		20 CHEVY6500-HOSE
INVOICE:		FULL DESC:	20 CHEVY6500-HOS					
020368 CODY CHEVROLET	86361			2 CRM A	-49.77	03-26		RETURN HOSES-20 CHE
INVOICE:		FULL DESC:	RETURN HOSES-20		50.00	03.06		D1 D2
020368 CODY CHEVROLET	86362	DITT DDGG		2 INV A	50.08	03-26		PIPE
INVOICE:	06363	FULL DESC:		2 CRM A	_0 50	03-26		RETURN PIPE
020368 CODY CHEVROLET	86363	PIHI DECC.	RETURN PIPE	Z CRII A	-0.50	03-26		RETURN FIFE
INVOICE: 020368 CODY CHEVROLET	86364	FULL DESC:		2 INV A	45 26	03-26		20CHEVY6500-HOSE
INVOICE:	00304	FILL DESC:	20CHEVY6500-HOSE	1111		00 20		
020368 CODY CHEVROLET	86365	1022 3200.		CRM A	-45.26	03-26		20 CHEVY6500-RETURN
INVOICE:	00300	FULL DESC:	20 CHEVY6500-RET					
020368 CODY CHEVROLET	86366		0 2025 13	2 INV A	19.08	03-26		20CHEVY6500-LOCKS
INVOICE:		FULL DESC:	20CHEVY6500-LOCKS	3				
					60.58			
029195 GOSS DODGE CHRYSLER	86594		0 2026	2 INV A	559.46	03-26		DODGE SALT-FUEL FIL
INVOICE: 749104744		FULL DESC:	DODGE SALT-FUEL I					
035360 LUCKY'S TRAILER SALE	86388		0 2025 12	INV A	91.70	03-26		TRAILER-SUSPENSION
INVOICE:		FULL DESC:	TRAILER-SUSPENSIO	ON ARM				
037776 LOWELL MCLEODS	86381		0 2025 12	INV A	187.56	03-26		DODGE SALT-UBOLT, R
INVOICE:		FULL DESC:	DODGE SALT-UBOLT	REPAIR LEAF				
037776 LOWELL MCLEODS	86382			INV A	22.47	03-26		14WSTAR-BOLT W/HARD
INVOICE:		FULL DESC:	14WSTAR-BOLT W/H	ARDWARE				
037776 LOWELL MCLEODS	86383		0 2025 12	NV A	1,594.32	03-26		20WSTAR-FRONT SPRIN
INVOICE:		FULL DESC:	20WSTAR-FRONT SPE	RING REPAIR				
					1,804.35			
046265 O'REILLY AUTO PARTS	86404		0 2025 12	INV A	47.03	03-26		CABIN FILTERS
INVOICE:		FULL DESC:	CABIN FILTERS					
046265 O'REILLY AUTO PARTS	86405		0 2025 12	CRM A	-47.03	03-26		RETURN CABIN FILTER
INVOICE:		FULL DESC:	RETURN CABIN FILT	TERS				
					.00			
052611 SANEL NAPA	86535		0 2026 2	INV A	96.99	03-26		RDSIDE MOWER-CONNEC
INVOICE: 532571	5555	FILL DESC.	RDSIDE MOWER-CONN			-		
TMACTOR: 23%21T		LOLL DECC.		:= - 				
056866 UNITED CONSTRUCTION	86421		0 2025 12	INV A	729.24	03-26		20GRADER-SERVICE CA
INVOICE: 11126975		FULL DESC:	20GRADER-SERVICE					
11,0201. 111207,0								
064800 WOOD'S CRW CORP.	86591		0 2026 2	NV A	268.28	03-26		VOLVO EXCAVATOR-PIP
10-1000 HOOD D CKM COKE.								

08300

tlaw

10420

08/07/2025 11:17 | TOWN OF NORTHFIELD

INVOICE LIST BY GL ACCOUNT

|P 12 apinvgla

YEAR/PERIOD: 2025/1 TO 2026/2 ACCOUNT/VENDOR DOCUMENT VOUCHER PO YEAR/PR TYP S WARRANT CHECK DESCRIPTION INVOICE: FULL DESC: VOLVO EXCAVATOR-PIPE ACCOUNT TOTAL 3,610.60

033562 KIMBALL MIDWEST 86464 2026 2 INV A 559.94 03-26 DEODORIZER, SCREWS, F INVOICE: 103543756 FULL DESC: DEODORIZER, SCREWS, FITTINGS, ETC 052611 SANEL NAPA 86532 2026 2 INV A 21.98 03-26 DISPOSABLE GLOVES

DEPARTMENT SUPPLIES

INVOICE: 532438 FULL DESC: DISPOSABLE GLOVES

ACCOUNT TOTAL

581.92

8,595.00

20.30

ORG 10420 TOTAL 18,905,96

10430 CEMETERY

10430 06030 TREE REMOVAL 013085 BW MASONRY/ LANDSCAP 86448 0 2026 2 INV A 400.00 03-26 7/22-RD SIDE TREE W INVOICE: FULL DESC: 7/22-RD SIDE TREE WORK

ACCOUNT TOTAL 400.00

CEMETERY CARE CONTRACT 10430 06341 013085 BW MASONRY/ LANDSCAP 86451 2026 2 INV A 8,595.00 03-26 AUG 25 CONTRACT

INVOICE: FULL DESC: AUG 25 CONTRACT

10430 06344 SEXTON 013085 BW MASONRY/ LANDSCAP 86446 2026 2 INV A 900.00 03-26 7/19-2 BURIALS-MT H INVOICE: FULL DESC: 7/19-2 BURIALS-MT HOPE 013085 BW MASONRY/ LANDSCAP 86447 0 2026 2 INV A 400.00 03-26 7/23-BURIAL MT HOPE FULL DESC: 7/23-BURIAL MT HOPE

ACCOUNT TOTAL

013085 BW MASONRY/ LANDSCAP 86449 0 2026 2 INV A 400.00 03-26 7/23-BURIAL FALLS C INVOICE: FULL DESC: 7/23-BURIAL FALLS CEMETERY

0 2026 2 INV A 013085 BW MASONRY/ LANDSCAP 86450 450.00 03-26 7/19-BURIAL MT HOPE INVOICE: FULL DESC: 7/19-BURIAL MT HOPE ______

2,150.00 ACCOUNT TOTAL 2,150.00

10430 08010 ELECTRICITY 041616 NFLD ELEC DEPT 86495 10.15 03-26 0 2026 2 INV A 7/18-CEMETERIES-ELM

INVOICE: FULL DESC: 7/18-CEMETERIES-ELMWOOD 041616 NFLD ELEC DEPT 86496 0 2026 2 INV A 10.15 03-26 7/18-CEMETERIES-MT

INVOICE: FULL DESC: 7/18-CEMETERIES-MT HOPE

> ACCOUNT TOTAL 20.30

08/07/2025 11:17 | TOWN OF NORTHFIELD

INVOICE LIST BY GL ACCOUNT tlaw

YEAR/PERIOD: 2025/1 TO 2 ACCOUNT/VENDOR		VOUCHER	PO YEAR/PR TYP S		WARRANT	CHECK	DESCRIPTION
10430 08030 043552 NORTHFIELD INVOICE:	86515	FULL DESC:	WATER 0 2026 2 INV A 7/18-MT HOPE CEMETERY	40.80	03-26		7/18-MT HOPE CEMETE
			ACCOUNT TOTAL	40.80			
			ORG 10430 TOTAL	11,206.10			
10440		TOWN GAR	AGE				
10440 06060			TRASH DISPOSAL				
010062 MYERS CONTAINER, CORF	86474		0 2026 2 INV A	33.85	03-26		11936 AUG25 RECYCLI
INVOICE:		FULL DESC:	11936 AUG25 RECYCLING				
010062 MYERS CONTAINER, CORP	86475		0 2026 2 INV A	109.29	03-26		36736 AUG25 DUMPSTE
INVOICE:	06476	FULL DESC:	36736 AUG25 DUMPSTER 0 2026 2 INV A	15.00	03-26		7/1-WATER COOLER DI
010062 MYERS CONTAINER, CORP INVOICE:	86476	FIII. DESC.	7/1-WATER COOLER DISPOSAL-AMB		03-26		771-WATER COODER DI
010062 MYERS CONTAINER, CORP	86477	TODE DEDC.	0 2026 2 INV A	170.69	03-26		11732 AUG25 DUMPSTE
INVOICE:		FULL DESC:	11732 AUG25 DUMPSTER				
				328.83			
			ACCOUNT TOTAL	328.83			
10440 07010			TELEPHONE				
042768 TDS TELECOM	86571		0 2026 2 INV A	67.55	03-26		8/4-PHONE 802485541
INVOICE:		FULL DESC:	8/4-PHONE 8024855411				
				Con re			
			ACCOUNT TOTAL	67.55			
10440 08010			ELECTRICITY				
041616 NFLD ELEC DEPT	86497		0 2026 2 INV A	27.53	03-26		7/18-RADIO SHACK
INVOICE:		FULL DESC:	7/18-RADIO SHACK				
			ACCOUNT TOTAL	27.53			
10440 00013			ELECTRIC-SOLAR				
10440 08013 052905 SENIOR RENEWABLES, L	86539		0 2026 2 INV A	518.83	03-26		BULLRUN SOLAR-JULY
INVOICE: 190	00333	FULL DESC:	BULLRUN SOLAR-JULY				
			ACCOUNT TOTAL	518.83			
			WENTERING THE				
10440 08020	06380		HEATING FUEL 0 2025 12 INV A	12 05	03-26		8.2 GALS PROPANE-RE
028560 GILLESPIE FUELS INVOICE:	86379	FILL DESC.	8.2 GALS PROPANE-READ HWY 6/26		03 20		0,2 0,20 2,00,20
INVOICE:		TODE DECC.	0.2 0.20 1.012.2 0,00				
			ACCOUNT TOTAL	12.95			
10440 08030			WATER				
043552 NORTHFIELD	86516		0 2026 2 INV A	93.91	03-26		7/18-MUN GARAGE
INVOICE:		FULL DESC:	7/18-MUN GARAGE				
			ACCOUNT TOTAL	93.91			

08/07/2025 11:17 | TOWN OF NORTHFIELD

INVOICE LIST BY GL ACCOUNT

P 14 apinvgla

YEAR/PERIOD: 2025/1 TO 2 ACCOUNT/VENDOR	DOCUMENT	VOUCHER	PO YEAR/PR TYP S		WARRANT	CHECK	DESCRIPTION
10440 08050 043552 NORTHFIELD	86516		SEWER 0 2026 2 INV A	117.52	03-26		7/18-MUN GARAGE
INVOICE:		FULL DESC:	7/18-MUN GARAGE				
			ACCOUNT TOTAL	117.52			
			ORG 10440 TOTAL	1,167.12			
10445		LIBRARY/	HISTORICAL SOCIETY BLD				
10445 06090 053855 SPOTLESS CLEANING	86563		JANITORIAL SERVICES 0 2026 2 INV A	200.00	03-26		6/29-7/5 CLEANING S
INVOICE:	00303	FULL DESC:	6/29-7/5 CLEANING SRVCS	200.00	03-20		0/25-7/5 CDEANING S
053855 SPOTLESS CLEANING	86564		0 2026 2 INV A	200.00	03-26		7/6-7/12 CLEANING S
INVOICE:		FULL DESC:	7/6-7/12 CLEANING SRVCS				
053855 SPOTLESS CLEANING	86565		0 2026 2 INV A	200.00	03-26		7/13-7/19 CLEANING
INVOICE: 053855 SPOTLESS CLEANING	86566	FULL DESC:	7/13-7/19 CLEANING SRVCS 0 2026 2 INV A	200.00	02 26		7/20-7/26 CLEANING
INVOICE:	80300	FULL DESC:	7/20-7/26 CLEANING SRVCS	200.00	03-26		//20-//26 CLEANING
				800.00			
			ACCOUNT TOTAL	800.00			
10445 08010			ELECTRICITY				
041616 NFLD ELEC DEPT	86498		0 2026 2 INV A	104.87	03-26		7/18-LIBRARY
INVOICE:		FULL DESC:	7/18-LIBRARY				
			ACCOUNT TOTAL	104.87			
10445 08013 052905 SENIOR RENEWABLES, L	06530		ELECTRIC-SOLAR 0 2026 2 INV A	559.84 (13_26		BULLRUN SOLAR-JULY
INVOICE: 190	60333	FULL DESC:	BULLRUN SOLAR-JULY	555.64	03-20		BODDKON SODAK-00D1
			ACCOUNT TOTAL	559.84			
10445 08030			WATER				
043552 NORTHFIELD	86517		0 2026 2 INV A	33.16 (03-26		7/18-LIBRARY
INVOICE:		FULL DESC:	7/18-LIBRARY				
			ACCOUNT TOTAL	33.16			
			SEWER	30.05.0	12.26		7/18-LIBRARY
	0.6515		0 2026 2 INV A	38.85 (13-20		() TO-FTDKWKI
10445 08050 043552 NORTHFIELD INVOICE:	86517	FULL DESC:	7/18-LIBRARY				
043552 NORTHFIELD	86517	FULL DESC:		38.85			

08/07/2025 11:17 | TOWN OF NORTHFIELD

INVOICE LIST BY GL ACCOUNT

YEAR/PERIOD: 2025/1 TO 2026/2 DOCUMENT VOUCHER PO YEAR/PR TYP S WARRANT CHECK DESCRIPTION ACCOUNT/VENDOR

ACCOUNT/ VENDOR	DOCUMEN	T VOOCHEI	K PO	HEAR/PR TIP 5		WARRANT	CRECK	DESCRIPTION
10447		MUNICIPA	NI. BIITI.P	TNG				
10447 06060		HOWICIFI		RASH DISPOSAL				
010062 MYERS CONTAINER, CORE	86474		0	2026 2 INV A	33.86	03-26		11936 AUG25 RECYCLI
INVOICE:			11936	AUG25 RECYCLING				
010062 MYERS CONTAINER, CORF	86475		0	2026 2 INV A	109.29	03-26		36736 AUG25 DUMPSTE
INVOICE:		FULL DESC:	36736	AUG25 DUMPSTER				
010062 MYERS CONTAINER, CORE	86477		0	2026 2 INV A	170.69	03-26		11732 AUG25 DUMPSTE
INVOICE:		FULL DESC:	11732	AUG25 DUMPSTER				
					313.84			
				ACCOUNT TOTAL	313.84			
10447 06090			J	ANITORIAL SERVICES				
053855 SPOTLESS CLEANING	86563		0	2026 2 INV A	200.00	03-26		6/29-7/5 CLEANING S
INVOICE:		FULL DESC:	6/29-7	/5 CLEANING SRVCS				
053855 SPOTLESS CLEANING	86564		0	2026 2 INV A	200.00	03-26		7/6-7/12 CLEANING S
INVOICE:		FULL DESC:	7/6-7/	12 CLEANING SRVCS				
053855 SPOTLESS CLEANING	86565		0	2026 2 INV A	200.00	03-26		7/13-7/19 CLEANING
INVOICE:		FULL DESC:	7/13-7	/19 CLEANING SRVCS				
053855 SPOTLESS CLEANING	86566		0	2026 2 INV A	200.00	03-26		7/20-7/26 CLEANING
INVOICE:		FULL DESC:	7/20-7	/26 CLEANING SRVCS				
					800.00			
					000.00			
				ACCOUNT TOTAL	800.00			
10447 08010			E	LECTRICITY				
041616 NFLD ELEC DEPT	86499		0	2026 2 INV A	16.09	03-26		7/18-KENT ST GARAGE
INVOICE:		FULL DESC:	7/18-K	ENT ST GARAGE (OLD TDS	3)			
				ACCOUNT TOTAL	16.09			
10447 08013	0.553.0			LECTRIC-SOLAR	403.40	03-26		BULLRUN SOLAR-JULY
052905 SENIOR RENEWABLES; L	86539	PIII.I DPSC.	0 BIT.T.DIT	2026 2 INV A N SOLAR-JULY	403.40	03-26		BOLLKON SOLAR-UULI
INVOICE: 190		FOLL DESC:	BOHLKO	N SOLAR-OULI				
				ACCOUNT TOTAL	403.40			
10447 08020			н	EATING FUEL				
028560 GILLESPIE FUELS	86376		0	2025 12 INV A	82.80	03-26		40.0 GALS PROPANE 6
INVOICE:		FULL DESC:	40.0 G	ALS PROPANE 6/13 MUN	BLD GENERATOR			
				ACCOUNT TOTAL	82.80			
10447 08030			W	ATER				
043552 NORTHFIELD	86518		0	2026 2 INV A	38.29	03-26		7/18-MUN BUILDING
INVOICE:		FULL DESC:	7/18-M	UN BUILDING				
				ACCOUNT TOTAL	38.29			
				ACCOUNT TOTAL	30.29			

INVOICE: 1034530

10510

P 16 |apinvgla

7/18-MUN BUILDING

PAPER TOWELS-MUN BL

08/07/2025 11:17 | TOWN OF NORTHFIELD tlaw INVOICE LIST BY GL ACCOUNT YEAR/PERIOD: 2025/1 TO 2026/2 ACCOUNT/VENDOR DOCUMENT VOUCHER PO YEAR/PR TYP S WARRANT CHECK DESCRIPTION -----10447 08050 SEWER 2026 2 INV A 043552 NORTHFIELD 86518 0 48.68 03-26 INVOICE: FULL DESC: 7/18-MUN BUILDING ACCOUNT TOTAL 48.68 10447 08380 BUILDING MAINT/SUPPLIES 014906 BRADY PLUS 86444

035892 MAGEE OFFICE PLUS 86470 2026 2 INV A 12 BOXES COFFEE 0 192.48 03-26 INVOICE: FULL DESC: 12 BOXES COFFEE

2026 2 INV A

160.44 03-26

2,083.00

840.32

ACCOUNT TOTAL 352.92

FULL DESC: PAPER TOWELS-MUN BLD

ORG 10447 TOTAL 2,056.02

HUMAN SERVICES 10510 06150 SENIOR CENTER

042512 NFLD SENIOR CTR. 86509 0 2026 2 INV A 2,083.00 03-26 AUG 25 ALLOCATION INVOICE: FULL DESC: AUG 25 ALLOCATION

ACCOUNT TOTAL

ORG 10510 TOTAL 2,083.00

10520 GROUNDS/PARKS/FACILITIES 10520 08010 ELECTRICITY

0 2026 2 INV A 041616 NFLD ELEC DEPT 86500 36.83 03-26 7/18-FALLS PARK FIE FULL DESC: 7/18-FALLS PARK FIELD LIGHTS INVOICE: 041616 NFLD ELEC DEPT 86501 0 2026 2 INV A 16.23 03-26 7/18-MEMORIAL PARK(INVOICE: FULL DESC: 7/18-MEMORIAL PARK(POLE)

041616 NFLD ELEC DEPT 86502 0 2026 2 INV A 18.09 03-26 7/18-WELCOME SIGN I

INVOICE: FULL DESC: 7/18-WELCOME SIGN IN SOUTH NFLD _____

71.15

ACCOUNT TOTAL 71.15

10520 08030 WATER 043552 NORTHFIELD 86519 2026 2 INV A 25.31 03-26 7/18-MEM PK BATHROO INVOICE: FULL DESC: 7/18-MEM PK BATHROOMS

86520 0 2026 2 INV A 043552 NORTHFIELD 187.06 03-26 7/18-FALLS FIELD FULL DESC: 7/18-FALLS FIELD INVOICE:

043552 NORTHFIELD 86521 0 2026 2 INV A 585.05 03-26 7/18-FOUNTAIN ON CO INVOICE: FULL DESC: 7/18-FOUNTAIN ON COMMON

043552 NORTHFIELD 86522 2026 2 INV A 42.90 03-26 7/18-COMMUNITY GARD INVOICE:

FULL DESC: 7/18-COMMUNITY GARDEN

ACCOUNT TOTAL 840.32 08/07/2025 11:17 TOWN OF NORTHFIELD tlaw

INVOICE LIST BY GL ACCOUNT

YEAR/PERIOD: 2025/1 TO 2026/2 DOCUMENT VOUCHER PO YEAR/PR TYP S WARRANT CHECK DESCRIPTION ACCOUNT/VENDOR _____ 10520 08050 0 2026 2 INV A 23.81 03-26 7/18-MEM PK BATHROO 043552 NORTHFIELD 86519 FULL DESC: 7/18-MEM PK BATHROOMS INVOICE: ACCOUNT TOTAL 23.81 GASOLINE/DIESEL 10520 08070 193.25 03-26 JUNE 25 GAS/DIESEL 2025 12 INV A 042896 NFLD TOWN GEN FUND 86399 FULL DESC: JUNE 25 GAS/DIESEL INVOICE: 137.02 03-26 MAY 25 GAS/DIESEL 042896 NFLD TOWN GEN FUND 86400 0 2025 12 INV A INVOICE: FULL DESC: MAY 25 GAS/DIESEL 042896 NFLD TOWN GEN FUND 86401 0 2025 12 INV A 13.72 03-26 APRIL25 GAS/DIESEL INVOICE: FULL DESC: APRIL25 GAS/DIESEL _____ 343.99 ACCOUNT TOTAL 343.99 FACILITY SUPPLIES/MAINTENANCE 10520 08570 2025 12 INV A 7.99 03-26 COPPER FITTING-DRIN 86339 0 010128 ACE HARDWARE FULL DESC: COPPER FITTING-DRINKING FOUNTAIN-COMMON INVOICE: 010128 ACE HARDWARE 86340 0 2025 12 INV A 12.99 03-26 VALVE-DRINKING FOUN INVOICE: FULL DESC: VALVE-DRINKING FOUNTAIN COMMON STLICONE-DRINKING F 010128 ACE HARDWARE 86341 0 2025 12 INV A 16.99 03-26 FULL DESC: SILICONE-DRINKING FOUNTAIN COMMON 0 2025 12 INV A 1.50 03-26 3/8 INSERTS-DRINKIN 010128 ACE HARDWARE FULL DESC: 3/8 INSERTS-DRINKING FOUNTAIN-COMMON INVOICE: 010128 ACE HARDWARE 86343 0 2025 12 INV A 2,50 03-26 3/8 O RINGS-DRINKIN INVOICE: FULL DESC: 3/8 O RINGS-DRINKING FOUNTAIN COMMON 41.97 2026 2 INV A AUG25 WIFT PK CAMER 055824 TRANS-VIDEO 86574 0 54 95 03-26 INVOICE: FULL DESC: AUG25 WIFI PK CAMERAS 064100 WIND RIVER ENVIRON 86590 2026 2 INV A 138.00 03-26 7/17-8/13 PORTALET INVOICE: FULL DESC: 7/17-8/13 PORTALET RENT-TRANSFER STATION ACCOUNT TOTAL 234.92 GARDEN SUPPLIES 10520 08575 2025 12 INV A MAY/JUN25 FLOWERS-G 056208 TROMBLY'S GREEN 86420 0 449.76 03-26 INVOICE: 893587 FULL DESC: MAY/JUN25 FLOWERS-GARDEN 056208 TROMBLY'S GREEN 86579 0 2026 2 INV A 36.80 03-26 7/11-SUNFLOWERS-GAR INVOICE: FULL DESC: 7/11-SUNFLOWERS-GARDEN -----486.56 ACCOUNT TOTAL 486.56

ORG 10520 TOTAL

2.000.75

INVOICE LIST BY GL ACCOUNT

P 18 apinvgla

YEAR/PERIOD: 2025/1 TO 2026/2

ACCOUNT/VENDOR	DOCUMENT	r vouche	R PO YEAR/PR TYP S		WARRANT CHECK	DESCRIPTION
10530		RECREAT	ION COMMITTEE			
10530 07020			POSTAGE			
042896 NFLD TOWN GEN FUND	86511		0 2026 2 INV A	1.43	03-26	JUL 25 POSTAGE
INVOICE:		FULL DESC:	JUL 25 POSTAGE			
			ACCOUNT TOTAL	1.43		
			ORG 10530 TOTAL	1.43		
10550		POOL				
10550 08010			ELECTRICITY			
041616 NFLD ELEC DEPT	86503		0 2026 2 INV A	71.83	03-26	7/18-MUNICIPAL POOL
INVOICE:		FULL DESC:	7/18-MUNICIPAL POOL			
			ACCOUNT TOTAL	71.83		
10550 08013			ELECTRIC-SOLAR			
052905 SENIOR RENEWABLES, L	86539		0 2026 2 INV A	469.32	03-26	BULLRUN SOLAR-JULY
INVOICE: 190		FULL DESC:	BULLRUN SOLAR-JULY			
			ACCOUNT TOTAL	469.32		
10550 08030			WATER			
043552 NORTHFIELD	86523		0 2026 2 INV A	2,981.90	03-26	7/18-MEM PK POOL
INVOICE:		FULL DESC:	7/18-MEM PK POOL			
043552 NORTHFIELD	86524		0 2026 2 INV A	85.85	03-26	7/18-POOL BATHHOUSE
INVOICE:		FULL DESC:	7/18-POOL BATHHOUSE			
				3,067.75		
			ACCOUNT TOTAL	3,067.75		
10550 08050			SEWER			
043552 NORTHFIELD	86523		0 2026 2 INV A	3,419.77	03-26	7/18-MEM PK POOL
INVOICE:		FULL DESC:	7/18-MEM PK POOL			
043552 NORTHFIELD	86524		0 2026 2 INV A	68.36	03-26	7/18-POOL BATHHOUSE
INVOICE:		FULL DESC:	7/18-POOL BATHHOUSE			
				3,488.13		
			ACCOUNT TOTAL	3,488.13		
10550 08100			CHEMICALS			
011024 ALLEN ENGIN	86441		0 2026 2 INV A	792.50	03-26	200GALS LIQ CHLORIN
INVOICE:		FULL DESC:	200GALS LIQ CHLORINE-7/15 PO	OOF		
			ACCOUNT TOTAL	792.50		
10550 08570			FACILITY SUPPLIES/MAIN	TENANCE		
014906 BRADY PLUS	86445		0 2026 2 INV A	140.73	03-26	PAPER TOWELS/BATH T
INVOICE: 10372302		FULL DESC:	PAPER TOWELS/BATH TISSUE-POO	OL		

INVOICE LIST BY GL ACCOUNT

YEAR/PERIOD: 2025/1 TO 2026/2 ACCOUNT/VENDOR DOCUMENT VOUCHER PO YEAR/PR TYP S WARRANT CHECK DESCRIPTION _____ 021684 BUSINESS CREDIT CARD 86457 0 2026 2 INV A 71.89 03-26 HANDICAP PARKING SI INVOICE: FULL DESC: HANDICAP PARKING SIGNS-POOL 028560 GILLESPIE FUELS 86461 2026 2 INV A 292.50 03-26 7/14-POOL-DRAIN ISS 0 FULL DESC: 7/14-POOL-DRAIN ISSUE INVOICE: 050448 RECREONICS INC 539.79 03-26 FLOATS & ROPES-POOL 86528 0 2026 2 INV A INVOICE: FULL DESC: FLOATS & ROPES-POOL ACCOUNT TOTAL 1,044.91 ORG 10550 TOTAL 8.934.44 MANAGEMENT SUPPORT 10610 10610 06010 PROFESSIONAL SERVICES 0 2025 12 INV A 049389 QUEEN CITY P.I., LLC 86434 10,969.80 03-26 5/29-6/30 PI SERVIC INVOICE: FULL DESC: 5/29-6/30 PI SERVICES ACCOUNT TOTAL 10,969.80 10610 06020 LEGAL SERVICES 054200 STITZEL 86414 2025 12 INV A 357.60 03-26 MAY25-LEGAL-SELECTB INVOICE: 92858 FULL DESC: MAY25-LEGAL-SELECTBOARD ACCOUNT TOTAL 357.60 10610 06100 AUDITS 2026 2 INV A 750.00 03-26 033637 KITTELL BRANAGAN & S 86465 0 PROGRESS BILL STAND INVOICE: 98457 FULL DESC: PROGRESS BILL STAND. AUDIT FY24-25 ACCOUNT TOTAL 750.00 MAINTENANCE CONTRACTS 10610 06220 JUNE DUO MFA CONTRA 2025 12 INV A 114.00 03-26 054400 SYMQUEST GROUP INC. 86415 0 FULL DESC: JUNE DUO MFA CONTRACT INVOICE: 2020402 131.00 03-26 JUNE BACKUP CONTRAC 054400 SYMQUEST GROUP INC. 86416 Ω 2025 12 INV A FULL DESC: JUNE BACKUP CONTRACT INVOICE: 2020577 JUNE MEDR CONTRACT 0 2025 12 INV A 171.00 03-26 054400 SYMQUEST GROUP INC. 86417 INVOICE: 2020992 FULL DESC: JUNE MEDR CONTRACT 333.00 03-26 JUNE M3650FFICE CON 054400 SYMOUEST GROUP INC. 86418 0 2025 12 INV A FULL DESC: JUNE M3650FFICE CONTRACT INVOICE: 2020293 7/20-8/19 COPIER (2 0 2026 2 INV A 237.60 03-26 054400 SYMQUEST GROUP INC. 86569 FULL DESC: 7/20-8/19 COPIER (2) CONTRACT INVOICE: 2017652 986.60 ACCOUNT TOTAL 986.60 HEALTH ADMIN/FEES 10610 06380 12.70 03-26 JUN25 HRA ADMIN FEE 2025 12 INV A 010037 COMBINED SERVICES, L 86370 0 FULL DESC: JUN25 HRA ADMIN FEE INVOICE:

|P 20 apinvgla

INVOICE LIST BY GL ACCOUNT

	DOCUMENT			PR TYP S			HECK	DESCRIPTION
057050 UNITED STATES TREASU	86335			12 INV P CY2024 FORM720	59.44	03-26 1	.00470	2025HRA TX FOR CY20
			ACCOUN	T TOTAL	72.14			
10610 08040			STREET LI	CHTS				
041616 NFLD ELEC DEPT	86504			2 INV A	149.78	03-26		7/18-LIGHTS ON COMM
INVOICE:		FULL DESC:		COMMON & SO SIDE				.,
041616 NFLD ELEC DEPT	86505				31.82	03-26		7/18-LIGHTS-NORTH/W
INVOICE:		FULL DESC:	7/18-LIGHTS-NO	RTH/WEST SIDE COMM	ION			
041616 NFLD ELEC DEPT	86506		0 2026	2 INV A	16.09	03-26		7/18-TRAFFIC LIGHT
INVOICE:		FULL DESC:	7/18-TRAFFIC L					
041616 NFLD ELEC DEPT	86507				120.41	03-26		7/18-WALL STREET FL
INVOICE: 041616 NFLD ELEC DEPT	86508	FULL DESC:	7/18-WALL STRE		1 205 50	42.05		5 /10 movn. cm v zavma
INVOICE:	00200	FILL DESC.	0 2026 7/18-TOWN ST L		1,395.50	03-26		7/18-TOWN ST LIGHTS
invoici.		FOLL DESC.	7/16-10MN 51 B					
					1,713.60			
			ACCOUN	T TOTAL	1,713.60			
			ORG 10610	TOTAL	14,849.74			
10620		PLANNING	ZONTNG					
10620 07010		I III III III III I	TELEPHONE					
	86571		0 2026		33.44	03-26	,	8/4-PHONE 802485541
INVOICE:		FULL DESC:	8/4-PHONE 8024	855411				
			ACCOUNT	I TOTAL	33.44			
10620 07020			POSTAGE					
042896 NFLD TOWN GEN FUND	86511		0 2026	2 INV A	80.77	03-26	ć	JUL 25 POSTAGE
INVOICE:		FULL DESC:	JUL 25 POSTAGE					
			ACCOUNT	T TOTAL	80.77			
10000 07050								
10620 07050 055824 TRANS~VIDEO	86575		OFFICE SUI	2 INV A	12.54	03.06	,	NICOE THEODING MAN
INVOICE:	00373	FILL DESC.	AUG25 INTERNET		12.54	03-26	F	AUG25 INTERNET MUN
111101021		TOLL DIDE.	AUGZS INIBANEI	TION BID				
			ACCOUNT	r TOTAL	12.54			
10620 07170			Δηνισοπτετν	NG/LEGAL NOTICES				
	86573			2 INV A	113.44	03-26		7/12DRB MEETING 000
INVOICE: 163320		FULL DESC:	7/12DRB MEETING			JJ 20	,	", TEDRO PRESING UUU
			.,					
			ACCOUNT	T TOTAL	113.44			

ORG 10620 TOTAL

240.19

|P 21 |apinvgla

08/07/2025 11:17 tlaw

08/07/2025 11:17 | TOWN OF NORTHFIELD

INVOICE LIST BY GL ACCOUNT

FUND 010 TOWN GENERAL FUND

YEAR/PERIOD: 2025/1 TO 2026/2 WARRANT CHECK DESCRIPTION ACCOUNT/VENDOR DOCUMENT VOUCHER PO YEAR/PR TYP S -----ECONOMIC DEVELOPMENT 10645 TELEPHONE 07010 10645 042768 TDS TELECOM 0 2026 2 INV A 35.77 03-26 8/4-PHONE 802485541 86571 FULL DESC: 8/4-PHONE 8024855411 INVOICE: ACCOUNT TOTAL 35.77 10645 07050 OFFICE SUPPLIES 055824 TRANS-VIDEO 86575 2026 2 INV A 12.54 03-26 AUG25 INTERNET MUN FULL DESC: AUG25 INTERNET MUN BLD INVOICE: ACCOUNT TOTAL 12.54 DUES/MEETINGS/SUBSCRIPTIONS 10645 07070 194.21 03-26 6/16-HOSTGATOR-BUSI 2025 12 INV A 021684 BUSINESS CREDIT CARD 86367 0 FULL DESC: 6/16-HOSTGATOR-BUSINESS GUIDE DOMAIN/PRIVACY INVOICE: ACCOUNT TOTAL 194.21 ORG 10645 TOTAL 242.52

TOTAL: 94,753.57

ACCOUNT/VENDOR

YEAR/PERIOD: 2025/1 TO 2026/2

tlaw

FUND 360 TOWN C.I.P. FUND

INVOICE LIST BY GL ACCOUNT

DOCUMENT

VOUCHER PO

36042 CIP - TOWN HIGHWAY SIDEWALK-VINE ST 36042 09187 041616 NFLD ELEC DEPT 14,614.91 03-26 86391 0 2025 12 INV A POLE REPLACEMENT-VI INVOICE: FULL DESC: POLE REPLACEMENT-VINE ST SIDEWLK ACCOUNT TOTAL 14,614.91 36042 092404 BRIDGE-COVERED SLAUGHTERHOUSE 060143 VERMONT HEAVY TIMBER 86595 2026 2 INV A 40,000.00 03-26 0 SLAUGHTERHOUSE BR-D INVOICE: 955877 FULL DESC: SLAUGHTERHOUSE BR-DEPOSIT ACCOUNT TOTAL 40,000.00 36042 09243 BRIDGES-MAIN ST 058000 VT AGCY TRANS. 86422 2025 12 INV A 2,459.90 03-26 MAY25-MAIN ST BRIDG INVOICE: FULL DESC: MAY25-MAIN ST BRIDGE60 058000 VT AGCY TRANS. 86423 0 2025 12 INV A 1,402.41 03-26 JUNE25 MAIN ST BRID INVOICE: FULL DESC: JUNE25 MAIN ST BRIDGE60 3.862.31 ACCOUNT TOTAL 3.862.31 36042 920025 TURKEY HILL RD REGRAVEL 86407 047248 PIKE INDUSTRIES 0 2025 12 INV A 39,211.56 03-26 2041.25TONS 1.5 CRU INVOICE: FULL DESC: 2041.25TONS 1.5"CRUSHED STONE TURKEY HILL 6/9-11 0 2025 12 CRM A -1,224.47 03-26 047248 PIKE INDUSTRIES 86408 CRDT 127.55TONS 1.5 INVOICE: 1331086 FULL DESC: CRDT 127.55TONS 1.5"CRUSHED STONE TURKEY HILL6/9 047248 PIKE INDUSTRIES 0 2025 12 INV A 2,531.87 03-26 86409 127.55TONS 1.5"CRUS INVOICE: 1332591 FULL DESC: 127.55TONS 1.5"CRUSHEDSTONE TURKEYHILL 6/9 40,518.96 ACCOUNT TOTAL 40,518.96 ORG 36042 TOTAL 98,996.18 CIP - GROUNDS/PARKS/FACILITIES 36052 36052 09372 FROM GARDEN DONATIONS 056208 TROMBLY'S GREEN 86420 587.73 03-26 MAY/JUN25 FLOWERS-G 2025 12 INV A 0 INVOICE: 893587 FULL DESC: MAY/JUN25 FLOWERS-GARDEN ACCOUNT TOTAL 587.73 ORG 36052 TOTAL 587.73

TOTAL: 99,583.91

YEAR/PR TYP S

P 22

apinvqla

WARRANT CHECK DESCRIPTION

08/07/2025 11:17 | TOWN OF NORTHFIELD

INVOICE LIST BY GL ACCOUNT tlaw

YEAR/PERIOD: 2025/1 TO 2026/2 YEAR/PR TYP S WARRANT CHECK DESCRIPTION ACCOUNT/VENDOR DOCUMENT VOUCHER PO _____ ELECTRIC - BALANCE SHEET 51000 51000 14210 CUSTOMER ACCNT RECEIVABLE 2026 2 INV A 796.80 03-26 MESTAS TRUST APPLY 0 010117 NORTHFIELD MUNICIPAL 86439 FULL DESC: MESTAS TRUST APPLY TO TAXES INVOICE: 86439 ACCOUNT TOTAL 796.80 51000 23612 SALES TAX PAYABLE 059376 VT. DEPT. OF TAXES 86582 0 2026 2 INV A 2,631.63 03-26 SALES TAX JULY 25 INVOICE: FULL DESC: SALES TAX JULY 25 ACCOUNT TOTAL 2,631.63 51000 23615 ENERGY EFF CHARGE PAID 86584 039875 NECA VEEU Ó 2026 2 INV A 23,984.57 03-26 EEC JULY 2025 FULL DESC: EEC JULY 2025 INVOICE: ACCOUNT TOTAL 23,984.57 51000 23620 SANDERS-LOAN BILLED CUSTOMER 061456 VT PUBLIC POWER SUPP 86588 0 2026 2 INV A 11,815.97 03-26 JUL 2025 CABOT LOAN FULL DESC: JUL 2025 CABOT LOAN PAYMENT ACCOUNT TOTAL 11,815.97 COBRA 51000 23851 0 2025 12 INV P 87 03-26 100470 2025HRA TX FOR CY20 057050 UNITED STATES TREASU 86335 INVOICE: FULL DESC: 2025HRA TX FOR CY2024 FORM720 ACCOUNT TOTAL .87 51000 36715 U/G N MAIN 15-BRIDGE PREPARE 025240 DUFRESNE GROUP 110.00 03-26 0 2025 12 INV A 86437 JUNE-CONDUITS-C1 VT INVOICE: 19912 FULL DESC: JUNE-CONDUITS-C1 VTRANS 110.00 ACCOUNT TOTAL SERVICES 51000 36910 2025 12 INV A 1,259.66 03-26 NEW SRVC-48MILL ST 86425 030352 GREEN MTN. POWER Ω INVOICE: 45948 FULL DESC: NEW SRVC-48MILL ST GARAGE CUSTOMER685.16 NEW U/G SERVICE-FAI 030352 GREEN MTN. POWER 86428 0 2025 12 INV A 876.25 03-26 INVOICE: 45943 FULL DESC: NEW U/G SERVICE-FAIRGROUNDS _____ 2.135.91

ACCOUNT TOTAL

ORG 51000 TOTAL

2,135,91

41,475.75

apinvgla

BLANKET-SRVC LINE 1

DC/RC-1124UNION-UPG

DC/RC-77TERRACE-MET

tlaw INVOICE LIST BY GL ACCOUNT

YEAR/PERIOD: 2025/1 TO 2026/2

030352 GREEN MTN. POWER 86427

030352 GREEN MTN. POWER 86429

030352 GREEN MTN. POWER 86430

INVOICE: 45945

INVOICE: 45938

INVOICE: 45936

YEAR/PERIOD: 2025/1 TO 2 ACCOUNT/VENDOR	DOCUMENT			YEAR/PR TYP	s 	WARRANT	CHECK	DESCRIPTION
51001 51001 41915 061456 VT PUBLIC POWER SUPP	86424	ELECTRIC		TRANSCO NET SETT	LEMENT CREDITS A -22,55	5 19 03-26		JUNE POWER BILL
INVOICE:		FULL DESC:		POWER BILL				TOWER BIBE
				ACCOUNT TOTAL	-22,555	5.19		
			OR	G 51001 TOTAL	-22,555	5.19		
51047		ELECTRIC						
51047 40815 059376 VT. DEPT. OF TAXES INVOICE:	86583	FULL DESC:	0	FUEL GROSS RECEI 2026 2 INV TAX JULY 2025		1.36 03-26		FUEL TAX JULY 2025
				ACCOUNT TOTAL	1,604	1.36		
51047 40816				PILOT PAYMENT				
042896 NFLD TOWN GEN FUND INVOICE:	86510	FULL DESC:	0 AUG 2	2026 2 INV 5 PILOT	A 7,990	0.00 03-26		AUG 25 PILOT
				ACCOUNT TOTAL	7,990	.00		
51047 55510 061456 VT PUBLIC POWER SUPP	86424		0	PURCHASED POWER 2025 12 INV	A 209,793	.89 03-26		JUNE POWER BILL
INVOICE:		FULL DESC:	JUNE :	POWER BILL				
				ACCOUNT TOTAL	209,793	.89		
51047 58110				PLANT-SUPPLIES/S				
021684 BUSINESS CREDIT CARD INVOICE:	86387	FULL DESC:	O DIGITA	2025 12 INV AL CLAMP METERS-2		.98 03-26		DIGITAL CLAMP METER
				ACCOUNT TOTAL	189	.98		
51047 59310			(OVERHEAD MAINT				
030352 GREEN MTN. POWER INVOICE: 45947	86426	FULL DESC:	0 DC/RC-	2025 12 INV -35COLE AVE-2 TRI	A 1,268 PS CUST 200.00	.47 03-26		DC/RC-35COLE AVE-2
			.,					

ACCOUNT TOTAL	3,407.34

51047 5	59710 METER MAINTENANCE								
030352	GREEN MTN: POWER	86431		0	2025 12 INV A	174.96 03-26	JUNE METER SRVCS		
INVO	ICE: 45925		FULL DESC:	JUNE METE	ER SRVCS				

FULL DESC: BLANKET-SRVC LINE 189JARVIS LN CUST 200.00

0 2025 12 INV A

FULL DESC: DC/RC-1124UNION-UPGRADE-CUST100.00

FULL DESC: DC/RC-77TERRACE-METER BOX CUST 100.00

0 2025 12 INV A 876.25 03-26

0 2025 12 INV A 670.74 03-26

591.88 03-26

3,407.34

YEAR/PERIOD: 2025/1 TO ACCOUNT/VENDOR	2026/2 DOCUMENT	VOUCHE	R PO YEAR/PR TYP S	warrant c	HECK DESCRIPTION
			ACCOUNT TOTAL	174.96	
51047 92111			TELEPHONE		
010495 VERIZON WIRELESS	86581		0 2026 2 INV A	23.14 03-26	6/17-7/16 CELL PHON
INVOICE: 6118698477		II. DESC.	6/17-7/16 CELL PHONE	23.21 03 20	0,2, 1,20 0222 211011
111101011 0110030177			0, 1, 1, 10 0011		
042768 TDS TELECOM	86571		0 2026 2 INV A	137.11 03-26	8/4-PHONE 802485541
INVOICE:		LL DESC:	8/4-PHONE 8024855411		
042768 TDS TELECOM	86572		0 2026 2 INV A	51.71 03-26	8/4-SOLAR BONEHILL8
INVOICE:	FU	LL DESC:	8/4-SOLAR BONEHILL8024854903		
				188.82	
052051 RUSSO JAMES	86529		0 2026 2 INV A	12.50 03-26	AUG 25 CELL PHONE
INVOICE:	FU.	LL DESC:	AUG 25 CELL PHONE		
			ACCOUNT TOTAL	224.46	
51047 92112			POSTAGE		
042896 NFLD TOWN GEN FUND	86511		0 2026 2 INV A	754.06 03-26	JUL 25 POSTAGE
INVOICE:	FU:	LL DESC:	JUL 25 POSTAGE		
			ACCOUNT TOTAL	754.06	
51047 92114			OFFICE SUPPLIES		
030475 GROSSMAN MARKETING	86463		0 2026 2 INV A	424.60 03-26	UTILITY BILLS
INVOICE:	FUI	LL DESC:	UTILITY BILLS		
				40.05.00.06	6 03 070 0 5711 0007
035892 MAGEE OFFICE PLUS	86471		0 2026 2 INV A	49.35 03-26	6 CASES 8.5X11 COPY
INVOICE:	FUI	LL DESC:	6 CASES 8.5X11 COPY PAPER		
ASSES 4 STRANG 117770	0.6505		0 2006 2 7777 7	21.57 03-26	AUG25 INTERNET MUN
055824 TRANS-VIDEO	86575	r pngg	0 2026 2 INV A	21.57 03-26	AUG25 INTERNET MON
INVOICE:	FUI	OF DESC:	AUG25 INTERNET MUN BLD		
			ACCOUNT TOTAL	495.52	
			ACCOUNT TOTAL	493.32	
51047 92119			MAINTENANCE CONTRACT COMP		
054400 SYMQUEST GROUP INC.	86415		0 2025 12 INV A	57.00 03-26	JUNE DUO MFA CONTRA
INVOICE: 2020402		L DESC:	JUNE DUO MFA CONTRACT		
054400 SYMQUEST GROUP INC.			0 2025 12 INV A	65.50 03-26	JUNE BACKUP CONTRAC
INVOICE: 2020577		J. DESC:	JUNE BACKUP CONTRACT		
054400 SYMQUEST GROUP INC.			0 2025 12 INV A	85.50 03-26	JUNE MEDR CONTRACT
INVOICE: 2020992		LL DESC:	JUNE MEDR CONTRACT		
054400 SYMQUEST GROUP INC.	_		0 2025 12 INV A	166.50 03-26	JUNE M3650FFICE CON
INVOICE: 2020293		LL DESC:	JUNE M365OFFICE CONTRACT		
054400 SYMQUEST GROUP INC.			0 2026 2 INV A	38,71 03-26	7/25-8/24 PRINTER C
INVOICE: 2018290		LL DESC:	7/25-8/24 PRINTER CONTRACT		
054400 SYMQUEST GROUP INC.			0 2026 2 INV A	61.20 03-26	7/20-8/19 COPIER (2
INVOICE: 2017652		LL DESC:	7/20-8/19 COPIER (2) CONTRACT		

474.41

08/07/2025 11:17 | TOWN OF NORTHFIELD

INVOICE LIST BY GL ACCOUNT

P 26 apinvgla

tlaw

021684 BUSINESS CREDIT CARD 86432

INVOICE:

ACCOUNT/VENDOR	DOCUMENT	VOUCHER	PO YEAR/PR	TYP S		WARRANT	CHECK	DESCRIPTION
			ACCOUNT T	COTAL	474.41			
51047 92310			LEGAL					
048400 PRIMMER PIPER EGGLES	86410		0 2025 12	INV A	93.00	03-26		JUNE25-ELEC RATE CA
INVOICE:	:	FULL DESC:	JUNE25-ELEC RATE	CASE				
			ACCOUNT T	OTAL	93.00			
51047 92312			AUDIT/CPA					
033637 KITTELL BRANAGAN & S				INV A		03-26		PROGRESS BILL STANE
INVOICE: 98457	1	FULL DESC:	PROGRESS BILL STA	ND. AUDIT FY24-	25			
			ACCOUNT T	OTAL	375.00			
51047 92318			VPPSA-NON PO	WER FEES				
061456 VT PUBLIC POWER SUPP			0 2025 12	INV A	13,485.83	03-26		JUNE POWER BILL
INVOICE:	1	FULL DESC:	JUNE POWER BILL					
			ACCOUNT T	OTAL	13,485.83			
92322			RES REGULATO	RY COST				
061456 VT PUBLIC POWER SUPP			0 2026 2	INV A	10,350.78	03-26		RES AUGUST 25
INVOICE:	I	FULL DESC:	RES AUGUST 25					
			ACCOUNT T	OTAL	10,350.78			
92324			GIS MAPPING					
061456 VT PUBLIC POWER SUPP				INV A	1,532.90	03-26		GIS AUGUST 25
INVOICE: "-	I	FULL DESC:	GIS AUGUST 25					
			ACCOUNT TO	OTAL	1,532.90			
1047 92338			HEALTH ADMIN	/FEES				
057050 UNITED STATES TREASU			0 2025 12		7.02 (03-26	100470	2025HRA TX FOR CY20
INVOICE:	F	FULL DESC:	2025HRA TX FOR CY	2024 FORM720				
			ACCOUNT TO	OTAL	7.02			
51047 93015			ELECTRIC					
041616 NFLD ELEC DEPT	86487		0 2026 2		73.29 (03-26		7/18-KING STREET SU
INVOICE: 041616 NFLD ELEC DEPT	86488	FULL DESC:	7/18-KING STREET 8 0 2026 2		24.10 (13-26		7/18-NU SUBSTATION
INVOICE:		TULL DESC:	7/18-NU SUBSTATION		24.10	05 20		,, to No Bubbiation
					97.39			
			ACCOUNT TO	OTAL	97.39			
			110000111 11		223			
1047 93025			SCHOOL/TRAIN	ING				

0 2025 12 CRM A

FULL DESC: CREDIT-METERING CLASS-LEMIEUX

-550.00 03-26 CREDIT-METERING CLA

08/07/2025 11:17 | TOWN OF NORTHFIELD tlaw

INVOICE LIST BY GL ACCOUNT

YEAR/PERIOD: 2025/1 TO 2026/2 ACCOUNT/VENDOR DOCUMENT VOUCHER PO YEAR/PR TYP S WARRANT CHECK DESCRIPTION 021684 BUSINESS CREDIT CARD 86433 2025 12 CRM A -550.00 03-26 CREDIT-METERING CLA FULL DESC: CREDIT-METERING CLASS-JENSEN INVOICE: _____ -1,100.00 ACCOUNT TOTAL -1.100.00 51047 93311 GASOLINE 113.64 03-26 042896 NFLD TOWN GEN FUND 86399 0 2025 12 INV A JUNE 25 GAS/DIESEL INVOICE: FULL DESC: JUNE 25 GAS/DIESEL 174.05 03-26 042896 NFLD TOWN GEN FUND 86400 0 2025 12 INV A MAY 25 GAS/DIESEL FULL DESC: MAY 25 GAS/DIESEL INVOICE: 042896 NFLD TOWN GEN FUND 0 2025 12 INV A 73.48 03-26 APRIL25 GAS/DIESEL 86401 INVOICE: FULL DESC: APRIL25 GAS/DIESEL 361.17 053596 SO. VILLAGE 16.50 03-26 10.317 GALS GAS 7/9 86545 0 2026 2 INV A FULL DESC: 10.317 GALS GAS 7/9-CHEVY TRAILBLAZER INVOICE: 7844 10.816 GALS GAS 7/1 053596 SO. VILLAGE 86547 0 2026 2 INV A 17.30 03-26 FULL DESC: 10.816 GALS GAS 7/14 TRAILBLAZER INVOICE: 604 053596 SO. VILLAGE 86549 0 2026 2 INV A 41.35 03-26 25.856 GALS GAS 18C INVOICE: 804 FULL DESC: 25.856 GALS GAS 18CHEVY 7/14 053596 SO. VILLAGE 86552 0 2026 2 INV A 22.55 03-26 11.278 GALS GAS 7/2 FULL DESC: 11.278 GALS GAS 7/22 TRAILBLAZER INVOICE: 5793 053596 SO. VILLAGE 0 2026 2 INV A 49.64 03-26 32.032 GALS GAS 18C 86555 FULL DESC: 32.032 GALS GAS 18CHEVY 7/24 INVOICE: 7392 147.34 ACCOUNT TOTAL 508.51

FUND 510 ELECTRIC FUND TOTAL: 269,379.97

TOTAL

ORG 51047

250,459.41

INVOICE:

YEAR/PERIOD: 2025/1 TO 2026/2

tlaw

08/07/2025 11:17 | TOWN OF NORTHFIELD

INVOICE LIST BY GL ACCOUNT

ACCOUNT/VENDOR DOCUMENT VOUCHER PO YEAR/PR TYP S WARRANT CHECK DESCRIPTION ------53000 WATER - BALANCE SHEET 53000 METERS 0 2026 2 INV A 048144 PRESCOTT, E. J. 86526 1,348.88 03-26 2 METERS-NU DORMS INVOICE: 6508161 FULL DESC: 2 METERS-NU DORMS ACCOUNT TOTAL 1,348.88 53000 02051 COBRA INSURANCE 057050 UNITED STATES TREASU 86335 0 2025 12 INV P 1.56 03-26 100470 2025HRA TX FOR CY20 INVOICE: FULL DESC: 2025HRA TX FOR CY2024 FORM720 ACCOUNT TOTAL 1.56 ORG 53000 TOTAL 1,350.44 53045 WATER DEPARTMENT 53045 06010 PROFESSIONAL SERVICES 014078 BEATTY, ROSE E. 86369 0 2025 12 INV A 360.00 03-26 TREE TAPPING INSPEC INVOICE: 2456 FULL DESC: TREE TAPPING INSPECTION ACCOUNT TOTAL 360.00 53045 06100 AUDITS 0 2026 2 INV A 217.50 03-26 033637 KITTELL BRANAGAN & S 86465 PROGRESS BILL STAND INVOICE: 98457 FÜLL DESC: PROGRESS BILL STAND. AUDIT FY24-25 ACCOUNT TOTAL 217.50 53045 06220 MAINTENANCE CONTRACTS 054400 SYMQUEST GROUP INC. 86415 0 2025 12 INV A 33.06 03-26 JUNE DUO MEA CONTRA FULL DESC: JUNE DUO MFA CONTRACT INVOICE: 2020402 054400 SYMOUEST GROUP INC. 86416 0 2025 12 INV A 37.99 03-26 JUNE BACKUP CONTRAC INVOICE: 2020577 FULL DESC: JUNE BACKUP CONTRACT 054400 SYMQUEST GROUP INC. 86417 0 2025 12 INV A 49.59 03-26 JUNE MEDR CONTRACT INVOICE: 2020992 FULL DESC: JUNE MEDR CONTRACT 054400 SYMQUEST GROUP INC. 86418 0 2025 12 INV A 96.57 03-26 JUNE M3650FFICE CON INVOICE: 2020293 FULL DESC: JUNE M3650FFICE CONTRACT 054400 SYMOUEST GROUP INC. 86568 0 2026 2 INV A 7/25-8/24 PRINTER C 22.45 03-26 FULL DESC: 7/25-8/24 PRINTER CONTRACT INVOICE: 2018290 054400 SYMQUEST GROUP INC. 86569 2026 2 INV A 36.00 03-26 7/20-8/19 COPIER (2 INVOICE: 2017652 FULL DESC: 7/20-8/19 COPIER (2) CONTRACT 275.66 ACCOUNT TOTAL 275.66 HEALTH ADMIN/FEES 53045 06380 057050 UNITED STATES TREASU 86335 0 2025 12 INV P 5.92 03-26 100470 2025HRA TX FOR CY20

FULL DESC: 2025HRA TX FOR CY2024 FORM720

ACCOUNT TOTAL

5.92

P 28

apinvgla

INVOICE:

08/07/2025 11:17 | TOWN OF NORTHFIELD

INVOICE LIST BY GL ACCOUNT

YEAR/PERIOD: 2025/1 TO 2026/2 WARRANT CHECK DESCRIPTION DOCUMENT VOUCHER PO YEAR/PR TYP S ACCOUNT/VENDOR ______ TESTING 53045 06510 2026 2 INV A 026230 ENDYNE, INC 86460 25.00 03-26 0 7/16-COLIFORM TEST INVOICE: 540116 FULL DESC: 7/16-COLIFORM TEST ACCOUNT TOTAL 25.00 TELEPHONE 53045 07010 010495 VERIZON WIRELESS 86581 0 2026 2 INV A 34.19 03-26 6/17-7/16 CELL PHON FULL DESC: 6/17-7/16 CELL PHONE INVOICE: 6118698477 86571 8/4-PHONE 802485541 042768 TDS TELECOM 0 2026 2 INV A 150.48 03-26 FULL DESC: 8/4-PHONE 8024855411 INVOICE: AUG 25 CELL PHONE 2026 2 INV A 22.50 03-26 052051 RUSSO JAMES 86529 0 FULL DESC: AUG 25 CELL PHONE INVOICE: ACCOUNT TOTAL 207.17 POSTAGE 53045 07020 042896 NFLD TOWN GEN FUND 86511 0 2026 2 INV A 347.18 03-26 JUL 25 POSTAGE INVOICE: FULL DESC: JUL 25 POSTAGE 347.18 ACCOUNT TOTAL 53045 07050 OFFICE SUPPLIES 0 2026 2 INV A 246.27 03-26 030475 GROSSMAN MARKETING 86463 UTILITY BILLS FULL DESC: UTILITY BILLS INVOICE: 28.36 03-26 6 CASES 8.5X11 COPY 035892 MAGEE OFFICE PLUS 86471 0 2026 2 INV A FULL DESC: 6 CASES 8.5X11 COPY PAPER INVOICE: 2026 2 INV A 8.66 03-26 AUG25 INTERNET MUN 86575 0 055824 TRANS-VIDEO FULL DESC: AUG25 INTERNET MUN BLD INVOICE: 26.97 03-26 AUG25-INTERNET-W/S 86578 O 2026 2 INV A 055824 TRANS-VIDEO INVOICE: FULL DESC: AUG25-INTERNET-W/S ______ 35.63 ACCOUNT TOTAL 310.26 OFFICE EQUIPMENT/MAINTENANCE 53045 07060 194.39 03-26 CANON COLOR PRINTER 2026 2 INV A 021684 BUSINESS CREDIT CARD 86455 FULL DESC: CANON COLOR PRINTER-W/S INVOICE: ACCOUNT TOTAL 194.39 PILOT PAYMENT 53045 07282 AUG 25 PILOT 2026 2 INV A 1,560.00 03-26 042896 NFLD TOWN GEN FUND 86510 0

ACCOUNT TOTAL

1,560.00

FULL DESC: AUG 25 PILOT

ACCOUNT/VENDOR

052611 SANEL NAPA

INVOICE: 532352

86531

tlaw

YEAR/PERIOD: 2025/1 TO 2026/2

INVOICE LIST BY GL ACCOUNT

VOUCHER PO YEAR/PR TYP S DOCUMENT WARRANT CHECK DESCRIPTION 53045 08010 ELECTRICITY 041616 NFLD ELEC DEPT 86489 0 2026 2 INV A 16.09 03-26 7/18-WATER PUMP VAU FULL DESC: 7/18-WATER PUMP VAULT(GARVEY) INVOICE: 041616 NFLD ELEC DEPT 86490 0 2026 2 INV A 18.81 03-26 7/18-CHENEY FARM VA INVOICE: FULL DESC: 7/18-CHENEY FARM VAULT -----ACCOUNT TOTAL 34.90 53045 08013 ELECTRIC-SOLAR 052905 SENIOR RENEWABLES, L 86539 0 2026 2 INV A 3,170.56 03-26 BULLRUN SOLAR-JULY INVOICE: 190 FULL DESC: BULLRUN SOLAR-JULY ACCOUNT TOTAL 3,170,56 53045 08070 GASOLINE/DIESEL 0 2025 12 INV A 117.96 03-26 042896 NFLD TOWN GEN FUND 86399 JUNE 25 GAS/DIESEL INVOICE -FULL DESC: JUNE 25 GAS/DIESEL 042896 NFLD TOWN GEN FUND 86400 0 2025 12 INV A 201.37 03-26 MAY 25 GAS/DIESEL INVOICE: FULL DESC: MAY 25 GAS/DIESEL 042896 NFLD TOWN GEN FUND 0 2025 12 INV A 86401 141.76 03-26 APRIL25 GAS/DIESEL INVOICE: FULL DESC: APRIL25 GAS/DIESEL 461.09 9.57 03-26 053596 SO. VILLAGE 86545 0 2026 2 INV A 10.317 GALS GAS 7/9 INVOICE: 7844 FULL DESC: 10.317 GALS GAS 7/9-CHEVY TRAILBLAZER 053596 SO. VILLAGE 86547 0 2026 2 INV A 10.03 03-26 10.816 GALS GAS 7/1 INVOICE: 604 FULL DESC: 10.816 GALS GAS 7/14 TRAILBLAZER 053596 SO. VILLAGE 86549 0 2026 2 INV A 41.36 03-26 25.856 GALS GAS 18C INVOICE: 804 FULL DESC: 25.856 GALS GAS 18CHEVY 7/14 053596 SO. VILLAGE 86552 0 2026 2 INV A 13.08 03-26 11.278 GALS GAS 7/2 INVOICE: 5793 FULL DESC: 11.278 GALS GAS 7/22 TRAILBLAZER 0 2026 2 INV A 053596 SO. VILLAGE 86555 49.63 03-26 32.032 GALS GAS 18C INVOICE: 7392 FULL DESC: 32.032 GALS GAS 18CHEVY 7/24 -----123,67 ACCOUNT TOTAL 584.76 53045 08100 CHEMICALS 011024 ALLEN ENGIN 86442 2026 2 INV A 417.50 03-26 100GALS LIO CHLORIN 0 INVOICE: FULL DESC: 100GALS LIQ CHLORINE-7/15 ACCOUNT TOTAL 417.50 53045 08250 EQUIPMENT MAINTENANCE

2026 2 INV A

FULL DESC: ADAPTER-HYDRANT FLUSHER

2.94 03-26

ADAPTER-HYDRANT FLU

IP 30

apinvgla

08/07/2025 11:17 tlaw

08/07/2025 11:17 | TOWN OF NORTHFIELD

INVOICE LIST BY GL ACCOUNT

FUND 530 WATER FUND

YEAR/PERIOD: 2025/1 TO 2026/2 WARRANT CHECK DESCRIPTION ACCOUNT/VENDOR DOCUMENT VOUCHER PO YEAR/PR TYP S ______ ACCOUNT TOTAL 2.94 53045 08300 DEPARTMENT SUPPLIES PROPANE TANK-HANDHE 010128 ACE HARDWARE 4.19 03-26 86338 0 2025 12 INV A FULL DESC: PROPANE TANK-HANDHELD TORCH W/S INVOICE: DRILL BIT-W/S 010128 ACE HARDWARE 86344 0 2025 12 INV A 31.19 03-26 FULL DESC: DRILL BIT-W/S INVOICE: 010128 ACE HARDWARE 0 2025 12 INV A 36.99 03-26 ALUM SHOVEL-WATER-H 86356 INVOICE: FULL DESC: ALUM SHOVEL-WATER-HYDRANTS -----72.37 339.56 03-26 COUPLINGS/TUBE STIF 86525 2026 2 INV A 048144 PRESCOTT, E. J. 0 FULL DESC: COUPLINGS/TUBE STIFFENER-WTR INVOICE: 6512819 2026 2 INV A STOCK CONNECTORS-W/ 86533 0 17.40 03-26 052611 SANEL NAPA FULL DESC: STOCK CONNECTORS-W/S INVOICE: 532461 COTT PIN, CARB CHOK 86536 4.31 03-26 052611 SANEL NAPA 0 2026 2 INV A FULL DESC: COTT PIN, CARB CHOKE CLEANER INVOICE: 532624 _____ 21.71 ACCOUNT TOTAL 433.64 EQUIPMENT/TOOL PURCHASE 53045 08460 22.31 03-26 4 1/8 HOLE SAW-W/S 010128 ACE HARDWARE 2025 12 INV A 86337 0 FULL DESC: 4 1/8 HOLE SAW-W/S TOOLS INVOICE: ACCOUNT TOTAL 22.31 ORG 53045 TOTAL 8,169.69

TOTAL: 9,520.13

08/07/2025 11:17 | TOWN OF NORTHFIELD

P 32 apinvgla

tlaw INVOICE LIST BY GL ACCOUNT

YEAR/PERIOD: 2025/1 TO 2 ACCOUNT/VENDOR	026/2 DOCUMENT	VOUCHE	R PO YEAR/PR TYP S	WARRAN'	CHECK DESCRIPTION
55000 55000 01331 048144 PRESCOTT, E. J. INVOICE: 6508161	86526		BALANCE SHEET METERS 0 2026 2 INV A 2 METERS-NU DORMS	899,26 03-26	2 METERS-NU DORMS
			ACCOUNT TOTAL	899.26	
55000 01562			EQUIP REBUILDS-PLANT		
012380 AQUA-AEROBIC SYSTEMS INVOICE: 1048095	86438	FULL DESC:	0 2025 12 INV A SBR MOTOR-PARTS/KIT	12,343.93 03-26	SBR MOTOR-PARTS/KIT
033830 LCS CONTROLS, INC. INVOICE: 14835	86468	FULL DESC:	0 2026 2 INV A REPLACE MOTOR STARTER-SBR MIXER	•	REPLACE MOTOR START
036890 MAYO CRANE RENTAL INVOICE: 1768	86472	FULL DESC:	0 2026 2 INV A CRANE RENTAL-4HRS-SBR MOTOR-7/1		CRANE RENTAL-4HRS-S
			ACCOUNT TOTAL	14,480.93	
55000 02051 057050 UNITED STATES TREASU INVOICE:	86335	FULL DESC:	COBRA INSURANCE 0 2025 12 INV P 2025HRA TX FOR CY2024 FORM720	1.04 03-26	100470 2025HRA TX FOR CY20
		s	ACCOUNT TOTAL	1.04	
			ORG 55000 TOTAL	15,381.23	
55046 55046 06100 033637 KITTELL BRANAGAN & S INVOICE: 98457	86465	SEWER DE	PARTMENT AUDITS 0 2026 2 INV A PROGRESS BILL STAND. AUDIT FY24	157.50 03-26 25	PROGRESS BILL STAND
			ACCOUNT TOTAL	157.50	
55046 06220 054400 SYMOUEST GROUP INC.	95415		MAINTENANCE CONTRACTS 0 2025 12 INV A	22 04 02 26	TING NO MILE CONTROL
INVOICE: 2020402	80413	FULL DESC:	JUNE DUO MFA CONTRACT	23.94 03-26	JUNE DUO MFA CONTRA
054400 SYMQUEST GROUP INC. INVOICE: 2020577	86416	FILL DECC.	0 2025 12 INV A JUNE BACKUP CONTRACT	27.51 03-26	JUNE BACKUP CONTRAC
054400 SYMQUEST GROUP INC. INVOICE: 2020992	86417		0 2025 12 INV A JUNE MEDR CONTRACT	35.91 03-26	JUNE MEDR CONTRACT
054400 SYMQUEST GROUP INC. INVOICE: 2020293	86418	FIU.I. DESC.	0 2025 12 INV A JUNE M3650FFICE CONTRACT	69.93 03-26	JUNE M3650FFICE CON
054400 SYMQUEST GROUP INC.	86568		0 2026 2 INV A	16.25 03-26	7/25-8/24 PRINTER C
INVOICE: 2018290 054400 SYMQUEST GROUP INC. INVOICE: 2017652	86569		7/25-8/24 PRINTER CONTRACT 0 2026 2 INV A 7/20-8/19 COPIER (2) CONTRACT	25.20 03-26	7/20-8/19 COPIER (2
				198.74	

ACCOUNT TOTAL

198.74

055824 TRANS-VIDEO

INVOICE:

86578

tlaw

08/07/2025 11:17 | TOWN OF NORTHFIELD

INVOICE LIST BY GL ACCOUNT

YEAR/PERIOD: 2025/1 TO 2026/2 ACCOUNT/VENDOR DOCUMENT VOUCHER PO YEAR/PR TYP S WARRANT CHECK DESCRIPTION ------HEALTH ADMIN/FEES 06380 55046 057050 UNITED STATES TREASU 86335 0 2025 12 INV P 3.96 03-26 100470 2025HRA TX FOR CY20 FULL DESC: 2025HRA TX FOR CY2024 FORM720 INVOICE: ACCOUNT TOTAL 3.96 55046 06500 SLUDGE MANAGEMENT 026264 ENGLOBE CORP 86371 0 2025 12 INV A 11,035.56 03-26 66.87 TONS-WW BIOSO FULL DESC: 66.87 TONS-WW BIOSOLID-JUNE INVOICE: 11,035.56 ACCOUNT TOTAL TESTING-SAMPLING 55046 06510 026230 ENDYNE, INC 215.00 03-26 7/2-WW 0 2026 2 INV A 86459 INVOICE: 539872 FULL DESC: 7/2-WW ACCOUNT TOTAL 215.00 55046 07010 TELEPHONE 23.10 03-26 6/17-7/16 CELL PHON 0 2026 2 INV A 010495 VERIZON WIRELESS 86581 FULL DESC: 6/17-7/16 CELL PHONE INVOICE: 6118698477 58.62 03-26 8/4-PHONE 802485541 042768 TDS TELECOM 86571 0 2026 2 INV A FULL DESC: 8/4-PHONE 8024855411 INVOICE: 052051 RUSSO JAMES 86529 0 2026 2 INV A 15.00 03-26 AUG 25 CELL PHONE INVOICE: FULL DESC: AUG 25 CELL PHONE 96.72 ACCOUNT TOTAL 55046 07020 POSTAGE 0 2026 2 INV A 368.06 03-26 JUL 25 POSTAGE 042896 NFLD TOWN GEN FUND 86511 FULL DESC: JUL 25 POSTAGE INVOICE: ACCOUNT TOTAL 368.06 55046 07050 OFFICE SUPPLIES UTILITY BILLS 2026 2 INV A 178.33 03-26 030475 GROSSMAN MARKETING 86463 0 FULL DESC: UTILITY BILLS INVOICE: 2026 2 INV A 20.46 03-26 6 CASES 8.5X11 COPY 035892 MAGEE OFFICE PLUS 86471 0 FULL DESC: 6 CASES 8.5X11 COPY PAPER INVOICE: 5.78 03-26 AUG25 INTERNET MUN 86575 2026 2 INV A 055824 TRANS-VIDEO FULL DESC: AUG25 INTERNET MUN BLD INVOICE:

23.76

17.98 03-26

AUG25-INTERNET-W/S

ACCOUNT TOTAL 222.55

0 2026 2 INV A

FULL DESC: AUG25-INTERNET-W/S

08/07/2025 11:17 | TOWN OF NORTHFIELD

INVOICE LIST BY GL ACCOUNT

P 34 apinvgla

YEAR/PERIOD: 2025/1 TO 2026/2

YEAR/PERIOD: 2025/1 TO 20 ACCOUNT/VENDOR	DOCUMENT	VOUCHER	PO YEAR/PR TYP S		WARRANT CHECK	DESCRIPTION
55046 07060 021684 BUSINESS CREDIT CARD INVOICE:		FULL DESC:	OFFICE EQUIPMENT/MAINTENANC 0 2026 2 INV A CANON COLOR PRINTER-W/S		03-26	CANON COLOR PRINTER
			ACCOUNT TOTAL	129.60		
55046 07070 021684 BUSINESS CREDIT CARD			DUES/MEETINGS/SUBSCRIPTIONS 0 2026 2 INV A	275.00	03-26	SWR LICENSE RENEW-J
INVOICE: 021684 BUSINESS CREDIT CARD INVOICE:	86453		SWR LICENSE RENEW-JR 0 2026 2 INV A SWR LICENSE RENEW-JENSEN	275.00	03-26	SWR LICENSE RENEW-J
021684 BUSINESS CREDIT CARD INVOICE:		FULL DESC:	0 2026 2 INV A SWR LICENSE RENEW-PDEMASI	275.00	03-26	SWR LICENSE RENEW-P
				825.00		
			ACCOUNT TOTAL	825.00		
55046 07282 042896 NFLD TOWN GEN FUND INVOICE:		FULL DESC:	PILOT PAYMENT 0 2026 2 INV A AUG 25 PILOT	3,936.00	03-26	AUG 25 PILOT
			ACCOUNT TOTAL	3,936.00		
55046 07350 018320 CV PROPERTIES INVOICE: 9500275404	86458	FULL DESC:	LEASE AGREEMENTS 0 2026 2 INV A 8/2025-7/2026 PIPE XING 887473	100.00	03-26	8/2025-7/2026 PIPE
			ACCOUNT TOTAL	100.00		
55046 08010 041616 NFLD ELEC DEPT INVOICE:		FULL DESC:	ELECTRICITY 0 2026 2 INV A 7/18-JARVIS LANE	27.25	03-26	7/18-JARVIS LANE
ı			ACCOUNT TOTAL	27,25		
55046 08013 052905 SENIOR RENEWABLES, L INVOICE: 190		FULL DESC:	ELECTRIC-SOLAR 0 2026 2 INV A BULLRUN SOLAR-JULY	5,665.85	03-26	BULLRUN SOLAR-JULY
			ACCOUNT TOTAL	5,665.85		
55046 08030 043552 NORTHFIELD INVOICE:	86512	FULL DESC:	WATER 0 2026 2 INV A 7/18-SEWER PLANT	1,981.83	03-26	7/18-SEWER PLANT
			ACCOUNT TOTAL	1,981.83		
55046 08070 042896 NFLD TOWN GEN FUND INVOICE:	86399 1	FULL DESC:	GASOLINE/DIESEL 0 2025 12 INV A JUNE 25 GAS/DIESEL	296.62	03-26	JUNE 25 GAS/DIESEL

INVOICE LIST BY GL ACCOUNT

YEAR/PERIOD: 2025/1 TO 2 ACCOUNT/VENDOR	026/2 DOCUMENT	VOUCHER	PO YEAR/PR	TYP S		WARRANT	CHECK	DESCRIPTION
042896 NFLD TOWN GEN FUND INVOICE: 042896 NFLD TOWN GEN FUND	86400 86401		MAY 25 GAS/DIESEL 0 2025 12	INV A	242.15 276.74			MAY 25 GAS/DIESEL APRIL25 GAS/DIESEL
INVOICE:		FULL DESC:	APRIL25 GAS/DIESE					
					815.51			
053596 SO. VILLAGE	86545		0 2026 2			03-26		10.317 GALS GAS 7/9
INVOICE: 7844 053596 SO. VILLAGE	86547	FULL DESC:	10.317 GALS GAS 7 0 2026 2			03-26		10.816 GALS GAS 7/1
INVOICE: 604	0.5550	FULL DESC:	10.816 GALS GAS 7		0.42	03.06		31 270 CNIC CNC 7/2
053596 SO. VILLAGE INVOICE: 5793	86552	FULL DESC:	0 2026 2 11.278 GALS GAS 7		9.47	03-26		11.278 GALS GAS 7/2
053596 SO. VILLAGE	86561		0 2026 2	INV A	152.97	03-26		47.818 GALS GAS 7/3
INVOICE: 1736		FULL DESC:	47.818 GALS GAS 7	/31-24CHEVY				
					176.64			
			ACCOUNT T	OTAL	992.15			
55046 08180			LINE MAINTEN	ANCE				
010128 ACE HARDWARE	86345		0 2025 12	INV A	26.99	03-26		1PVC EXP-CHEMICAL L
INVOICE:		FULL DESC:	1PVC EXP-CHEMICAL					
010128 ACE HARDWARE	86346		0 2025 12			03-26		3/4 90 PVC-CHEMICAL
INVOICE:	26245	FULL DESC:	•			03-26		3/4 COUPLING-CHLORI
010128 ACE HARDWARE INVOICE:	86347	בווו.ו. מפכר	0 2025 12 3/4 COUPLING-CHLO		5.50	03-26		3/4 COUPLING-CHIORI
010128 ACE HARDWARE	86348	robb base.	0 2025 12		4.99	03-26		LB EXPANSION COUPLI
INVOICE:		FULL DESC:	LB EXPANSION COUP	LING-CHLORINE ANA	LYZER			
010128 ACE HARDWARE	86349		0 2025 12	INV A	1.99	03-26		3/4 90 PVC EXPANSIO
INVOICE:		FULL DESC:	3/4 90 PVC EXPANS	ION-CHLORINE ANAL	YZER			
010128 ACE HARDWARE	86350		0 2025 12	INV A	29.98	03-26		3/4 PVC CONDUIT-CHL
INVOICE:		FULL DESC:	•					
010128 ACE HARDWARE	86351		0 2025 12		15.98			3/4 LB EXPANSION CO
INVOICE:		FULL DESC:	3/4 LB EXPANSION					. /
010128 ACE HARDWARE	86352		0 2025 12		3.98	03-26		3/4 90 PVC-CHLORINE
INVOICE:		FULL DESC:	3/4 90 PVC-CHLORI:		1 10	03-26		3/4 COUPLING-CHLORI
010128 ACE HARDWARE INVOICE:	86353	WITH DESC.	0 2025 12 3/4 COUPLING-CHLO		1.10	03 20		s, r coording chaons
010128 ACE HARDWARE	86354	FOHE DESC.	0 2025 12		5.98	03-26		3/4X1/8 BUSHING-CHL
INVOICE:	00001	FULL DESC:	3/4X1/8 BUSHING-C					
010128 ACE HARDWARE	86355		0 2025 12		7.98	03-26		PVC WATER-CHLORINE
INVOICE:		FULL DESC:	PVC WATER-CHLORIN					
					112.57			
			ACCOUNT TO	OTAL	112.57			
			EULLIMIERE MAS	THENANCE				
55046 08250	06534		EQUIPMENT MA:		4 47	03-26		CONNECTOR-SLUDGE PU
052611 SANEL NAPA	86534	אווה. האפרי	CONNECTOR-SLUDGE		4.44			
INVOICE: 532466			COMMISSION DECOME	 -				

08/07/2025 11:17 | TOWN OF NORTHFIELD

INVOICE LIST BY GL ACCOUNT

apinvgla

YEAR/PERIOD: 2025/1 TO ACCOUNT/VENDOR	DOCUMEN.	T VOUCHER	PO YEAR/PR	TYP S	WAR	RANT CHECK	DESCRIPTION
			ACCOUNT T	OTAL:	4.41		
55046 08300			DEPARTMENT S	SUPPLIES			
010128 ACE HARDWARE	86338		0 2025 12		2.80 03-	26	PROPANE TANK-HANDHE
INVOICE:		FULL DESC:	PROPANE TANK-HAND	-			
010128 ACE HARDWARE INVOICE:	86344	DILL DOGG	0 2025 12	INV A	20.80 03-	26	DRILL BIT-W/S
INVOICE		FULL DESC:	DRILL BIT-W/S				
					23.60		
021684 BUSINESS CREDIT CAR	D 86456		0 2026 2	INV A	21.98 03-	26	WEDGE ANCHORS/SCREW
INVOICE:		FULL DESC:	WEDGE ANCHORS/SCR	EWS KIT-SWR			
	86533		0 2026 2	INV A	11.60 03-	26	STOCK CONNECTORS-W/
INVOICE: 532461		FULL DESC:	STOCK CONNECTORS-	•			
	86536	DEGG		INV A	2.87 03-	26	COTT PIN, CARB CHOK
INVOICE: 532624		FULL DESC:	COTT PIN, CARB CH	OKE CLEANER			
					14.47		
			ACCOUNT TO	OTAL	60.05		
55046 08460			EQUIPMENT/TO	OL PURCHASE			
010128 ACE HARDWARE INVOICE:	86337	PILL DECG.	0 2025 12 4 1/8 HOLE SAW-W/3		14.88 03-	26	4 1/8 HOLE SAW-W/S
INVOICE:		FOUR DESC:	4 1/6 HOLE SAW-W/	5 100L5			
			ACCOUNT TO	TAL	14.88		
			ORG 55046 T	OTAL 26,1	.47.68		
**********************				=======================================		=======================================	
. FUND 550 SEV	VER FUND		TOTAL:	41,5	28.91		

^{**} END OF REPORT - Generated by Tanya Law **

tlaw

INVOICE LIST BY GL ACCOUNT

| P 1 apinvgla

YEAR/PERIOD	: 2026/1 TO 2026/2 R DOCUMENT	VOUCHER PO	YEAR/PR	TYP S	WARRANT	CHECK DESCRIPTION
10140 10140 05152 039617 MVP-HRA INVOICE:	A 86314	TOWN CLERK/	HR A 2026		260.96 03-26A	3369 JULY 8,2025 HRA CLA
			ACCOUNT '	TOTAL	260.96	
			ORG 10140	TOTAL	260.96	
10420		HIGHWAY DEPI	ני			
10420 05152			HRA			
039617 MVP-HRA	86314	0	2026	DIR P	102.72 03-26A	3369 JULY 8,2025 HRA CLA
INVOICE:		FULL DESC: JUI	LY 8,2025 HRA (CLAIMS CK		
			ACCOUNT TO)TAL	102.72	
			ORG 10420 T	COTAL	102.72	
	FUND 010 TOWN GENERAL	FUND	TOTAL:		363.68	
				=======================================		

^{**} END OF REPORT - Generated by Tanya Law **

tlaw

INVOICE LIST BY GL ACCOUNT

P 1 apinvgla

YEAR/PERIOD: 2026/1 ACCOUNT/VENDOR	TO 2026/2 DOCUMENT VOUCHE	R PO YEAR/PR TYP S	WARRANT	CHECK DESCRIPTION
10140	TOWN CLE	erk/treasurer		
10140 05152 039617 MVP-HRA INVOICE:	86315 FULL DESC:	HRA 0 2026 1 DIR P JULY 15,2025 HRA CLAIMS CARD	23.14 03-26B	3370 JULY 15,2025 HRA CL
		ACCOUNT TOTAL	23.14	
		ORG 10140 TOTAL	23.14	
10420	HIGHWAY	DEPT		
10420 05152 039617 MVP-HRA INVOICE:	86315 FULL DESC:	HRA 0 2026 1 DIR P JULY 15,2025 HRA CLAIMS CARD	15.00 03-26B	3370 JULY 15,2025 HRA CL
		ACCOUNT TOTAL	15.00	
		ORG 10420 TOTAL	15.00	
FUND 01	O TOWN GENERAL FUND	TOTAL:	38.14	

^{**} END OF REPORT - Generated by Tanya Law **

tlaw

INVOICE LIST BY GL ACCOUNT

P 1 apinvgla

YEAR/PERIOD: 2026/1 ACCOUNT/VENDOR	TO 2026/2 DOCUMENT VOUCHER	PO YEAR/PR TYP S	WARRANT	CHECK DESCRIPTION
10140 10140 05152 039617 MVP-HRA INVOICE:	TOWN CLE 86316 FULL DESC:	RK/TREASURER HRA 0 2026 1 DIR P JULY 15, 2025 HRA CLAIMS CK	269.73 03-26C	3371 JULY 15, 2025 HRA C
11101027	1022 2250.	ACCOUNT TOTAL ORG 10140 TOTAL	269.73 269.73	
10230 10230 05152 039617 MVP-HRA INVOICE:	ACCOUNTI 86316 FULL DESC:	NG HRA 0 2026 1 DIR P JULY 15, 2025 HRA CLAIMS CK	273.11 03-26C	3371 JULY 15, 2025 HRA C
		ACCOUNT TOTAL ORG 10230 TOTAL	273.11 273.11	

FUND 010 TOWN GENERAL FUND TOTAL: 542.84

tlaw

INVOICE LIST BY GL ACCOUNT

P 2 apinvgla

YEAR/PERIOD: 2026/1 TO 2026/2

ACCOUNT/VENDOR DOCUMENT VOUCHER PO YEAR/PR TYP S

WARRANT CHECK DESCRIPTION

51047

51047 05152

ELECTRIC DEPARTMENT

039617 MVP-HRA 86316

INVOICE:

16316 0 2026 1 DIR P 149.34 03-26C 3371 JULY 15, 2025 HRA C FULL DESC: JULY 15, 2025 HRA CLAIMS CK

ACCOUNT TOTAL

149.34

ORG 51047 TOTAL 149.34

FUND 510 ELECTRIC FUND

TOTAL: 149.34

INVOICE LIST BY GL ACCOUNT tlaw

P 3 apinvgla

YEAR/PERIOD: 2026/1 TO 2026/2

ACCOUNT/VENDOR DOCUMENT VOUCHER PO YEAR/PR TYP S _____

WARRANT CHECK DESCRIPTION

53045

53045 05152

WATER DEPARTMENT

039617 MVP-HRA 86316

0 2026 1 DIR P

51.34 03-26C 3371 JULY 15, 2025 HRA C

INVOICE:

FULL DESC: JULY 15, 2025 HRA CLAIMS CK

ACCOUNT TOTAL

51.34

ORG 53045 TOTAL

51.34

FUND 530 WATER FUND

TOTAL:

51.34

tlaw INVOICE LIST BY GL ACCOUNT

|P 4 apinvgla

YEAR/PERIOD: 2026/1 TO 2026/2

ACCOUNT/VENDOR DOCUMENT VOUCHER PO YEAR/PR TYP S WARRANT CHECK DESCRIPTION ------

55046 SEWER DEPARTMENT

HRA 55046 05152

039617 MVP-HRA 86316 0 2026 1 DIR P 32.67 03-26C 3371 JULY 15, 2025 HRA C

FULL DESC: JULY 15, 2025 HRA CLAIMS CK INVOICE:

> ACCOUNT TOTAL 32.67

ORG 55046 TOTAL 32.67

TOTAL: FUND 550 SEWER FUND 32.67

^{**} END OF REPORT - Generated by Tanya Law **

tlaw

INVOICE LIST BY GL ACCOUNT

YEAR/PERIOD: 2026/1 TO	2026/2			
ACCOUNT/VENDOR	DOCUMENT VOUCHER	R PO YEAR/PR TYP S	WARRANT	CHECK DESCRIPTION
	. 7.			
10230	ACCOUNT			
10230 05152		HRA		
039617 MVP-HRA	86317		.78 03-26D	3372 JULY 22,2025 HRA CL
INVOICE:	FULL DESC:	JULY 22,2025 HRA CLAIMS CARD		
		A COURTE TOTAL	7.0	
		ACCOUNT TOTAL	.78	
		ORG 10230 TOTAL	. 78	
		0.00 10230 10181	. 70	
10420	HIGHWAY	DEPT		
10420 05152		HRA		
039617 MVP-HRA	86317	0 2026 1 DIR P	1.64 03-26D	3372 JULY 22,2025 HRA CL
INVOICE:	FULL DESC:	JULY 22,2025 HRA CLAIMS CARD		
		ACCOUNT TOTAL	1.64	
		ORG 10420 TOTAL	1.64	
10645	ECONOMIC	DEVELOPMENT		
10645 05152		HRA		
039617 MVP-HRA	86317	0 2026 1 DIR P	3.32 03-26D	3372 JULY 22,2025 HRA CL
INVOICE:	FULL DESC:	JULY 22,2025 HRA CLAIMS CARD		
		ACCOUNT TOTAL	3.32	
		ODG 10645 MOMNI	2 20	
		ORG 10645 TOTAL	3.32	
	WN GENERAL FUND	TOTAL:	5.74	
TOME OTO TO	HE CHILLIAN TOND	.011111.		

^{**} END OF REPORT - Generated by Tanya Law **

tlaw

INVOICE LIST BY GL ACCOUNT

| P 1 apinvgla

YEAR/PERIOD: 2026/1 TO 2026/2

ACCOUNT/VENDOR DOCUMENT VOUCHER PO YEAR/PR TYP S WARRANT CHECK DESCRIPTION

10420

HIGHWAY DEPT

05152 10420

039617 MVP-HRA

HRA 86318 0

0 2026 1 DIR P

84.00 03-26E 3373 JULY 22,2025 HRA CL

INVOICE:

FULL DESC: JULY 22,2025 HRA CLAIMS CK

ACCOUNT TOTAL

84.00

ORG 10420 TOTAL

84.00

FUND 010 TOWN GENERAL FUND

TOTAL:

84.00

** END OF REPORT - Generated by Tanya Law **

tlaw INVOICE LIST BY GL ACCOUNT | P 1 apinvgla

YEAR/PERIOD: 2026/1 ACCOUNT/VENDOR	TO 2026/2 DOCUMENT VOUCHE	R PO YEAR/PR TYP S	WARRANT	CHECK DESCRIPTION
10230 10230 05152	ACCOUNT	ING HRA		
039617 MVP-HRA	86336 FULL DESC:	0 2026 1 DIR P	806.03 03-26F	3374 JULY 29, 2025 HRA C
		ACCOUNT TOTAL	806.03	
		ORG 10230 TOTAL	806.03	
FUND 010	TOWN GENERAL FUND	TOTAL:	806.03	

^{**} END OF REPORT - Generated by Tanya Law **



WARRANT 022526

PAY PERIOD 07/07/2025 to 07/20/2025

CHECK DATE 07/25/2025

YEAR 2026 PERIOD 1 EXPENDITURE ENTRIES SHORT DESC 07/25/25PR GL EFF DATE 07/25/2025 REFERENCE 022526 REFERENCE2 1022526

3113KT 223C 01/23/	23113		KEI LI	CLICEZ 1022320
ORG OBJECT	PROJECT	TOWN MANAGER TOWN CLERK/TREASURER ACCOUNTING ACCOUN	ACCOUNT DESCRIPTION	EXPENDITURE
YEAR 2026 PERIOD	1		CL FFF	DATE 07/25/2025
10130 05020	ı	TOWN MANACED	GL EFF	DATE 07/23/2023
10130 05050		TOWN MANAGER	APPOINTED	2,384./3
10130 05050		TOWN MANAGER	CLERICAL	1,324.35
10130 05154		TOWN MANAGER	HEALTH INSURANCE PREMIUM	951.10
10130 05156		TOWN MANAGER	DENTAL INSURANCE	40.62
10130 05158		TOWN MANAGER	LIFE/DISABILITY INSURANCE	87.46
10130 05170		TOWN MANAGER	FICA	265.43
10130 05175		TOWN MANAGER	CHILD CARE CONTRIB TAX	14.00
10130 05180		TOWN MANAGER	RETIREMENT-VMERS	239.10
10140 05010		TOWN CLERK/TREASURER	ELECTED	2,766.41
10140 05012		TOWN CLERK/TREASURER	ELECTED TREASURER	212.00
10140 05020		TOWN CLERK/TREASURER	APPOINTED	1,889.25
10140 05154		TOWN CLERK/TREASURER	HEALTH INSURANCE PREMIUM	2.024.24
10140 05156		TOWN CLERK/TREASURER	DENTAL INSURANCE	98.97
10140 05158		TOWN CLERK/TREASURER	LIFE/DISABILITY INSURANCE	122.79
10140 05170		TOWN CLERK/TREASURER	FTCA	333 30
10140 05175		TOWN CLERK/TREASURER	CHILD CARE CONTRIB TAX	17 37
10140 05180		TOWN CLERK/TREASURER	PETTDEMENT_VMEDS	279 34
10230 05050		ACCOUNTING	CLEDICAL VISCOS	273.34
10230 05154		ACCOUNTING	LEALTH INCHDANCE DREMTIM	420 94
10230 05156		ACCOUNTING	DENTAL INSURANCE PREMIUM	10.04
10230 05158		ACCOUNTING	DENIAL INSUKANCE	19.89
10230 05170		ACCOUNTING	LIFE/DISABILITY INSURANCE	33.01
		ACCOUNTING	FICA	161.28
10230 05175		ACCOUNTING	CHILD CARE CONTRIB TAX	8.65
10230 05180		ACCOUNTING	RETIREMENT-VMERS	160.75
10260 05010		LISTERS	ELECTED	360.00
10260 05070		LISTERS	PART-TIME	702.24
10260 05170		LISTERS	FICA	81.26
10260 05175		LISTERS	CHILD CARE CONTRIB TAX	4.67
10330 05030		POLICE DEPARTMENT	SUPERVISOR	3,888,00
10330 05040		POLICE DEPARTMENT	OFFICERS	3,973,11
10330 05050		POLICE DEPARTMENT	CLERICAL	3,173,60
10330 05080		POLICE DEPARTMENT	OVERTIME	2,000.27
10330 05154		POLICE DEPARTMENT	HEALTH INSURANCE PREMIUM	2,129,97
10330 05156		POLICE DEPARTMENT	DENTAL INSURANCE	123.45
10330 05158		POLICE DEPARTMENT	LIFE/DISABILITY INSURANCE	217.48
10330 05170		POLICE DEPARTMENT	ETCA	959 62
10330 05175		POLICE DEPARTMENT	CUTIO CAPE CONTERE TAY	18 67
10330 05180		POLICE DEPARTMENT	DETTDEMENT_VMEDS	1 252 26
10340 05030		AMDILANCE DEPARTMENT	CUDEBATEOD - VMERS	7,332,20
10340 05070		AMBULANCE DEPARTMENT	SUPERVISOR	5,024.00
		AMBULANCE DEPARTMENT	PAKI-IIME	5,280.75
10340 05072		AMBULANCE DEPARTMENT	RUN PAY	1,150.00
10340 05073		AMBULANCE DEPARTMENT	TRAINING PAY	284.68
10340 05083		AMBULANCE DEPARTMENT	OT - HALF RATE ONLY	187.64
10340 05090		AMBULANCE DEPARTMENT	STANDBY/ON CALL	1,109.50
10340 05091		AMBULANCE DEPARTMENT	WEEKEND SUPERVISOR	250.00
10340 05110	PROJECT 1	AMBULANCE DEPARTMENT	NON EMERGENCY TRANSFERS	87.75
10340 05111		AMBULANCE DEPARTMENT	TRANSFER CREW-PD SHIFT	558.00

Report generated: 07/22/2025 17:25 User: tlaw Program ID: prjournl



WARRANT 022526

PAY PERIOD 07/07/2025 to 07/20/2025

CHECK DATE 07/25/2025

YEAR 2026 PERIOD 1 EXPENDITURE ENTRIES SHORT DESC 07/25/25PR GL EFF DATE 07/25/2025 REFERENCE 022526 REFERENCE2 1022526

				T C Ban T C San T C San T C San San San	1022320
ORG	OBJECT	PROJECT	ORGANIZATION TITLE AMBULANCE DEPARTMENT HIGHWAY DEPT GROUNDS/PARKS/FACILITIES GROU	ACCOUNT DESCRIPTION	EXPENDITURE
10340	05151		AMBULANCE DEPARTMENT	EMPLOYEE HEALTH BUYOUT	500.00
10340	05156		AMBULANCE DEPARTMENT	DENTAL INSURANCE	63.02
10340	05158	•	AMBULANCE DEPARTMENT	LIFE/DISABILITY INSURANCE	78.96
10340	05170		AMBULANCE DEPARTMENT	FICA	950.83
10340	05175		AMBULANCE DEPARTMENT	CHILD CARE CONTRIB TAX	52.95
10340	05180		AMBULANCE DEPARTMENT	RETIREMENT-VMERS	228.38
10420	05040		HIGHWAY DEPT	TECHNICAL	14,044.18
10420	05080		HIGHWAY DEPT	OVERTIME	182.16
10420	05151		HIGHWAY DEPT	EMPLOYEE HEALTH BUYOUT	500.00
10420	05154		HIGHWAY DEPT	HEALTH INSURANCE PREMIUM	2,621.79
10420	05156		HIGHWAY DEPT	DENTAL INSURANCE	185.66
10420	05158		HIGHWAY DEPT	LIFE/DISABILITY INSURANCE	321.13
10420	05170		HIGHWAY DEPT	FICA	1,103.10
10420	05175		HIGHWAY DEPT	CHILD CARE CONTRIB TAX	58.18
10420	05180		HIGHWAY DEPT	RETIREMENT-VMERS	997.66
10520	05040		GROUNDS/PARKS/FACILITIES	TECHNICAL	1,000.41
10520	05080		GROUNDS/PARKS/FACILITIES	OVERTIME	18.76
10520	05154		GROUNDS/PARKS/FACILITIES	HEALTH INSURANCE PREMIUM	212.38
10520	05156		GROUNDS/PARKS/FACILITIES	DENTAL INSURANCE	10.04
10520	05158		GROUNDS/PARKS/FACILITIES	LIFE/DISABILITY INSURANCE	24.98
10520	05170		GROUNDS/PARKS/FACILITIES	FICA	73.91
10520	05175		GROUNDS/PARKS/FACILITIES	CHILD CARE CONTRIB TAX	_3.95
10520 10550	05180		GROUNDS/PARKS/FACILITIES	RETIREMENT-VMERS	73.89
10550	05030 05070		POOL	POOL DIRECTOR	2,066.40
10550	05170		POOL	PART-TIME GUARDS	8,801.00
10550	05175		POOL	FICA	831.39
10620	05020		PUUL BLANKING /ZONING	CHIED CARE CONTRIB TAX	47.81
10620	05170		PLANNING/ZONING	ZUNING ADMINISTRATUR	1,020.60
10620	05175		PLANNING/ZONING	CUTION CARE CONTRAIN TAY	/0.33
10645	05051		FLANNING/ ZONING	CHILD CARE CONTRIB TAX	2 114 02
10645	05154		ECONOMIC DEVELOPMENT	HEALTH INCHRANCE DREMINATO	3,114.02
10645	05156		ECONOMIC DEVELOPMENT	HEALTH INSURANCE PREMIUM	413.34
10645	05170		ECONOMIC DEVELOPMENT	DENTAL INSURANCE	12.02
10645	05175		ECONOMIC DEVELOPMENT	CUTIO CARE CONTRIB TAV	12 46
10645	05180		ECONOMIC DEVELOPMENT	DETTDEMENT_VMEDC	225 77
20045	03100		ECONOMIC DEVELOPMENT	KETIKEWENT-VMEKS	223.11
			ELECTRIC DEPARTMENT ELECTRIC DEPARTMENT ELECTRIC DEPARTMENT ELECTRIC DEPARTMENT	FUND TOTALS	87,225,92
51047	05151		ELECTRIC DEDARTMENT	CMBI OVER HEALTH BUNOUT	200 00
51047	05154		ELECTRIC DEPARTMENT	HEALTH INCUBANCE DEMINA	1 002 54
51047	05156		ELECTRIC DEPARTMENT	DENTAL INSURANCE PREMIUM	1,902.34
51047	05158		ELECTRIC DEPARTMENT	TEE DISABILITY TASHBANCE	160.01
51047	05170		ELECTRIC DEPARTMENT	ETCA	500.72
51047	05175		ELECTRIC DEPARTMENT	CHILD CADE CONTOTE TAY	31.67
51047	05180		ELECTRIC DEPARTMENT	RETTREMENT-VMERS	451 47
51047	90210		ELECTRIC DEPARTMENT ELECTRIC DEPARTMENT ELECTRIC DEPARTMENT ELECTRIC DEPARTMENT	METER READING	433.02
51047	92010		ELECTRIC DEPARTMENT	EMPLOYEE HEALTH BUYOUT HEALTH INSURANCE PREMIUM DENTAL INSURANCE LIFE/DISABILITY INSURANCE FICA CHILD CARE CONTRIB TAX RETIREMENT-VMERS METER READING MUNICIPAL MANAGER	928.58
				TOTALET ME PURINGEN	320.30

TOWN OF NORTHFIELD



GENERAL LEDGER DISTRIBUTION JOURNAL: BIWEEKLY

WARRANT 022526

PAY PERIOD 07/07/2025 to 07/20/2025

CHECK DATE 07/25/2025

YEAR 2026 PERIOD 1 EXPENDITURE ENTRIES
SHORT DESC 07/25/25PR GL EFF DATE 07/25/2025 REFERENCE 022526 REFERENCE2 1022526

SHORT DESC 07/25/	ZSPR		REFERENCE2	1022526
ORG OBJECT 51047 92012 51047 92013 51047 92014 51047 92016 51047 92018 51047 92019	PROJECT	ORGANIZATION TITLE ELECTRIC DEPARTMENT	ACCOUNT DESCRIPTION CLERICAL LABOR OVERTIME LABOR SUPERINTENDENT ASSISTANT TECHNICAL LABOR STAND-BY FUND TOTALS	1,811.68 206.00 892.60 2,579.08 1,222.96 45.00
53045 05020 53045 05030 53045 05042 53045 05080 53045 05151 53045 05154 53045 05156 53045 05156 53045 05158 53045 05175 53045 05175 53045 05175 53045 05175		WATER DEPARTMENT	APPOINTED SUPERVISOR TECHNICAL/ADMIN/CLERICAL OVERTIME STANDBY/ON CALL EMPLOYEE HEALTH BUYOUT HEALTH INSURANCE PREMIUM DENTAL INSURANCE LIFE/DISABILITY INSURANCE FICA CHILD CARE CONTRIB TAX RETIREMENT-VMERS	527.60 1,606.68 5,491.95 374.76 153.00 480.00 1,442.04 126.63 169.03 632.49 32.91 557.03
55046 05020 55046 05030 55046 05042 55046 05080 55046 05151 55046 05154 55046 05156 55046 05158 55046 05170 55046 05175 55046 05175 55046 05175		SEWER DEPARTMENT	APPOINTED SUPERVISOR TECHNICAL/ADMIN/CLERICAL OVERTIME STANDBY/ON CALL EMPLOYEE HEALTH BUYOUT HEALTH INSURANCE PREMIUM DENTAL INSURANCE LIFE/DISABILITY INSURANCE FICA CHILD CARE CONTRIB TAX RETIREMENT-VMERS FUND TOTALS	379.87 1,071.12 3,645.38 1,337.10 102.00 320.00 1,007.87 95.45 129.09 504.85 26.14 450.94 9.069.81

TOWN OF NORTHFIELD



GENERAL LEDGER DISTRIBUTION JOURNAL: MISC

WARRANT M02526

PAY PERIOD 07/07/2025 to 07/20/2025

CHECK DATE 07/25/2025

YEAR 2026 PERIOD 1 EXPENDITURE ENTRIES SHORT DESC 7/25/25MPR GL EFF DATE 07/25/2025 REFERENCE M02526 REFERENCE2 2M02526

ORG		OBJECT	PROJECT
YEAR	2026	PERIOD	1
10330		05154	
10330		05156	
10330		05158	

ORGANIZATION TITLE	ACCOUNT DESCRIPTION	EXPENDITURE
POLICE DEPARTMENT POLICE DEPARTMENT POLICE DEPARTMENT	HEALTH INSURANCE PREMIUM DENTAL INSURANCE LIFE/DISABILITY INSURANCE	E 07/25/2025 884.84 62.50 70.22
	FUND TOTALS	1,017.56
	GRAND TOTALS	1,017.56



WARRANT 032526

PAY PERIOD 07/21/2025 to 08/03/2025

CHECK DATE 08/08/2025

YEAR 2026 PERIOD 2 EXPENDITURE ENTRIES SHORT DESC 08/08/25PR GL EFF DATE 08/08/2025 REFERENCE 032526 REFERENCE2 1032526

		00,00,2	J 1 1 1
ORG YEAR 10130 10130 10130 10130 10130 10130 10140 10140 10140 10140 10140 10230 10240 10340 10340 10340 10340 10340 10340	2026	OBJECT PERIOD OSO20 OS050 OS154 OS156 OS175 OS180 OS010 OS012 OS020 OS154 OS156 OS175 OS180 OS0175 OS175 OS180 OS0175 OS175 OS180 OS0175 OS180 OS0170 OS175 OS180 OS0170 OS175 OS180 OS0170 OS175 OS180 OS0170 OS175 OS180 OS030 OS040 OS0500 OS0500 OS0500 OS0500 OS0500 OS070	PROJECT 2
10340		05111	

TOWN MANAGER TOWN CLERK/TREASURER ACCOUNTING ACCOUNTING ACCOUNTING ACCOUNTING ACCOUNTING ACCOUNTING ACCOUNTING ACCOUNTING TISTERS LISTERS LISTERS LISTERS LISTERS LISTERS FIRE DEPARTMENT FIRE DEPARTMENT FIRE DEPARTMENT FOLICE DEPARTMENT POLICE DEPARTMENT ANDULANCE DEPARTMENT AMBULANCE DEPARTMENT	ACCOUNT DESCRIPTION	EXPENDITURE
	GL EFF APPOINTED CLERICAL	DATE 08/08/2025
TOWN MANAGER	APPOINTED	2.384.75
TOWN MANAGER	CLERICAL	1,324,36
TOWN MANAGER	HEALTH INSURANCE PREMIUM	951 10
TOWN MANAGER	DENTAL INSURANCE	40.62
TOWN MANAGER	ETCA TITOURANCE	765 43
TOWN MANAGED	CUTIO CARE CONTRIR TAY	14.00
TOWN MANAGER	DETTDEMENT_VMEDC	220 10
TOWN MANAGER	KETIKEMENT-VMEKS	2 766 40
TOWN CLERK/ IREASURER	ELECTED TREASURER	2,700.40
TOWN CLERK/IREASURER	ELECTED IKEASUKEK	1 000 35
TOWN CLERK/TREASURER	APPUINTED	1,089.25
TOWN CLERK/TREASURER	HEALTH INSURANCE PREMIUM	2,024.24
TOWN CLERK/TREASURER	DENIAL INSURANCE	98.97
TOWN CLERK/TREASURER	FICA	333.30
TOWN CLERK/TREASURER	CHILD CARE CONTRIB TAX	17.37
TOWN CLERK/TREASURER	RETIREMENT-VMERS	2/9.34
ACCOUNTING	CLERICAL	2,429.82
ACCOUNTING	OVERTIME	195.46
ACCOUNTING	HEALTH INSURANCE PREMIUM	420.84
ACCOUNTING	DENTAL INSURANCE	19.90
ACCOUNTING	FICA	192.78
ACCOUNTING	CHILD CARE CONTRIB TAX	10.32
ACCOUNTING	RETIREMENT-VMERS	190.33
LISTERS	ELECTED	432.00
LISTERS	PART-TIME	585.20
LISTERS	FICA	77.81
LISTERS	CHILD CARE CONTRIB TAX	4.47
FIRE DEPARTMENT	PART-TIME	518.37
FIRE DEPARTMENT	FICA	39.66
FIRE DEPARTMENT	CHILD CARE CONTRIB TAX	2.23
FIRE DEPARTMENT	RETIREMENT-VMERS	11.18
POLICE DEPARTMENT	SUPERVISOR	3.888.00
POLICE DEPARTMENT	OFFICERS	3,972,36
POLICE DEPARTMENT	CLERICAL	2,873,60
POLICE DEPARTMENT	OVERTIME	1,965.18
POLICE DEPARTMENT	HEALTH INSURANCE PREMIUM	3.014.83
POLICE DEPARTMENT	DENTAL INSURANCE	185.95
POLICE DEPARTMENT	FTCA	933.93
POLICE DEPARTMENT	CHILD CARE CONTRIB TAX	47.22
POLICE DEPARTMENT	RETTREMENT-VMERS	1.348.10
AMBULANCE DEPARTMENT	SUPERVISOR	3.024.00
AMBULANCE DEPARTMENT	PART-TIME	5,645,63
AMBULANCE DEPARTMENT	RUN PAY	1,306,32
AMBULANCE DEPARTMENT	OT - HALE RATE ONLY	53.67
AMBULANCE DEPARTMENT	STANDBY/ON CALL	1.081.50
AMBULANCE DEPARTMENT	WEEKEND SUPERVISOR	250 00
AMBULANCE DEPARTMENT	NON EMERGENCY TRANSFERS	164 25
AMBULANCE DEPARTMENT	TRANSFER CREW-PD SHIFT	543 75
The second section of the second section secti	The state of the s	5.5.75



WARRANT 032526

PAY PERIOD 07/21/2025 to 08/03/2025

CHECK DATE 08/08/2025

YEAR 2026 PERIOD 2 EXPENDITURE ENTRIES SHORT DESC 08/08/25PR GL EFF DATE 08/08/2025 REFERENCE 032526 REFERENCE2 1032526

SHORE DES	00,00,.	23111		KLI LKLK	
ORG	OBJECT	PROJECT	ORGANIZATION TITLE	ACCOUNT DESCRIPTION DENTAL INSURANCE FICA CHILD CARE CONTRIB TAX RETIREMENT-VMERS TECHNICAL OVERTIME HEALTH INSURANCE PREMIUM DENTAL INSURANCE FICA CHILD CARE CONTRIB TAX RETIREMENT-VMERS TECHNICAL HEALTH INSURANCE PREMIUM DENTAL INSURANCE PREMIUM DENTAL INSURANCE FICA CHILD CARE CONTRIB TAX RETIREMENT-VMERS POOL DIRECTOR PART-TIME GUARDS OVERTIME FICA CHILD CARE CONTRIB TAX ZONING ADMINISTRATOR FICA CHILD CARE CONTRIB TAX ECONOMIC DEVEL COORDINATO HEALTH INSURANCE PREMIUM DENTAL INSURANCE FICA CHILD CARE CONTRIB TAX ECONOMIC DEVEL COORDINATO HEALTH INSURANCE FICA CHILD CARE CONTRIB TAX RETIREMENT-VMERS	EXPENDITURE
10340	05156		AMBULANCE DEPARTMENT	DENTAL INSURANCE	63.02
10340	05170		AMRIII ANCE DEPARTMENT	ETCA	923.05
10340	05175		AMPIN ANCE DEPARTMENT	CUTIO CARE CONTRID TAV	51 43
10340	05180		AMBULANCE DEPARTMENT	CHILD CARE CONTRIB TAX	210 24
10420	05040		AMBULANCE DEPARTMENT	KETIKEMENT-VMEKS	219.24
			HIGHWAY DEPI	TECHNICAL	13,969.99
10420	05080		HIGHWAY DEPT	OVERTIME	91.08
10420	05154		HIGHWAY DEPT	HEALTH INSURANCE PREMIUM	2,616.31
10420	05156		HIGHWAY DEPT	DENTAL INSURANCE	184.67
10420	05170		AMBULANCE DEPARTMENT AMBULANCE DEPARTMENT AMBULANCE DEPARTMENT AMBULANCE DEPARTMENT HIGHWAY DEPT GROUNDS/PARKS/FACILITIES POOL	FICA	1,052.31
10420	05175		HIGHWAY DEPT	CHILD CARE CONTRIB TAX	55.35
10420	05180		HIGHWAY DEPT	RETIREMENT-VMERS	985.68
10520	05040		GROUNDS/PARKS/FACILITIES	TECHNICAL	1.000.41
10520	05154		GROUNDS/PARKS/FACTLITIES	HEALTH INSURANCE PREMIUM	210.42
10520	05156		GROUNDS/PARKS/FACTLITTES	DENTAL INSURANCE	9.95
10520	05170		GROUNDS/PARKS/FACTI TITES	FTCA	72.52
10520	05175		GPOUNDS / PARKS / FACTLITTES	CUTIO CAPE CONTETE TAY	3 88
10520	05180		CPOUNDS / DARKS / FACTLITIES	DETTDEMENT_VMEDC	72 53
10550	05030		BOOL	POOL DIRECTOR	2 066 40
10550	05070		GROUNDS/PARKS/FACILITIES POOL POOL POOL POOL PLANNING/ZONING PLANNING/ZONING PLANNING/ZONING ECONOMIC DEVELOPMENT	PART TIME CHARGE	2,000.40
10550	05080		POOL	PART-TIME GUARDS	0,404.23
10220			POOL	OVERTIME	38.23
10550	05170		POOL	FICA	808.53
10550	05175		POOL	CHILD CARE CONTRIB TAX	46.51
10620	05020		PLANNING/ZONING	ZONING ADMINISTRATOR	1,026.80
10620	05170		PLANNING/ZONING	FICA	78.55
10620	05175		PLANNING/ZONING	CHILD CARE CONTRIB TAX	4.52
10645	05051		ECONOMIC DEVELOPMENT	ECONOMIC DEVEL COORDINATO	3.016.09
10645	05154		ECONOMIC DEVELOPMENT	HEALTH INSURANCE PREMIUM	413.34
10645	05156		ECONOMIC DEVELOPMENT	DENTAL INSURANCE	19.90
10645	05170		ECONOMIC DEVELOPMENT	FTCA	230.73
10645	05175		ECONOMIC DEVELOPMENT	CHILD CARE CONTRIR TAX	12.06
10645	05180		ECONOMIC DEVELOPMENT	PETTPEMENT_VMEPS	218 67
10013	03100		ECONOMIC DEVELOT MENT	RETERENT VINERS	210.07
				FUND, FOTALS	86,295,63
51047	05154		ELECTRIC DEPARTMENT ELECTRIC DEPARTMENT ELECTRIC DEPARTMENT ELECTRIC DEPARTMENT ELECTRIC DEPARTMENT	HEALTH INSURANCE PREMIUM DENTAL INSURANCE FICA CHILD CARE CONTRIB TAX RETIREMENT-VMERS METER READING MUNICIPAL MANAGER CLERICAL LABOR OVERTIME LABOR SUPERINTENDENT ASSISTANT TECHNICAL LABOR STAND-BY	1.866.01
51047	05156		ELECTRIC DEPARTMENT	DENTAL INSURANCE	113 65
51047	05170		ELECTRIC DEPARTMENT	ETCA INSURANCE	480 43
51047	05175		ELECTRIC DEPARTMENT	CUTIO CARE CONTRIDE TAY	24 83
51047	05180		ELECTRIC DEPARTMENT	DETERMENT VMERS	44E 13
51047	90210		ELECTRIC DEPARTMENT	KETIKEMENT-VMEKS	443.14
51047			ELECTRIC DEPARTMENT ELECTRIC DEPARTMENT	METER READING	433.02
51047	92010		ELECIKIC DEPARTMENT	MUNICIPAL MANAGER	920.38
51047	92012		ELECTRIC DEPARTMENT	CLERICAL LABOR	1,854.87
51047	92013		ELECTRIC DEPARTMENT	OVERTIME LABOR	64.79
51047	92014		ELECTRIC DEPARTMENT ELECTRIC DEPARTMENT	SUPERINTENDENT	892.60
51047	92016		ELECTRIC DEPARTMENT	ASSISTANT	1,299.08
51047	92018		ELECTRIC DEPARTMENT	TECHNICAL LABOR	1,234.09
51047	92019		ELECTRIC DEPARTMENT	STAND-BY	45.00



WARRANT 032526

PAY PERIOD 07/21/2025 to 08/03/2025

CHECK DATE 08/08/2025

YEAR 2026 PERIOD 2 EXPENDITURE ENTRIES
SHORT DESC 08/08/25PR GL EFF DATE 08/08/2025 REFERENCE 032526 REFERENCE2 1032526

SHURT DESC 08/00	6/23PR		REFERENCE2	1032320
ORG OBJECT	T PROJECT	ORGANIZATION TITLE	ACCOUNT DESCRIPTION FUND TOTALS	9,682.07
53045 05020 53045 05030 53045 05042 53045 05080 53045 05090 53045 05154 53045 05156 53045 05170 53045 05175 53045 05175 53045 05180		WATER DEPARTMENT	APPOINTED SUPERVISOR TECHNICAL/ADMIN/CLERICAL OVERTIME STANDBY/ON CALL HEALTH INSURANCE PREMIUM DENTAL INSURANCE FICA CHILD CARE CONTRIB TAX RETIREMENT-VMERS FUND TOTALS	527.60 1,606.68 5,544.63 235.73 153.00 1,383.74 126.46 590.30 30.58 550.78
55046 05020 55046 05030 55046 05080 55046 05090 55046 05154 55046 05154 55046 05170 55046 05175 55046 05175		SEWER DEPARTMENT	APPOINTED SUPERVISOR TECHNICAL/ADMIN/CLERICAL OVERTIME STANDBY/ON CALL HEALTH INSURANCE PREMIUM DENTAL INSURANCE FICA CHILD CARE CONTRIB TAX RETIREMENT-VMERS FUND TOTALS	379.87 1,071.12 3,680.06 1,010.28 102.00 1,110.15 99.10 456.02 23.62 429.75 8,361.97
			GRAND TOTALS 7	*115¢088.87

TOWN OF NORTHFIELD, VERMONT TOWN FOREST STEWARDSHIP COMMITTEE Minutes of July 15, 2025

I. ROLL CALL

Ginny, Russ, Bill, Jeremy, Andrew, Ray came late.

Sam Schonberg from the public

II. PUBLIC PARTICIPATION (SCHEDULED): None.

III. APPROVAL OF MINUTES: June 17, 2025

IV. AGENDA UPDATES OR ADDITIONS

V. UPDATES & DISCUSSION

- a. Introduction of New Member: Bill Dell'Isola
- **b. Shaw Outdoor Center Update**

Field past the paintball shed got mowed a few weeks ago.

Mowing scheduled for August for the rest of the property.

Possible mulching around the paintball field tbd

2 more weeks of summer programming

Rook week is 8/16

Jeremy and Andrew anticipate getting in front of some of the cadre before the school year gets going

c. Vermont Youth Conservation Corps (VYCC) Work update

Jeremy gives update that VYCC is finished with the trail bypass. He says they built well defined drainage. Renaturalization efforts were made to conceal the old section. Possible plans to move the butternut tree sign. VYCC has started working on clearing the beaver pond vista view. With remaining funds, two benches and a sign will be put in at the beaver pond vista. VYCC will be directed back to Garvey to clean up some additional drainage. Total project work completed - tree work on Garvey Hill, butternut junction reroute, beaver pond vista, and drainage work on Garvey.

d. Cheney Field Parking

Ginny pointed out that we did not have an official vote on parking in Cheney Field after water tank project wraps up.

Mobility task force chair has requested to speak at the next NCC meeting

Jeremy gives the floor to Russ in order to discuss the impacts of parking in the field

Recap - study done by VOREC/Ridge and Rivers looking for possible spots for parking for the town forest

DB&K did the study. They determined that street parking nor parking in the field would be viable.

They did note that accessibility to the Town Forest was an issue.

Jeremy reminds us that our directive is to protect the field environment. He hopes that the field will be returned to its original state after the construction is done.

What happens if we add a parking lot to the field. How does this help a person with accessibility issues enjoy the town forest?

Do we have to make ADA compliant trails? Should we?

The road is not wide enough for two cars to pass.

There are already issues with people misusing the field to have campfires.

There are questions about how this would change the way Norwich uses the field.

Bill adds perspective - this would impact conservation values of the forest. There would be no going back after this structure is put in place, and a disruption to forest habitat blocks.

Bill asks how ongoing maintenance would be funded.

Public participation - Sam Schonberg - indigo bunting - this person tried to take their elderly mom up to see these nests in the field. They recognized that the logistical and financial costs would be prohibitive. They were not able to make it up there to see. Is it fair to have this resource that some residents cannot utilize?

There is legal parking on Byam with restrictions of 250 ft from the gate on the public road.

Ginny reminds us that we have a town forest without any parking and does not think this is fair or equitable.

Bill asks what the NCC thinks about this. NCC has informed the Select Board that they are not in favor.

The Select Board advised the citizen to discuss with the NCC. They are on the agenda for the NCC meeting this month.

Motion - TFSC's stance is no parking in the field. We recognize it's not fair that we have this public resource that is not accessible. We support ongoing discussions to improve accessibility in the Town Forest. Ray puts motion forward - Bill seconds - 3-0-2 - passes.

e. Town Forest Plan

Robert Nelson is trying to update the old Town Forest Plan. He has done an inventory and has what he needs to put the plan together. Having this plan will be critical to ongoing efforts for easements and funding. Last plan was put together in 2010. We will keep trying to get an update.

VI. PUBLIC PARTICIPATION (UNSCHEDULED)

Sam is interested in being involved in the disc golf course if the opportunity exists.

Andrew recaps the situation up till now. Andrew has an intern that may be working on this project. Andrew offers to connect with Sam via email.

VII. OTHER BUSINESS

Discussion about Lybrand. Norwich is still pursuing FEMA funding.

Ray asks what the mechanism is to have more community trail maintenance and construction. Jeremy says we would need to do more homework on how this is working in other jurisdictions.

Future Agenda Items

Ongoing trail workdays.

List of projects for VYCC or just general project for community workdays.

- Mowing/weed eating
- Water bars
- Dustin's Pasture site walk
- Moving the Paine mtn mile markers
- On Clark there are some 6x6s that could be cleaned up or turned into a bridge
- Old signage inventory
- Clean up tree with barbed wire
- Hawk watch vista clearing for student volunteer day
- VYCC invasive control?

VIII. ADJOURNMENT

Russ motions to adjourn - Ray 2nd - 5-0-0

Minutes Northfield Conservation Commission July 23,2025

- 1. Roll Call: David, Mariela, Nigel, Russ, Debbie, Suz, Jeremy & Ruth Members of the public: Laura Hill-Eubanks, Mary Nadon Scott, Janan Hamm, Bill Clemmons, Tim Swartz, Gerard Lavarnway
- 2. No updates to agenda
- 3. Public Participation scheduled:
 - A. Cheney Field Access/parking discussion

Members of the public, including representatives from the Accessibility, Walkability, and Pedestrian Safety Task Force and the commission offered feedback on the idea that a heavy equipment staging area related to the water tank project could remain post-construction and serve as an accessible parking lot for Cheney Field and Town Forest.

Suz and Jeremy presented a number of questions that require answers prior to any development of access or parking in Cheney Field:

- Permit needed
- Need for an engineered plan, including what else is needed besides the surface (signage, a way to keep vehicles from entering the rest of the town forest, etc.)
- Timeline for the decision to be made in regards to the contractor
- Road crew feedback
- Water dept feedback
- What happens after parking? Accessible trail? USFS standards?

David proposed to draft a communication to the Select Board detailing questions raised in this discussion. 2nd by Russ. The motion passed, Jeremy abstaining.

There was general agreement that NCC supports improved access for the town forest and working with the Walkability Accessibility Safety Group was a step to address this issue. David proposed that NCC schedule meetings with the Walkability, Accessibility Group to begin a work group process to discuss Town Forest Accessibility. 2nd by Suz. Unanimous.

4. Minutes of the June 25, 2025 meeting were approved on a motion by Russ, 2nd by Jeremy. Unanimous.

5. Discussion

- A. Cheney Field Restoration: David summarized the role of NCC as serving to advise the Select Board using our experience and knowledge. Members expressed concern that the information provided by Town Manager regarding the contract language was insufficient to conclude whether the damage done to the field from the road would be restored by the contractor. David agreed to convey the NCC's concerns to the Select Board.
- B. Clean Water Workshop and Reconnecting with Rivers Cohort Meeting: The cohort includes Barre, Winooski and Northfield. Idea to have speakers with river science knowledge was offered.
- C. Upcoming Riverwalk Events: Appreciation expressed to Janan for organizing river walks and agreement that NCC would like to help support future walks and related activities to strengthen community connection to the Dog River.

D. Upcoming Meetings

- 1. Berlin Conservation Commission re: Shared Northfield/Berlin Conservation Opportunities on September 3, at 4:30 Berlin Town Offices
- 2. Meeting with the Mad River Valley Conservation Commission re: Shared Mad River Valley/Northfield Conservation Opportunities to be scheduled
- 3. Jens Hilke, VT Fish and Wildlife re: Vermont Conservation Design Priorities in the Northfield Range August 1, at 11:00 a.m.

- 6. Updates: Postponed
 - a. Climate Smart School Yards Grant
 - b. VYCC Youth Trails Improvement Project
 - c. Town Forest Stewardship Committee
- 7. Public Participation Unscheduled: none
- 8. The meeting was adjourned at 8:20 on a motion by Nigel, 2nd by Ruth.

CENTRAL VERMONT REGIONAL PLANNING COMMISSION EMERGENCY MUTUAL AID AGREEMENT FOR THE PUBLIC WORKS DEPARTMENTS OF ITS MEMBER MUNICIPALITIES

This Mutual Aid Agreement (the "Agreement") is entered into between the Central Vermont Regional Planning Commission ("CVRPC") and by and among each member municipality that voluntarily executes and adopts the terms and conditions contained herein.

WHEREAS, the Vermont Supreme Court has held and adopted the position that "It is a general and undisputed proposition of law that a municipal corporation possesses and can exercise the following powers, and no others: First, those granted in express words; second, those necessarily or fairly implied in or incident to the powers expressly granted; third, those essential to the accomplishment of the declared objects and purposes of the corporation—not simply convenient, but indispensable." "Valcour v. Vill. of Morrisville, 104 Vt. 119, 158 A. 83, 85 (1932), citing Dillon, John, The Law of Municipal Corporations (5th Ed.) par. 237; and

WHEREAS, that upon the adoption of bylaws specifying the process for entering into, method of withdrawal from, and method of terminating service agreements with municipalities, the Vermont Legislature has granted express authority for regional planning commissions to "promote cooperative agreements and coordinate, implement, and administer service agreements among municipalities, including arrangements and action with respect to planning, community development, joint purchasing, intermunicipal services, infrastructure, and related activities...." 24 V.S.A. § 4345b(c); and

WHEREAS, the member municipalities of the CVRPC (collectively the "Parties") may voluntarily agree to participate in mutual aid and public works assistance activities conducted pursuant to 24 V.S.A. § 4345b(d)(2); and

WHEREAS, the CVRPC has duly adopted bylaws pertaining to the creation of intermunicipal service agreements pursuant to 24 V.S.A. § 4345b(a) and (b); and

WHEREAS, the Parties recognize that they are vulnerable to a variety of potential, natural and man-made disasters that impact vital public works resources including hurricanes, flooding and extreme winter conditions that in the past have caused severe disruption of essential public works services and severe property damage to public roads, utilities and other public works property; and;

WHEREAS, owning and maintaining all the resources needed to respond to extreme, unexpected and high-demand incidents is cost-prohibitive for most municipalities and entering into a mutual aid agreement provides economic and logistical efficiencies to support any gaps in resources and capabilities; and

WHEREAS, the Parties to this Agreement recognize the benefits of mutual aid in protecting the public, health, safety and welfare and fostering a sense of goodwill and community within a specific geographic region and therefore desire to provide mutual aid and assistance to one another during times of disaster and other types of public works emergencies; and

WHEREAS, the Parties recognize that having this mutual aid agreement and related guidelines is essential to ensuring a consistent, coordinated, and timely response in providing mutual aid; and

NOW, THEREFORE, the Parties hereto agree as follows:

SECTION 1: PURPOSE

The Agreement set forth below, is established to provide a means for public works related entities that are controlled by the CVRPC member municipalities, that are in need of mutual aid assistance, to be able to request and receive such aid and assistance in a timely manner from the participating member municipalities including but not limited to personnel, equipment, materials and any other services that may be reasonably necessary to respond to an emergency. The purpose of this Agreement is to formalize the regional mutual aid program. This Agreement to render aid is expressly not contingent upon a declaration of a major disaster or emergency by the federal government or upon receiving federal funds.

SECTION 2: DEFINITIONS

- A. Aid and Assistance includes, but is not limited to, personnel, equipment, administrative services, infrastructure, supplies and materials necessary to respond to a request for mutual aid.
- **B.** Aiding Official means a person who is designated by the Aiding Party to determine whether and to what extent the Aiding Party should provide Public Works Assistance to a Requesting Party.
- C. Aiding Party means a Constituent Municipal entity that furnishes, equipment, services, personnel or any other Public Works assistance to a Requesting Party.
- D. Agreement refers to this Agreement for public works emergency services. The Central Vermont Region municipalities may become a party to this Agreement upon ratification of this Agreement by the CVRPC and ratification by the legislative body of the Constituent Municipality that is a party to this Agreement. Each Constituent Municipality that ratifies this Agreement, understands that the Agreement contains all Constituent Municipal entities at the time of ratification, and any other eligible municipality in the future.

- E. Constituent Municipality Any municipality located in the Central Vermont Regional Planning Commission service area in Vermont that is a party to this Agreement.
- F. Disaster any natural, mechanical, human-made, technological, or civil emergency that threatens to cause damages of a severity and scale that exceeds the maximum capabilities of a Constituent Municipality.
- G. Emergency an event or imminent potential for such an event, either natural or human caused, that results in or may result in, injury or harm to the residences of the Constituent Municipality, or damage to or loss of property.
- H. Mutual Aid Resource List A list maintained by each Constituent Municipality of the public works equipment, personnel and any other resources available for the provision of aid and assistance if needed by another Constituent Municipality.
- I. Period of Assistance the period of time beginning when the Aiding Party assists the Requesting party by providing equipment, personnel, supplies or any other Public Works Assistance and ending when all Public Works Assistance returns to the regular duties of the Aiding Party.
- J. Public Works Assistance means equipment and personnel including, but not limited to; professional engineers, licensed staff, non-licensed personnel who are employed by a Constituent Municipality and used for activities in response to a disaster or emergency, related to roadways, water, stormwater, wastewater and any other public works program.
- K. Requesting Official means any person who is designated by the Requesting Party to request Public Works Assistance from a participating Aiding Party.
- L. Requesting Party means a Constituent Municipal entity that requests, equipment, services, personnel or any other Public Works assistance from an Aiding Party.

SECTION 3: PROCEDURES

- A. Operations Oversight The CVRPC shall be responsible for overseeingthis Agreement and help to facilitate communications between the Constituent Municipalities. The CVRPC will also help to facilitate policies and procedures to guide requests for aid and assistance as set forth below.
- B. Request for Aid When a Requesting Party has been impacted by or is in imminent danger of a disaster or emergency, it may request Aid and Assistance from an Aiding Party, by making a verbal request, followed by a written request, to the Aiding Party, within three business days after aid is

needed or contemplated to be needed. An Aid Request Form shall be an addendum, but not an amendment to or modification of this Agreement. Requests should be made by and to the Aiding Party's authorized Aiding Official. A potentially Aiding Party, should not provide aid on its own without first confirming the need for assistance through the communication of the Aiding Official and Requesting Official to ensure that the type of aid being provided is necessary and needed. The provision of aid by an Aiding Party is entirely discretionary under this Agreement and the ultimate decision as to whether to render aid to a Requesting party shall be at the discretion of the Aiding Official in consultation with the legislative body of the Constituent Municipality if possible.

- C. Designation of Officials Each Constituent Municipality shall designate an Aiding Official and Requesting Official and at least one alternate Aiding Official and Requesting Official. Each Constituent Municipality shall be responsible for maintaining its own contact list of all Aiding and Requesting Officials and alternate Officials, along with all means of contact including, but not limited to cell phones, telephones, electronic mail and physical addresses and take reasonable steps to ensure that all Constituent Municipalities have the most current list. The CVRPC shall help develop the template of the contact list and annually aid in its distribution after having been provided by the Constituent Municipalities. Said list shall be an addendum, but not an amendment to or modification of this Agreement. The Requesting Officials and the Aiding Officials may be the same person in each municipality (i.e. a director of public works or Road Commissioner).
- D. Information Needed Request for Aid and Assistance The Requesting Official shall provide, at minimum, to the Aiding Official and CVRPC (for informational purposes only): 1) a description of the disaster or emergency prompting the request; 2) what type of specific assistance is needed; 3) a description of the infrastructure impacted and the specific work needed to repair the infrastructure; and 4) an estimate of the type of public works assistance needed and the period of time it will be needed for. It is further recommended that the Requesting Official propose a plan for meeting with the Aiding Official to discuss the scope of the aid and for the Requesting Official to familiarize him or herself with the personnel and equipment of the Aiding Party (similar in nature to a pre-construction meeting). The Aiding Party shall then provide an estimate to the Requesting Party of expected costs for the scope of work requested and needed.
- E. Supervision and Control It is the intention of this Agreement that supervision and control of personnel will be structured in accordance with Federal Emergency Management Agency's (FEMA) Incident Command System (ICS) of the National Incident Management System (NIMS), and that if the emergency/disaster is multi-jurisdictional, a Unified Command will be employed when practical.

- 1. When any personnel or equipment is deployed under the terms of this agreement, the Aiding Official shall meet with the Requesting Official. Orders by the Requesting Official will be given to the Aiding Official who will then give orders or direction to their personnel. The Aiding Official shall maintain reasonable contact with the Requesting Official as long as the Aiding Party is providing Public Works Assistance. The personnel of the Aiding Party may only be under the direct control of the Requesting party by a written mutual agreement.
- 2. In all instances and at all times, the Requesting Official or a designee thereof, shall have the right and responsibility to ensure that all personnel from the Aiding Party are asked to perform only those tasks or operations that are consistent with their training and are in accordance with their home protocols and accepted safe practices.
- 3. Personnel from the Aiding Party shall continue with the assigned tasks until the Requesting Party releases said personnel and equipment or until the Aiding Party recalls said personnel and equipment. No recall by an Aiding Party shall occur until, if reasonable given the facts and circumstances, the Aiding Official discusses the need for recall with the Requesting Official.
- 4. Each Aiding Party shall operate in accordance with the protocols of its Constituent Municipality, and all Aiding Party personnel shall act within the scope of his or her own training and certification or under the supervision of a person with the appropriate training and certification. Aiding Party personnel shall not be required to perform in a way that is inconsistent with the practices of their Constituent Municipality protocols or inconsistent with safe practices.
- 5. The Aiding Official shall be responsible for maintaining all records for time, materials and equipment provided to the Requesting Party; be responsible for the operation and maintenance of equipment provided by the Aiding Party; and report work process to the Requesting Party.
- F. Mutual Aid Resource List NIMS typed public works resources are included in the annual local emergency plan for each Constituent Municipality. The CVRPC shall annually distribute a list of the NIMS typed public works resources for all Constituent Municipalities. All original and updated NIMS typed public works resource lists shall be considered an addendum to, but not a modification of this Agreement.
- G. Funds Payable By Each Municipality the Constituent Municipalities agree that the funds, coming in the form of the amount of services provided by each Constituent Municipality shall be based on the resources available to them at the time aid and assistance is made by a Requesting Party in accordance with Section 4 Part A.

SECTION 4: REQUESTS FOR REIMBURSEMENT

- A. Procedures for Reimbursement Unless the Aiding Party and the Requesting Party agree to a different structure in writing, the Requesting Party shall be ultimately responsible for the reimbursement of the Aiding Party's costs incurred under this Agreement.
 - Within 30 days of the return of all personnel and equipment of the Aiding Party to the Constituent Municipality's homework station, the Aiding Municipality may submit to the Requesting Party, an invoice of all charges related to the aid provided pursuant to this Agreement. The invoice provided by the Aiding Party shall be paid within 30 days of receipt.
 - 2. All invoices generated by the Aiding Party shall be provided to the Requesting Party.
 - 3. Invoices by the Aiding Party shall follow the following standards.
 - a. Personnel. Charges for personnel shall be in accordance with the standard practices of the Aiding Party, including wages, salaries, contributions for insurance and retirement and personnel from the Aiding Party shall continue to accumulate seniority at the rate of the Aiding Party.
 - b. Equipment. Charges for equipment supplied by the Assisting Party, shall be reimbursed at the rental rate established for the same or substantially similar equipment by the regulations of the Federal Emergency Management Agency (i.e., current FEMA Schedule of Equipment Rates), or at any other rate agreed to by the Aiding Party and Requesting Party in writing. Rent for equipment includes the cost of fuel and other consumable supplies, maintenance, service, repairs and ordinary wear and tear.
 - c. Transportation. The Aiding Party shall transport needed personnel and equipment by reasonable and customary means and in accordance with the Aiding Party's usual transportation and travel payment schedule. If such a schedule is unavailable, transportation charges shall be the reasonable and customary rates for such transportation.
 - d. Materials and Ancillary Expenses. Charges for materials and ancillary expenses such as consumable supplies, related to the provision of aid pursuant to this agreement shall be the reasonable and actual costs incurred by the Aiding Municipality.

4. The Aiding Party may invoice the Requesting Party for all expenses incurred during the Period of Assistance. All invoices shall be submitted by the Aiding Official to the Requesting Official. The invoices shall clearly delineate the time and expenses associated with personnel, equipment, transportation and any materials or ancillary expenses. Any question or dispute about an invoice from an Aiding Party shall first be discussed between the Requesting Official and the Aiding Official. If the Parties are still unable to reconcile an invoice, then they shall follow the next sequential procedures of the Dispute Resolution section of this Agreement.

SECTION 5: INSURANCE AND LIABILITY

- A. Insurance Each Constituent Municipality shall bear the risk of its own actions, as it does with its day-to-day operations. The Aiding Party shall be responsible for providing insurance to the fullest extent possible, including but not limited to workman's compensation insurance, general liability insurance, excess liability insurance, and any other types of insurance coverage in amounts recommended by the Vermont League of Cities and Towns, Property and Casualty Intermunicipal Fund (VLCT-PACIF). Such insurance shall cover damage or injury to person, property or equipment owned or provided by an Aiding Party to the extent the damage or injury may have occurred while rendering aid to a Requesting Party.
- B. Indemnification To the extent allowed by law, each Requesting Party agrees to indemnify and hold harmless any Aiding Party and its employees, officers, administrators, elected officials and agents from any claim relating to cost, damage or injury of any description to any person or property caused by or through the action of any Aiding Municipality while rendering aid pursuant to his Agreement. Acts of gross negligence, willful misconduct, malfeasance, and/or criminal/illegal behavior are exempt from indemnification.
- C. Liability No Constituent Municipality shall have any liability to any other Constituent Municipality by reason of their inability or lack of desire to respond to a request for aid.

SECTION 6: TERM, MODIFICATION AND PERIODIC REVIEW

- A. Term This Agreement shall be in effect for one (1) year from the date signed by the initial Constituent Municipality. Thereafter, this Agreement shall be renewed for additional one year terms on an annual basis in conjunction with the local emergency plan.
- **B.** Termination Any Constituent Municipality may voluntarily terminate and withdraw from its participation in this Agreement at any time by a Requesting or Aiding Official giving written notification to the designated Requesting or Aiding

Officials of all other Constituent Municipalities to this Agreement. Electronic mail communications shall be considered written notification for purposes of this Agreement. Termination and withdrawal shall not be effective until sixty (60) days after written notification has been sent. Withdrawal by a Constituent Municipality shall not impact the liability or obligation incurred by the Constituent Municipality under this Agreement prior to the date of termination.

- C. Modification Pursuant to 24 V.S.A. § 4345b(d)(4) any modification or amendment to this Agreement shall not become effective unless approved by the CVRPC and the legislative body of all the municipalities who are a party to this Agreement. The CVRPC shall assist in coordinating any modifications or amendments to this Agreement.
- **D. Periodic Review** On a biennial basis, the designated Aiding and Requesting Officials shall meet to review the terms of this Agreement and make any suggestions as to alterations or modifications if needed base on past performance. The CVRPC shall coordinate all meetings under this section.

SECTION 7: MISCELLANEOUS PROVISIONS

- A. Dispute Resolution In respect to any dispute that arises pursuant to this agreement the Parties shall first make a good faith effort to work out differences among themselves. Should informal discussions between the Parties fail, then the Parties shall engage the services of a mutually agreed upon third party mediator. The costs of this third party mediator shall be split evenly between the Parties. Should attempts at mediation though a third party mediator fail, then any Party may seek redress in any Vermont Court of competent jurisdiction.
- B. Severability Should any clause, portion, section, provision or any other part of this Agreement be held invalid by a court of competent jurisdiction, such judgment shall not affect, impair or invalidate any other portion of the Agreement. The remaining portions of this Agreement shall remain in full force and effect without regard to the provisions that have been invalidated.
- C. Execution of Counterparts This agreement may be signed in any number of counterparts with the same effect as if the signatures thereto and hereto were upon the same instrument.

NOW THEREFORE, both the Central Vermont Regional Planning Commission through its duly authorized representative has executed this agreement and all counterparts thereto.

Photographic copies shall be considered valid counterparts.

Each of the Constituent Municipalities so desiring, have caused this Agreement to be executed by a duly authorized representative, after a vote allowing that duly authorized representative to execute this Agreement by the Constituent Municipality's governing

legislative body.

Adopted by the Board of Commissioners: January 14, 2025.

Cerald D'Amico, Chair CVRPC Board of Commissioners

Photographic copies shall be considered valid counterparts.

Each of the Constituent Municipalities so desiring, have caused this Agreement to be executed by a duly authorized representative, after a vote allowing that duly authorized representative to execute this Agreement by the Constituent Municipality's governing legislative body.

The following municipalities have elected to participate in the Central Vermont Regional Public Works Mutual Aid Agreement for 2025. Copies of signature pages are on file at the Central Vermont Regional Planning Commission.

2025 Central Vermont Regional Public Works Mutual Aid Agreement Participating Municipalities: Listed on next page.

Municipalities

Barre City	Plainfield
Barre Town	Roxbury
	Waitsfield
Berlin	N 2
Cabot	Warren
Calais	Washington
Duxbury	Waterbury
East Montpelier	Williamstown
Fayston	Worcester
Middlesex	Woodbury
Montpelier	-:
Moretown	-
Northfield	
Orange	-

CENTRAL VERMONT REGIONAL PLANNING COMMISSION PUBLIC WORKS MUTUAL AID AGREEMENT AID REQUEST FORM

To be completed by the Requesting Official.

Requesting Municipality: Town/City of
Incident Name: Briefly describe the nature of the disaster or emergency prompting the aid request.
Damages and Needed Repairs: Briefly describe the infrastructure impacted and the specific work needed to repair the infrastructure.
Specific Assistance Needed: Briefly describe what type of assistance (personnel, equipment, materials) is needed.
Cost Estimate and Schedule: Provide an estimate for the needed assistance and period of time it will be needed for (start and end dates).
Plan for Meeting with Aiding Official to Review Project Scope (Optional): Briefly describe, if needed, the Requesting Official's plan for meeting with the Aiding Official to review the scope of work and for the Requesting Official to familiarize him/herself with the personnel and equipment of the Aiding Party.
Requesting Official Signature:
Date: Time:
To be completed by the Aiding Official.
Request: Approved Denied (Reason)
Resource Deployed: Date: Time:
Cost Estimate:
Aiding Official Signature:
Date: Time:

DESIGNATED OFFICIALS BY TOWN

Municipality	Name	Phone - Primary	Phone - Alternate	Email
Barre City				
Requesting Official - Primary				
Requesting Official - Alternate				
Aiding Official - Primary				
Aiding Official - Alternate				
Barre Town				
Berlin				*
эегин	 			
Cabot		+		
340			2	
				and the literature
Calais				
Duxbury				
	1			
	3			
East Montpelier				
east Montpeller	-	-		

DESIGNATED OFFICIALS BY TOWN

ayston				
farshfield				
			+	
fiddlesex				
nockser				
lontpelier				1
		+		
		†		
loretown				
		 		
orthfield				
range				
				

DESIGNATED OFFICIALS BY TOWN

(m)				
				11
Plainfield				
Roxbury				
				·
Waitsfield				
2				
			•	
Warren				
	·			
Washington				
		-		
		-		
Williamstown				
0/ 11		-		
Woodbury				

DESIGNATED OFFICIALS BY TOWN

			ester
_			

NIMS TYPED PUBLIC WORKS RESOURCES BY TOWN FOR 2022

	Town 1	
Marine Vessel	TOWILI	
Firefighting, Brush Patrol Engine		
Fire Engine (Pumper)		
Firefighting Crew Transport		
Hand Crew		
Water Tender (Tanker)		
Air Compressor Generator		
Grader		
Hydraulic Excavator, Medium Mass Excavation		
Street Sweeper		
Snow Blower (Track Mounted)		
Track Skid Steer		
Track Loader		
Trailer, Equipment Tag Trailer		
Truck, On-Road Dump		
Truck, Plow		
Water Pumps, De-Watering		
Water Truck		
Wheel Loader, Backhoe		
Wheel Loader, Small		
Wheel Loader, Medium		
Wheel Loader, Large		
Wood Chipper		

TOWN OF NORTHFIELD AMBULANCE ABATEMENTS

\$133.10	Name	Balance	Date of Service
\$136.54 \$22.90 \$109.89 \$05/11/20 \$109.89 \$05/20/20 \$946.50 \$946.50 \$05/21/20 \$118.52 \$05/25/20 \$147.60 \$922.70 \$06/11/20 \$250.00 \$06/14/20 \$135.31 \$07/03/20 \$124.78 \$07/06/20 \$124.78 \$07/06/20 \$1441.90 \$07/22/20 \$988.00 \$07/27/20 \$988.00 \$07/27/20 \$988.35 \$853.70 \$80/2/20 \$98.35 \$98.35 \$08/12/20 \$98.35 \$08/12/20 \$107.82 \$107.82 \$100.00 \$107.82 \$100.00 \$129.61 \$100.00 \$129.60 \$100.00 \$129.60 \$100.00 \$100		\$41.00	04/02/20
\$22.90 \$109.89 \$05/13/20 \$127.78 \$05/20/20 \$946.50 \$118.52 \$05/25/20 \$118.52 \$147.60 \$922.70 \$6/11/20 \$250.00 \$6/14/20 \$135.31 \$07/03/20 \$124.78 \$07/06/20 \$124.78 \$07/06/20 \$144.90 \$7/22/20 \$988.00 \$07/27/20 \$988.00 \$07/27/20 \$988.35 \$853.70 \$86/2/20 \$98.35 \$853.70 \$86/2/20 \$98.35 \$98.35 \$86/12/20 \$98.35 \$107.82 \$107.82 \$100.00 \$100.00 \$12/20 \$100.00 \$129.61 \$100.00 \$129.60 \$100.00 \$129.60 \$100.00 \$100.		\$133.10	04/13/20
\$109.89		\$136.54	05/01/20
\$127.78 \$946.50 \$946.50 \$5118.52 \$118.52 \$147.60 \$952.70 \$147.60 \$922.70 \$06/11/20 \$250.00 \$06/14/20 \$135.31 \$07/03/20 \$124.78 \$07/06/20 \$124.78 \$07/06/20 \$1,441.90 \$07/22/20 \$988.00 \$07/27/20 \$988.35 \$08/01/20 \$98.35 \$08/01/20 \$98.35 \$08/12/20 \$98.35 \$08/12/20 \$98.35 \$08/12/20 \$98.35 \$08/12/20 \$107.82 \$107.82 \$107.82 \$107.82 \$100.00 \$250.00 \$08/26/20 \$250.00 \$08/26/20 \$250.00 \$250.00 \$08/26/20 \$250.00 \$08/26/20 \$250.00 \$08/26/20 \$250.00 \$08/28/20 \$100.00 \$09/01/20 \$129.61 \$09/04/20 \$72.47 \$09/07/20 \$110.00 \$129.61 \$09/04/20 \$72.47 \$09/07/20 \$110.00 \$110.00 \$129.61 \$109/04/20 \$72.47 \$109/07/20 \$110.00 \$110.00 \$110.00 \$129.61 \$110.00 \$110.		\$22.90	05/11/20
\$946.50 \$118.52 \$118.52 \$147.60 \$922.70 \$6/11/20 \$250.00 \$6/14/20 \$135.31 \$7/03/20 \$250.00 \$7/03/20 \$124.78 \$7/06/20 \$124.78 \$7/06/20 \$250.00 \$7/09/20 \$1,441.90 \$7/22/20 \$988.00 \$7/27/20 \$215.84 \$8/01/20 \$8853.70 \$8/02/20 \$98.35 \$8/12/20 \$98.35 \$08/12/20 \$98.35 \$08/12/20 \$107.82 \$107.82 \$107.82 \$89.94 \$89.94 \$89.94 \$8/25/20 \$100.00 \$8/26/20 \$250.00 \$9/14/20 \$250.00 \$9/14/20 \$242.32 \$993.10 \$9/14/20 \$242.32 \$9/29/20 \$108.05 \$109.02 \$1108.05 \$107/20 \$2120.01 \$2120.01 \$2120.01 \$2120.01 \$2120.01 \$2120.01 \$220		\$109.89	05/13/20
\$118.52		\$127.78	05/20/20
\$147.60		\$946.50	05/21/20
\$922.70 06/11/20 \$250.00 06/14/20 \$135.31 07/03/20 \$250.00 07/03/20 \$124.78 07/06/20 \$124.78 07/06/20 \$124.78 07/06/20 \$1,441.90 07/22/20 \$988.00 07/27/20 \$215.84 08/01/20 \$215.84 08/01/20 \$255.00 08/12/20 \$98.35 08/12/20 \$250.00 08/12/20 \$107.82 08/14/20 \$107.82 08/14/20 \$100.00 08/26/20 \$100.00 08/26/20 \$250.00 08/28/20 \$100.00 09/01/20 \$129.61 09/04/20 \$72.47 09/07/20 \$129.61 09/04/20 \$72.47 09/07/20 \$129.61 09/04/20 \$2242.32 09/29/20 \$170.37 09/30/20 \$108.05 10/07/20 \$140.20 10/21/20 \$83.28 10/25/20 \$250.00 10/25/20 \$250.00 10/25/20		\$118.52	05/25/20
\$250.00 06/14/20 \$135.31 07/03/20 \$250.00 07/03/20 \$124.78 07/06/20 \$124.78 07/06/20 \$250.00 07/09/20 \$1,441.90 07/22/20 \$988.00 07/27/20 \$215.84 08/01/20 \$2515.84 08/01/20 \$853.70 08/02/20 \$98.35 08/12/20 \$250.00 08/12/20 \$107.82 08/14/20 \$107.82 08/14/20 \$100.00 08/26/20 \$100.00 08/26/20 \$250.00 08/28/20 \$100.00 09/01/20 \$129.61 09/04/20 \$129.61 09/04/20 \$72.47 09/07/20 \$129.61 09/04/20 \$129.61 09/04/20 \$129.61 09/04/20 \$129.61 09/04/20 \$120.00 09/14/20 \$120.00 09/14/20 \$120.00 09/14/20 \$120.00 09/14/20 \$120.00 09/14/20 \$120.00 09/14/20 \$120.00 09/14/20 \$120.00 09/14/20 \$120.00 09/14/20 \$120.00 09/14/20 \$120.00 09/14/20 \$120.00 09/14/20 \$220.00 09/14/20		\$147.60	05/31/20
\$135.31 07/03/20 \$250.00 07/03/20 \$124.78 07/06/20 \$124.78 07/06/20 \$250.00 07/09/20 \$1,441.90 07/22/20 \$988.00 07/27/20 \$215.84 08/01/20 \$4853.70 08/02/20 \$98.35 08/12/20 \$250.00 08/12/20 \$107.82 08/14/20 \$107.82 08/14/20 \$100.00 08/26/20 \$100.00 08/26/20 \$250.00 08/28/20 \$100.00 09/01/20 \$129.61 09/04/20 \$129.61 09/04/20 \$129.61 09/04/20 \$129.61 09/04/20 \$129.61 09/04/20 \$129.61 09/04/20 \$129.61 09/04/20 \$129.61 09/04/20 \$120.00 09/14/20 \$120.00 09/14/20 \$120.00 09/14/20 \$120.00 09/14/20 \$120.00 09/14/20 \$120.00 09/14/20 \$120.00 09/14/20 \$120.00 09/14/20 \$120.00 09/14/20 \$120.00 09/14/20 \$120.00 09/14/20 \$220.00 09/14/20		\$922.70	06/11/20
\$250.00 07/03/20 \$124.78 07/06/20 \$250.00 07/09/20 \$1,441.90 07/22/20 \$988.00 07/27/20 \$215.84 08/01/20 \$853.70 08/02/20 \$98.35 08/12/20 \$250.00 08/12/20 \$107.82 08/14/20 \$107.82 08/14/20 \$100.00 08/26/20 \$250.00 08/28/20 \$100.00 09/01/20 \$129.61 09/04/20 \$72.47 09/07/20 \$993.10 09/14/20 \$72.47 09/07/20 \$993.10 09/14/20 \$108.05 10/07/20 \$140.20 10/21/20 \$83.28 10/25/20 \$250.00 10/25/20 \$250.00 10/25/20		\$250.00	06/14/20
\$124.78		\$135.31	07/03/20
\$250.00 07/09/20 \$1,441.90 07/22/20 \$988.00 07/27/20 \$215.84 08/01/20 \$853.70 08/02/20 \$98.35 08/12/20 \$250.00 08/12/20 \$107.82 08/14/20 \$89.94 08/25/20 \$100.00 08/26/20 \$100.00 09/01/20 \$129.61 09/04/20 \$72.47 09/07/20 \$129.61 09/04/20 \$72.47 09/07/20 \$170.37 09/30/20 \$170.37 09/30/20 \$108.05 10/07/20 \$140.20 10/21/20 \$83.28 10/25/20 \$250.00 10/25/20 \$250.00 10/25/20		\$250.00	07/03/20
\$1,441.90 07/22/20 \$988.00 07/27/20 \$215.84 08/01/20 \$853.70 08/02/20 \$98.35 08/12/20 \$250.00 08/12/20 \$107.82 08/14/20 \$89.94 08/25/20 \$100.00 08/26/20 \$250.00 08/28/20 \$100.00 09/01/20 \$129.61 09/04/20 \$129.61 09/04/20 \$72.47 09/07/20 \$993.10 09/14/20 \$242.32 09/29/20 \$170.37 09/30/20 \$170.37 09/30/20 \$108.05 10/07/20 \$140.20 10/21/20 \$83.28 10/25/20 \$250.00 10/25/20 \$250.00 10/25/20		\$124.78	07/06/20
\$988.00 07/27/20 \$215.84 08/01/20 \$853.70 08/02/20 \$98.35 08/12/20 \$250.00 08/12/20 \$107.82 08/14/20 \$89.94 08/25/20 \$100.00 08/26/20 \$250.00 08/28/20 \$100.00 09/01/20 \$129.61 09/04/20 \$129.61 09/04/20 \$72.47 09/07/20 \$993.10 09/14/20 \$242.32 09/29/20 \$170.37 09/30/20 \$170.37 09/30/20 \$108.05 10/07/20 \$140.20 10/21/20 \$83.28 10/25/20 \$250.00 10/25/20 \$250.00 10/25/20		\$250.00	07/09/20
\$215.84 08/01/20 \$853.70 08/02/20 \$98.35 08/12/20 \$250.00 08/12/20 \$107.82 08/14/20 \$89.94 08/25/20 \$100.00 08/26/20 \$250.00 08/28/20 \$100.00 09/01/20 \$129.61 09/04/20 \$72.47 09/07/20 \$993.10 09/14/20 \$242.32 09/29/20 \$170.37 09/30/20 \$108.05 10/07/20 \$140.20 10/21/20 \$83.28 10/25/20 \$250.00 10/25/20 \$217.60 10/28/20		\$1,441.90	07/22/20
\$853.70 08/02/20 \$98.35 08/12/20 \$250.00 08/12/20 \$107.82 08/14/20 \$89.94 08/25/20 \$100.00 08/26/20 \$250.00 08/28/20 \$100.00 09/01/20 \$129.61 09/04/20 \$72.47 09/07/20 \$993.10 09/14/20 \$242.32 09/29/20 \$170.37 09/30/20 \$170.37 09/30/20 \$140.20 10/21/20 \$83.28 10/25/20 \$250.00 10/25/20 \$217.60 10/28/20		\$988.00	07/27/20
\$98.35		\$215.84	08/01/20
\$250.00 08/12/20 \$107.82 08/14/20 \$89.94 08/25/20 \$100.00 08/26/20 \$250.00 08/28/20 \$100.00 09/01/20 \$129.61 09/04/20 \$72.47 09/07/20 \$993.10 09/14/20 \$242.32 09/29/20 \$170.37 09/30/20 \$108.05 10/07/20 \$140.20 10/21/20 \$83.28 10/25/20 \$250.00 10/25/20 \$217.60 10/28/20		\$853.70	08/02/20
\$107.82		\$98.35	08/12/20
\$89.94 08/25/20 \$100.00 08/26/20 \$250.00 08/28/20 \$100.00 09/01/20 \$129.61 09/04/20 \$72.47 09/07/20 \$993.10 09/14/20 \$242.32 09/29/20 \$170.37 09/30/20 \$108.05 10/07/20 \$140.20 10/21/20 \$83.28 10/25/20 \$250.00 10/25/20 \$217.60 10/28/20		\$250.00	08/12/20
\$100.00 08/26/20 \$250.00 08/28/20 \$100.00 09/01/20 \$129.61 09/04/20 \$72.47 09/07/20 \$993.10 09/14/20 \$242.32 09/29/20 \$170.37 09/30/20 \$108.05 10/07/20 \$140.20 10/21/20 \$83.28 10/25/20 \$250.00 10/25/20 \$217.60 10/28/20		\$107.82	08/14/20
\$250.00 08/28/20 \$100.00 09/01/20 \$129.61 09/04/20 \$72.47 09/07/20 \$993.10 09/14/20 \$242.32 09/29/20 \$170.37 09/30/20 \$108.05 10/07/20 \$140.20 10/21/20 \$83.28 10/25/20 \$250.00 10/25/20 \$217.60 10/28/20		\$89.94	08/25/20
\$100.00 09/01/20 \$129.61 09/04/20 \$72.47 09/07/20 \$993.10 09/14/20 \$242.32 09/29/20 \$170.37 09/30/20 \$108.05 10/07/20 \$140.20 10/21/20 \$83.28 10/25/20 \$250.00 10/25/20 \$217.60 10/28/20		\$100.00	08/26/20
\$129.61 09/04/20 \$72.47 09/07/20 \$993.10 09/14/20 \$242.32 09/29/20 \$170.37 09/30/20 \$108.05 10/07/20 \$140.20 10/21/20 \$83.28 10/25/20 \$250.00 10/25/20 \$217.60 10/28/20		\$250.00	08/28/20
\$72.47 09/07/20 \$993.10 09/14/20 \$242.32 09/29/20 \$170.37 09/30/20 \$108.05 10/07/20 \$140.20 10/21/20 \$83.28 10/25/20 \$250.00 10/25/20 \$217.60 10/28/20		\$100.00	09/01/20
\$993.10 09/14/20 \$242.32 09/29/20 \$170.37 09/30/20 \$108.05 10/07/20 \$140.20 10/21/20 \$83.28 10/25/20 \$250.00 10/25/20 \$217.60 10/28/20		\$129.61	09/04/20
\$242.32 09/29/20 \$170.37 09/30/20 \$108.05 10/07/20 \$140.20 10/21/20 \$83.28 10/25/20 \$250.00 10/25/20 \$217.60 10/28/20		\$72.47	09/07/20
\$170.37 09/30/20 \$108.05 10/07/20 \$140.20 10/21/20 \$83.28 10/25/20 \$250.00 10/25/20 \$217.60 10/28/20		\$993.10	09/14/20
\$108.05 10/07/20 \$140.20 10/21/20 \$83.28 10/25/20 \$250.00 10/25/20 \$217.60 10/28/20		\$242.32	09/29/20
\$140.20 10/21/20 \$83.28 10/25/20 \$250.00 10/25/20 \$217.60 10/28/20		\$170.37	09/30/20
\$83.28 10/25/20 \$250.00 10/25/20 \$217.60 10/28/20		\$108.05	10/07/20
\$250.00 10/25/20 \$217.60 10/28/20		\$140.20	10/21/20
\$217.60 10/28/20		\$83.28	10/25/20
		\$250.00	10/25/20
\$22.47 10/28/20		\$217.60	10/28/20
		\$22.47	10/28/20

TOWN OF NORTHFIELD AMBULANCE ABATEMENTS

Nama	m.i	Date of
Name	Balance	Service
	\$208.32	11/09/20
	\$977.80	11/10/20
	\$904.50	11/12/20
	\$894.50	11/24/20
	\$996.50	11/28/20
	\$123.62	11/29/2
	\$984.60	12/05/2
	\$1,013.00	12/11/2
	\$281.10	12/31/2
	\$1,062.30	01/06/2
	\$198.02	01/27/2
	\$232.58	01/29/2
	\$83.10	02/11/2
	\$199.54	02/19/2
	\$109.93	02/19/2
	\$942.10	02/23/2
	\$122.69	02/23/2
*	\$943.80	02/23/2
	\$83.10	03/05/2
	\$931.90	03/11/2
	\$83.10	03/15/2
	\$250.00	03/15/2
	\$906.12	03/18/2
	\$122.23	03/31/2
	\$250.00	04/04/2
	\$223.81	04/04/2
	\$250.00	04/21/2
	\$56.24	04/26/2
	\$122.46	04/27/2
	\$250.00	05/11/2:
	\$127.08	05/11/2:
	\$250.00	05/12/2:
	\$1,106.70	05/24/2:
	\$238.80	05/26/2:
	\$19.14	06/13/23
	\$250.00	06/14/2:
	\$100.00	06/27/21
	·	. ,

TOWN OF NORTHFIELD AMBULANCE ABATEMENTS

Name	Balance	Date of Service
	\$100.00	06/29/21
	\$989.00	07/05/21
	\$100.00	07/08/21
	\$42.34	07/28/21
	\$108.09	08/16/21
	\$108.55	08/20/21
	\$523.00	08/23/21
	\$1,048.70	08/23/21
	\$268.64	08/24/21
	\$899.93	08/29/21
	\$996.00	09/02/21
	\$239.58	09/05/21
	\$250.00	09/17/21
	\$272.82	09/19/21
	675.00	09/25/21
	\$1,725.90	10/04/21
	\$329.60	10/07/21
	\$92.10	10/10/21
	\$133.10	10/18/21
	\$932.90	10/31/23
	\$66.60	11/01/21
	\$183.10	11/06/23
	\$309.30	11/10/23
	\$229.00	11/11/22
	\$136.32	11/12/21
	\$1,112.60	11/24/21
	\$725.00	01/01/22
	\$189.85	01/08/22
	\$838.57	01/12/22
	\$129.94	01/17/22
	\$996.80	01/18/22
	\$1,137.80	01/18/22
	\$275.00	01/20/22
	\$280.00	01/29/22
	\$564.40	01/30/22
	\$986.00	02/08/22
	\$1,670.40	02/20/22

TOWN OF NORTHFIELD AMBULANCE ABATEMENTS

Nama	Dolones	Date of
Name	Balance	Service
	\$280.00	02/23/22
	\$2,105.00	02/23/22
	\$128.73	03/04/22
	\$50.85	03/08/22
	\$1,116.20	03/11/22
	\$113.62	03/16/22
%	\$1,112.60	03/17/22
	\$1,130.60	03/21/2
	\$169.04	03/22/2
	\$100.00	03/23/23
	\$43.96	03/24/2
	\$202.71	04/02/2
	\$118.28	04/06/2
	\$96.08	04/16/2
	\$130.43	04/16/2
	\$1,188.80	05/02/2
	\$100.00	05/06/2
	\$275.00	05/09/2
	\$1,280.60	05/12/2
	\$227.30	05/13/2
	1,165.40	05/16/2
	\$270.00	05/23/2
	\$1,088.60	06/08/2
	\$1,127.00	06/11/2
	\$129.94	06/16/2
	\$280.00	06/18/2
	\$115.56	07/16/2
	\$275.00	07/21/2
	\$275.00	07/22/2
	\$1,127.00	07/24/2
	\$1,170.80	07/26/2
	\$176.34	07/27/2
	\$143.15	07/29/2
	\$1,128.80	08/04/2
	\$275.00	08/12/2
	\$275.00	08/17/2
	\$998.60	08/20/22
	7,,,,,	30, 20, 21

TOWN OF NORTHFIELD AMBULANCE ABATEMENTS

ame	Balance	Date of Service
	\$150.00	08/24/2
	\$111.08	08/24/2
	\$567.82	08/27/2
	\$150.00	08/29/2
	\$359.09	08/23/2
	\$98.22	08/30/2
	\$98.40	08/31/2
	\$143.76	09/01/2
	\$989.40	09/09/2
	\$129.94	09/10/2
	\$294.08	09/13/2
	\$137.96	09/13/2
	\$95.90	09/16/2
	\$270.00	09/23/2
	\$50.36	09/30/2
	\$412.51	09/30/2
	\$45.99	09/30/2
	\$163.64	10/06/2
	\$250.00	10/10/2
	\$78.35	10/11/2
	\$566.20	10/12/2
	\$1,062.20	10/13/2
	\$100.00	10/16/2
	\$362.56	10/21/2
	\$1,020.00	11/06/2
	\$362.43	11/07/2
	\$250.00	11/11/2
	\$19.75	11/14/2
	\$275.00	11/24/2
	\$275.00	11/26/2
	\$230.00	11/30/2
	\$275.00	12/01/2
	\$1,313.00	12/01/2
	\$143.47	12/03/2
	\$280.00	12/03/2
	\$846.00	12/04/2
	\$300.00	12/17/2

TOWN OF NORTHFIELD AMBULANCE ABATEMENTS

		Date of
Name	Balance	Service
	\$79.80	12/19/22
	\$964.40	12/30/22
	\$1,180.40	01/09/23
	\$116.46	01/17/23
	\$1,132.40	01/20/23
	\$250.00	01/22/23
	\$787.07	01/25/23
	\$10.00	01/25/23
	\$119.02	01/25/23
	\$105.00	01/26/23
	\$250.00	02/14/23
	\$325.00	02/19/23
	\$1,194.20	03/16/23
	\$237.52	03/25/23
	\$250.00	03/26/23
	\$250.00	03/26/23
	\$150.00	03/27/23
	\$435.23	04/01/23
	\$71.13	04/15/23
	\$226.00	04/17/23
	\$1,057.20	04/21/23
	\$139.60	05/01/23
	\$150.00	05/04/23
	\$139.35	05/07/23
	\$300.00	05/16/23
	\$139.35	05/21/23
	\$588.08	05/21/23
	\$92.61	05/30/23
	\$424.60	06/05/23
	\$139.61	06/16/23
	\$250.00	06/20/23
	\$150.00	06/23/23
	\$150.00	07/01/23
	\$290.00	07/01/23
	\$1,287.60	07/03/23
	\$126.94	07/03/23
	\$122.98	07/04/23
	,	11, 41, 40

TOWN OF NORTHFIELD AMBULANCE ABATEMENTS

\$290.00 07/06/2 \$290.00 07/09/2 \$591.60 07/09/2 \$290.00 07/10/2 \$136.18 07/25/2 \$1,182.20 07/27/2 \$124.83 08/10/2 \$277.58 08/20/2 \$119.81 08/21/2 \$454.12 08/23/2 \$139.35 08/24/2 \$200.70 08/27/2 \$86.14 08/29/2 \$1,148.60 09/01/2 \$95.36 09/07/2 \$121.92 09/13/2 \$138.29 09/19/2 \$137.24 10/08/2 \$137.24 10/08/2 \$991.40 10/14/2 \$150.00 10/17/2 \$150.00 10/17/2 \$150.00 10/17/2 \$150.00 10/17/2 \$150.00 10/17/2 \$150.00 10/26/2 \$1,187.60 10/23/2 \$1,187.60 10/27/2 \$150.00 10/30/2 \$98.86 11/01/2 \$150.00 11/03/2 \$150.00 11/08/2 \$150.00 11/08/2 \$133.28 11/17/2 \$126.73 11/19/2 \$121.92 11/22/2 \$121.92 11/22/2 \$150.00 11/26/2	Name	Balance	Date of Service
\$290.00	vaine		
\$591.60			
\$290.00 07/10/2 \$136.18 07/25/2 \$1,182.20 07/27/2 \$124.83 08/10/2 \$277.58 08/20/2 \$119.81 08/21/2 \$454.12 08/23/2 \$139.35 08/24/2 \$200.70 08/27/2 \$86.14 08/29/2 \$1,148.60 09/01/2 \$95.36 09/07/2 \$121.92 09/13/2 \$138.29 09/19/2 \$137.24 10/08/2 \$137.24 10/08/2 \$150.00 10/17/2 \$150.00 10/17/2 \$150.00 10/17/2 \$150.00 10/17/2 \$150.00 10/17/2 \$150.00 10/17/2 \$150.00 10/26/2 \$1,187.60 10/26/2 \$1,187.60 10/26/2 \$1,187.60 10/27/2 \$150.00 11/03/2			
\$136.18			
\$1,182.20 07/27/2 \$124.83 08/10/2 \$277.58 08/20/2 \$119.81 08/21/2 \$454.12 08/23/2 \$139.35 08/24/2 \$200.70 08/27/2 \$86.14 08/29/2 \$1,148.60 09/01/2 \$95.36 09/07/2 \$121.92 09/13/2 \$138.29 09/19/2 \$137.24 10/08/2 \$991.40 10/14/2 \$150.00 10/17/2 \$150.00 10/17/2 \$150.00 10/17/2 \$150.00 10/17/2 \$150.00 10/17/2 \$150.00 10/17/2 \$150.00 10/26/2 \$1,187.60 10/23/2 \$1,187.60 10/27/2 \$150.00 10/30/2 \$1,187.60 10/27/2 \$150.00 11/03/2 \$150.00 11/08/2 \$1,187.60 10/27/2 \$150.00 11/08/2 \$1150.00 11/08/2 \$1150.00 11/08/2 \$133.28 11/17/2 \$126.73 11/19/2 \$123.51 11/21/2 \$121.92 11/22/2 \$150.00 11/26/2			07/10/23
\$124.83		\$136.18	07/25/2
\$277.58		\$1,182.20	07/27/2
\$119.81		\$124.83	08/10/2
\$454.12		\$277.58	08/20/2
\$139.35		\$119.81	08/21/2
\$200.70		\$454.12	08/23/2
\$86.14 08/29/2 \$1,148.60 09/01/2 \$95.36 09/07/2 \$121.92 09/13/2 \$138.29 09/19/2 \$137.24 10/08/2 \$991.40 10/14/2 \$150.00 10/17/2 \$150.00 10/17/2 \$150.00 10/17/2 \$150.00 10/19/2 \$141.20 10/23/2 \$141.20 10/23/2 \$150.00 10/26/2 \$1,187.60 10/27/2 \$150.00 10/30/2 \$150.00 10/30/2 \$150.00 10/30/2 \$150.00 11/08/2 \$110/2 \$150.00 11/08/2 \$150.00 11/08/2 \$150.00 11/08/2 \$150.00 11/08/2 \$150.00 11/08/2 \$150.00 11/08/2 \$150.00 11/08/2 \$150.00 11/08/2 \$150.00 11/08/2 \$133.28 11/17/2 \$126.73 11/19/2 \$121.92 11/22/2 \$150.00 11/26/2		\$139.35	08/24/2
\$1,148.60		\$200.70	08/27/2
\$95.36		\$86.14	08/29/2
\$121.92 09/13/2 \$138.29 09/19/2 \$137.24 10/08/2 \$991.40 10/14/2 \$150.00 10/17/2 \$150.00 10/17/2 \$150.00 10/17/2 \$736.69 10/19/2 \$141.20 10/23/2 \$150.00 10/26/2 \$1,187.60 10/27/2 \$150.00 10/30/2 \$150.00 10/30/2 \$150.00 11/03/2 \$150.00 11/03/2 \$150.00 11/03/2 \$150.00 11/03/2 \$150.00 11/03/2 \$150.00 11/03/2 \$150.00 11/08/2 \$150.00 11/08/2 \$150.00 11/08/2 \$150.00 11/08/2 \$150.00 11/08/2 \$125.48 11/13/2 \$133.28 11/17/2 \$126.73 11/19/2 \$121.92 11/22/2 \$150.00 11/26/2		\$1,148.60	09/01/2
\$138.29		\$95.36	09/07/2
\$137.24 10/08/2 \$991.40 10/14/2 \$150.00 10/17/2 \$150.00 10/17/2 \$150.00 10/17/2 \$150.00 10/19/2 \$736.69 10/19/2 \$141.20 10/23/2 \$150.00 10/26/2 \$1,187.60 10/27/2 \$150.00 10/30/2 \$150.00 10/30/2 \$150.00 11/03/2 \$150.00 11/08/2 \$150.00 11/08/2 \$150.00 11/08/2 \$150.00 11/08/2 \$150.00 11/108/2 \$150.00 11/108/2 \$150.00 11/108/2 \$1133.28 11/17/2 \$126.73 11/19/2 \$123.51 11/21/2 \$121.92 11/22/2 \$150.00 11/26/2		\$121.92	09/13/2
\$137.24 10/08/2 \$991.40 10/14/2 \$150.00 10/17/2 \$150.00 10/17/2 \$150.00 10/17/2 \$150.00 10/19/2 \$736.69 10/19/2 \$141.20 10/23/2 \$150.00 10/26/2 \$1,187.60 10/27/2 \$150.00 10/30/2 \$150.00 10/30/2 \$150.00 11/03/2 \$150.00 11/08/2 \$150.00 11/08/2 \$150.00 11/08/2 \$150.00 11/08/2 \$150.00 11/108/2 \$150.00 11/108/2 \$150.00 11/108/2 \$1133.28 11/17/2 \$126.73 11/19/2 \$123.51 11/21/2 \$121.92 11/22/2 \$150.00 11/26/2		\$138.29	09/19/2
\$150.00		\$137.24	10/08/2
\$150.00		\$991.40	10/14/2
\$150.00		\$150.00	
\$150.00		\$150.00	10/17/2
\$736.69		\$150.00	
\$150.00		\$736.69	10/19/2
\$150.00			
\$1,187.60		1	
\$150.00 10/30/2 \$98.86 11/01/2 \$150.00 11/03/2 \$150.00 11/08/2 125.48 11/13/2 \$133.28 11/17/2 \$126.73 11/19/2 \$123.51 11/21/2 \$121.92 11/22/2 \$150.00 11/26/2		·	
\$150.00 11/03/2 \$150.00 11/08/2 125.48 11/13/2 \$133.28 11/17/2 \$126.73 11/19/2 \$123.51 11/21/2 \$121.92 11/22/2 \$150.00 11/26/2			
\$150.00 11/03/2 \$150.00 11/08/2 125.48 11/13/2 \$133.28 11/17/2 \$126.73 11/19/2 \$123.51 11/21/2 \$121.92 11/22/2 \$150.00 11/26/2		\$98.86	11/01/2
\$150.00 11/08/2 125.48 11/13/2 \$133.28 11/17/2 \$126.73 11/19/2 \$123.51 11/21/2 \$121.92 11/22/2 \$150.00 11/26/2			· ·
125.48 11/13/2 \$133.28 11/17/2 \$126.73 11/19/2 \$123.51 11/21/2 \$121.92 11/22/2 \$150.00 11/26/2			
\$133.28 11/17/2 \$126.73 11/19/2 \$123.51 11/21/2 \$121.92 11/22/2 \$150.00 11/26/2			
\$126.73			
\$123.51 11/21/2 \$121.92 11/22/2 \$150.00 11/26/2			
\$121.92 11/22/2 \$150.00 11/26/2			
\$150.00 11/26/2			
		\$150.00	11/26/23

TOWN OF NORTHFIELD AMBULANCE ABATEMENTS

At collection over one year, deceased, or bankruptcy.

Name		Balance	Date of Service
		\$141.20	12/12/23
		\$139.61	12/27/23
		\$48.00	12/29/23
		\$129.05	12/29/23
		\$150.00	01/03/24
		\$150.00	01/17/24
		\$987.80	02/05/24
		\$150.00	02/09/24
	*	144.81	03/26/24
	*	137.16	06/11/24
	*	89.64	06/17/24
	*	84.31	06/30/24
	*	89.78	07/06/24
	*	88.49	11/29/24
	*	89.36	12/30/24
TOTAL ABATEMENTS		\$105,735.70	

^{*} Account included as patient is deceased and account is marked closed by the collection agency.

The Select Board hereby abates the above listed Ambulance Receivables in the amount of \$105,735.70. Dated this 12th day of August, 2025. Effective 06/30/25.

Select Board Chair	

Project Tracker

					Project List	8/8/2025	1
Project List	Status	Project Cost	Funding Source	Assigned	Start Date/Bid	Completion Date	Project Notes
Main St. Bridge Replacement Project	In Progress	\$8,900,000	State of VT, Municipality	VTrans and TM	11/1/2025	10/1/2026	VTrans has completed the final plans and will present to Board August 12. Project construction Spring 2026.
Main St. Water Line and Tank Project	Construction Phase	\$7,230,000	State of VT , Municipality	Engineer, TM	7/1/2024	11/15/2025	Water line contractor installing water lines. Site is ready for new tanks.
Route 12 and 12 A Sewer Expansion	Planning Phase	\$8,950,000	TBD	TM, Engineer	TBD	TBD	State approved 50% funding for study and plan update. Engineer working on update.
July Flooding, FEMA Disaster	In Progress	TBD	FEMA, State, Town	Town Staff	8/1/2023	TBD	The Town has received about 80% of the anticipated FEMA and State funding.
Cabot/Northfield Stormwater	In Progress	\$125,000	State of Vermont	TM, Consultant	10/1/2022	6/1/2026	Engineer completed plans. Engineer to bid the project.
Lovers Lane	Planning Phase	TBD	State of Vermont, Town	TM, HF, SB Comm.	7/25/2025	Fall 2025	Town received \$200,000 State grant. Awarded bid for project.
310 Water Street - FEMA Buyout	In Progress	\$285,000	FEMA, State Vermont	FEMA, State, TM	7/1/2022	TBD	FEMA and State of VT. have awarded full funding for buyout. Awarded bid for building demolition.
Wall St. Pedestrian - Design Phase	In Progress		State of Vermont	TM, Vtrans	01/1/2025	12/31/2027	Pedestrian Improvements on Wall Street to Dog River Park. Town awarded grant funds for design and construction. Project kick off meeting held 7/15/2025.
Cross Brothers Dam Project	In Progress	\$955,000	FEMA, State Vermont	VNRC, TM	10/1/2023	TBD	Engineer is preparing final plans and obtaining permits. Dam Removal scheduled for 2025.
491 Water Street - FEMA Buyout	In Progress	TBD	State of Vermont	TM,	5/1/2024	TBD	The property owner signed required documents. State processing the documents.
Historic Bridges	Scoping Phase	TBD	State of Vermont	State of Vermont	3/23/2023	TBD	The State selected four bridges in Northfield for structural analysis and rehab: Rabbit Hollow Bridge and three covered bridges on Cox Brook Road. Scoping for all bridges is underway.
Sewer Plant Permit Issues	Pending	TBD	Utility Commission	Town Manager	4/1/2023	TBD	Sewer Plant Permit Issues
Advanced Meter Infrastructure (AMI)	Planning Phase	\$950,000	State of VT and Utilities	TM, Utilities	9/1/2023	6/1/2026	Installing electric and water smart meters, Meter installation in late Summer 2025
King Street Battery Storage	Planning Phase	TBD	Developer	Developer, VPPSA	TBD	TBD	Developer needs to prepare and submit agreements to VPPSA and Town.
Riverwalk Path	Planning Phase	TBD	Town - ARPA	Committee	TBD	TBD	Dollar General donating land for path. Boundry survey completed. Deeds prepared.
Pool House Rebuild Plans	Planning Phase	\$36,000	Town- APRA	TM, SB Committee	03/1/2025	10/15/2025	Building evaulation and design plans. Architect working on project plans.
Dole Hill sump issues	Engineering Phase	TBD	Town	Engineer, TM	4/1/2024	TBD	Engineer working on engineering plan. Received preliminary engineering report.
Town Bridge 56, Highway 54	Planning Phase	\$200,000	Town	TM, Contractor	TBD	TBD	Town is adding funding to the CIP
Vine Street Pedestrain Bridge	Planning Phase	TBD	Town	TM, Contractor	TBD	TBD	Obtaining quotes
Vine and Cross Sidewalk Project	Construction Phase	\$400,000	ARPA Funds	TM, Engineer	6/15/2024	8/15/2025	Contractor has started the project. Estimated project completion date is August 15.
DEI Training	In Progress	No Cost	N/A	Board	4/26/2025	,	A representative of the VT office of Racial Equity Education attended 4/22 Select Board meeting







Vermont League of Cities and Towns

89 Main Street, Suite 4 Montpelier, VT 05602 PRSRT STD U.S. Postage PAID Burlington, VT Permit No. 253

Training tracks for:

- Clerks and Treasurers
- Listers and Assessors
- Highway and Road officials
- Town Managers and Administrators
- Selectboard/City Council Members

231 1

երիգրյակիիսենիսիներիիսիկինիներիներին - 🕾 -

Selectboard
Northfield Town
51 S Main St
Northfield VT 05663-6703

October 8

DoubleTree by Hilton South Burlington

REGISTRATION IS OPEN!



NextGen Vermont:Navigating 21st Century
Governance



October 8

DoubleTree by Hilton South Burlington

2025 Highlights include:

- Roundtable discussions with a full breakfast.
- A powerful **keynote by Tamuyfer** of The Dignity Index.
- Training tracks tailored to arr role and multiple discussionbased sessions to share your knowledge and learn from others.
- A bustling tradeshow, where you can explore tools, services, and solutions to support your community.
- Lunch and awards presentation, honoring outstanding public service with VLCT's Lifetime Achievement, Municipal Service, and Legislative Service Awards.
- An end-of-day ice cream social and raffle prize drawing.



Early bird pricing ends 8/30

VLCT.ORG/TF25



TOWN OF NORTHFIELD, VERMONT HIGHWAY PLANNING & PROJECT OVERSIGHT SUBCOMMITTEE Minutes of August 1 2025

I. ROLL CALL. Select Board members Charles Morse, Merry Shernock, and John Stevens. Also present were Town Manager Jeff Schulz, Karl Bailey (Highway Foreman), Miles Jenness (Vermont Heavy Timber), Dennis Donahue, Kristy Kenyon, Stephen Korrow, Austin Nava, and David Tomczyk.

The meeting started at 8:05 a.m.

II. PUBLIC PARTICIPATION (Scheduled): None.

III. DISCUSSION

- a. Highway Projects.
 - Slaughterhouse Road Covered Bridge. Manager Schulz said he contacted Daniels Construction in April 2025 in order to obtain cost estimates for needed repairs to all the covered bridges. provide some recommendations and cost estimates. More recently, he was meeting with Miles Jenness from Vermont Heavy Timber regarding another project and asked him to take a look at the Slaughterhouse Road Covered Bridge. At that time, Mr. Jenness found that the bridge had significant structural problems and recommended that its maximum weight limit be reduced from 16,000 lbs, to 6,000 lbs. Manager Schulz contacted the Vermont Agency of Transportation (VTrans), which quickly dispatched bridge inspectors who agreed with this recommendation. Manager Schulz then reviewed the Town Highway budget and found there were sufficient funds to address this matter on an emergency basis. Board member Morse agrees that this is an emergency situation that requires waiving certain provisions of the municipal purchasing policy, i.e. sealed bids, etc. Mr. Jenness said there is water now running across the bridge that is further undermining its structural stability. His plan is to install temporary steel beams into the river bedrock, which would immediately return the bridge's maximum weight limit to 16,000 lbs. This emergency work would be done right after a work contract has been signed. Later this autumn, longer term repairs would be done in replacing the current rotting wooden beam supports and the steel beams would be removed. Mr. Jenness estimated the total cost of this project at \$142,000. Board member Morse said the bridge's restored 16,000 lbs. weight limit could be further increased at a later time with additional measures but that would be a discussion for another time. He added that we now have about ten (10) days of dry weather so the emergency work should be done as soon as possible. Board member Morse then noted that Board member Stevens has suggested using a used conveyor belt to prevent more water from crossing the bridge. There are other possible options. Manager Schulz said there might be some funds available from the VTrans historic structures preservation program for a project of this nature. He has already made contact about this possibility. Dennis Donahue felt that even with the improved structural stability, the covered bridge entrances are still too low and narrow for complete access for emergency vehicles, etc. He would be reluctant to put too much money into expensive repairs. Steve Korrow agrees with this, stating that a new road from Aseltine Road and Dukette Road could be built to service the area west of the bridge.

Mr. Korrow believes this covered bridge was constructed to service a slaughterhouse and small farms and was neither designed nor intended to bear heavy loads. Mr. Donahue said another possible route for a new access road could be built on his parents' property with egress at Horse Lane. Kristy Kenyon believes the current Slaughterhouse Road Covered Bridge is a community asset that draws a lot of visitors to Northfield, especially during foliage season. She suggested that the current bridge could be preserved for historic purposes while a new, modern bridge could be built nearby that could accommodate heavy traffic loads. Manager Schulz said such a replacement bridge would have to be fully engineered and this process would take a several years. He felt the best immediate solution was to provide the emergency repairs Mr. Jenness has recommended. Board member Morse doesn't see any alternative to spending money on this bridge both in the short- and long-term. The residents who need this bridge to access their homes require immediate relief. Board member Stevens agrees with this necessity. Manager Schulz then noted that under the purchasing policy, the Town Manager does have the authority to authorize spending funds for emergency bridge repairs. Board member Morse felt this action does have broad support. Motion by Board member Stevens, seconded by Board member Shernock, to authorize Manager Schulz to reach an agreement with Vermont Heavy Lumber to perform emergency stabilization work on the Slaughterhouse Road Covered Bridge at an estimated cost of \$142,000.

Motion passed 3-0-0.

Mr. Jenness again indicated that the work on the bridge would start as soon as the project contract has been drafted and signed. Board member Morse believes that Mr. Jenness would be in a better position to make further recommendations for long-term repairs to the bridge once he has started on the emergency repairs and discovered all of the bridge's deficiencies. This could include raising the bridge's weight limit above 16,000 lbs. and making other upgrades that would allow for passage by emergency vehicles, delivery trucks, etc. Board member Morse said the Select Board would need to start budgeting over the next few years for these additional improvements. In the interim, making the recommended emergency repairs to this bridge is based on an important public safety concern and he hopes the work contract can be executed as soon as possible. Board member Morse also felt the municipality needs to do a better job in future in providing regular maintenance to all of its public bridges.

- IV. PUBLIC PARTICIPATION (Unscheduled). There was none.
- V. **ADJOURNMENT.** Without objection, the meeting ended at 8:53 a.m.

Respectfully submitted,

Kenneth L. McCann

Kenneth L. McCann, Acting Clerk

A video recording of this meeting is available at: https://youtu.be/8n1C_y5Cr]4

INFORMATION ONLY

From:

Mary Richter <secretgardenborzois@gmail.com>

Sent:

Friday, July 11, 2025 10:45 AM

To:

Charlie Morse

Cc:

Jeff Schulz; Douglas Reed

Subject:

Re: ~ USPS Miss-Delivers Utility Shut Off Notice ~

Yes. Main St., Northfield Post Office.

My long standing problem with them is that they deliver someone else's mail. It's not everyday by any means, but way too often.

Most recently it was the neighbor's shut off notice from the town, and just before that their most recent Trans-Video bill came here which Mark walked over to them.

When I discover someone else's shut off notice among my mail that obligates me to do something to make sure it doesn't happen again. At least that's how I feel about it. I'd be livid if my shut off notice was delivered to my neighbor.

This isn't a lack of personnel issue. This is a SLOPPY and CARELESS personnel issue.

- Mary -

On Wed, Jul 9, 2025, 17:58 Charlie Morse < cmorse@northfield.vt.us > wrote:

Doug, did you route this to Jeff?

Charlie

From: Mary Richter < secretgardenborzois@gmail.com>

Sent: Tuesday, July 8, 2025 2:53 PM

To: Jeff Schulz < jschulz@northfield.vt.us>; Charlie Morse < cmorse@northfield.vt.us>; Douglas Reed

<dreed@northfield.vt.us>; Mary Richter <secretgardenborzois@gmail.com>

Subject: ~ USPS Miss-Delivers Utility Shut Off Notice ~

Hi Jeff, Hi Charlie, Hi Doug,

I realize that you don't control the USPS but you should be aware that they can carelessly miss-deliver something as important as a utility shut office notice.

I turned my next door neighbor's (DeLary) utility shut off notice into the Electric Department yesterday so that they would know that it was delivered here by mistake in case that buys the consumer a bit of grace.

Unfortunately, I could have had it for up to two weeks because, other than personal letters or something important that I am watching for, I only open my mail every two weeks, or so.

This particular piece of DeLary's mail was discovered the night before

when I ripped it open only to find that the numbers didn't look right. That's when I spotted their name.

We've gotten a lot of this same neighbor's mail over the years, and Mark has walked it all over to their house. We're so tired of it that I brought it to the attention of the PO window clerk a few months ago telling him that this has to stop.

That clerk looked a white haired 70 year old lady in the eye and told me that I could just walk it over to them when I get their mail.

Big mistake.

"I don't get paid to deliver the mail. But you do! I'm 70 years old and Mark is 75. Neither one of us walks great. Plus, we don't get along with those people ever since Joel was really ugly because he couldn't get his way about a fence that we built. Next, they had multiple children incarcerated in federal penitentiaries for arson and drugs. We'd rather not have anything to do with them and you're not going to force us together!"

Things were better. Briefly.

I don't understand. This isn't rocket science. Sorting mail and putting it in the right box seems like something that any 12 year old kid could be trained to do in ten minutes, and they'd do it perfectly each and every time.

Trying to have a conversation about it with the local postal clerk has proven to be an utter waste of time. They run a sloppy ship and there's nothing that I can say to them that will make them straighten out what should be a simple thing.

But I did find a https://urldefense.proofpoint.com/v2/url?u=http-

3A usa.gov&d=DwlCaQ&c=euGZstcaTDllvimEN8b7jXrwqOf-

v5A CdpgnVfiiMM&r=QWTr2paJZ8C4iq61ViaMM1DtQY6Ay1p5rpam66WUH5E&m=-

Rqn4AEIONVtKU8DqiWtoKeAiYwHlbDJIT2GPnRAq8BPHRDehzD8yugniOaTlykf&s=Dk5RmqUThQFYa9poqIID7jsaQgbxOE

4QfOisanTyh4o&e= link to register formal postal complaints.

Perhaps taking a little heat from on high will remind them what a normal level of service is. If/When you reach a similar level of frustration with the service provided by our Northfield Post Office perhaps you will consider filing your own formal complaint.

https://urldefense.proofpoint.com/v2/url?u=https-3A www.usa.gov postal-2Dservice-

2Dcomplaints&d=DwICaQ&c=euGZstcaTDllvimEN8b7jXrwqOf-

v5A CdpgnVfiiMM&r=QWTr2paJZ8C4iq61ViaMM1DtQY6Ay1p5rpam66WUH5E&m=-

Rqn4AElONVtKU8DqiWtoKeAiYwHlbDJlT2GPnRAq8BPHRDehzD8yugniOaTlykf&s=JNEyaUcgypzA2mEqlHdko8ZUBIYq 6
NccztLWN5jOMA&e=

Thanks for your time,

Mary Richter

INFORMATION ONLY

From: SOV - Ethics Commission <SOV.EthicsCommission@vermont.gov>

Sent: Thursday, August 7, 2025 3:50 PM

To: Delaney, Peggy
Cc: Sivret, Christina

Subject: Municipal Ethics Information Session

As many of you have probably heard, the State Ethics Commission has had to suspend most municipal services due to lack of staffing.

As we chart a path forward, we would like to hear from you on how the Ethics Commission can best serve municipalities at our current resource levels. We will hold a Zoom session on August 14th from 2:30-3:30 p.m. to hear feedback and answer questions. We will hold a second Zoom session September (date TBD) for anyone who cannot make the first session.

We hope to see you there!

Topic: Municipal Ethics Informational Session

Time: Aug 14, 2025, 02:30 PM Eastern Time (US and Canada)

Join Zoom Meeting

https://us02web.zoom.us/j/83114802741?pwd=aRkrlAbXWRWbWP7QpuKQAg8kyJwxaE.1

Meeting ID: 831 1480 2741

Passcode: 456426

Peggy Delaney Administrative Assistant Vermont State Ethics Commission https://ethicscommission.vermont.gov