MUNICIPAL OFFICES



Town of Northfield, Vermont www.northfield-vt.gov

Phone Fax

1-802-485-6121 1-802-485-8426

51 SOUTH MAIN STREET NORTHFIELD, VERMONT 05663

TOWN OF NORTHFIELD, VERMONT SELECT BOARD REGULAR MEETING Tuesday, August 12, 2025 COMMUNITY ROOM - 7:00 P.M.

This ZOOM meeting can be attended either in person or from your computer, tablet, or smartphone.

https://us06web.zoom.us/j/84183919223?pwd=MFTUidfSNRbVy1acDAoa2fq4ccdMZY.1

You can also dial in using your phone: 1-929-436-2866 Meeting ID: 841 8391 9223 Passcode: 942574

AGENDA

- I. ROLL CALL
- II. SET/ADJUST AGENDA
- III. PUBLIC PARTICIPATION (SCHEDULED):
 - a. Gary Laroche P.E., VTrans Project Manager: Main Street Bridge Replacement Project Update
- IV. APPROVAL OF MINUTES
 - a. July 22, 2025 (Regular Meeting)
- V. APPROVAL OF BILLS
 - a. Approval of Warrant #03-26 & #03-26A-F
 - Receipt of Biweekly Payroll through July 20, 2025: \$120,488.22
 - c. Receipt of Biweekly Payroll through August 3, 2025: \$115,088.87

VI. SELECT BOARD

- a. Cheney Farm Post-Construction Parking and Accessibility
- b. CVRPC Public Works Emergency Mutual Aid Agreement
- c. Northfield Ambulance Abatements
- d. Slaughterhouse Road Drainage
- e. Community Communication Policy
- f. Budget Priorities
- VII. TOWN MANAGER'S REPORT
- VIII. BOARD MEMBERS' COMMENTS, CONCERNS, QUESTIONS
- IX. PUBLIC PARTICIPATION (UNSCHEDULED)
- X. EXECUTIVE SESSION (IF NEEDED)
 - a. Legal/Personnel/Contracts [1 VSA 313 (a)(1)]
- XI. ADJOURNMENT



PROPOSED IMPROVEMENT **BRIDGE PROJECT** TOWN OF NORTHFIELD **COUNTY OF WASHINGTON**


ROUTE NO: VT ROUTE 12, TH-1 MAIN ST. (CLASS 1), MAJOR COLLECTOR, BRIDGE NO: 60

PROJECT LOCATION:

LOCATED IN THE TOWN OF NORTHFIELD ON VT ROUTE 12, BRIDGE 60 OVER DOG RIVER, APPROXIMATELY 1.1 MILES NORTH OF THE JUNCTION WITH VT ROUTE 12A SOUTH.

PROJECT DESCRIPTION: REMOVAL AND REPLACEMENT OF BRIDGE NO, 60 WITH RELATED APPROACH ROADWAY AND CHANNEL WORK.

LENGTH OF STRUCTURE: 141.66 FEET LENGTH OF ROADWAY: 133.34 FEET LENGTH OF PROJECT: 275.00 FEET

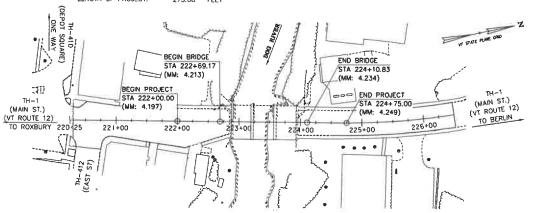

CONSTRUCTION IS TO BE CARRIED ON IN ACCORDANCE WITH THESE PLANS AND THE STANDARD SPECIFICATIONS FOR CONSTRUCTION DATED 2024, AS APPROVED BY THE FEDERAL HIGHWAY ADMINISTRATION ON JUNE 27, 2023 FOR USE ON THIS PROJECT, INCLUDING ALL SUBSEQUENT REVISIONS AND SUCH REVISED SPECIFICATIONS AND SPECIAL PROVISIONS AS ARE INCORPORATED IN THESE

QUALITY ASSURANCE PROGRAM: LEVEL SURVEYED BY : DUBOIS & KING SURVEYED DATE : 2019

VERTICAL HORIZONTAL

DATUM

NAVD88 NAD 83 (2011)

LOCATION MAP NOT TO SCALE

> HIGHWAY DIVISION, CHIEF ENGINEER PROJECT MANAGER: GARY LAROCHE, P.E. PROJECT NUMBER : BF 0241(58)

CANADA

MASSACHUSETTS

State of NEW HAMPSHIRE


State of NEW YORK


NORTHFIELD BF 0241(58)

PRELIMINARY INFORMATION SHEET (BRIDGE)


LRFD

		MUEX OF SHEETS			FINAL HYDR	AULIC REPORT
	PLAN SHEETS		STANDARDS LIST			
	1 TITLE SHEET	C-2A	PORTLAND CEMENT CONCRETE SIDEWALK DRIVE ENTRANCES	10-14-2005	HYDROLOGIC DATA Date: 4/20/2022	PROPOSED STRUCTURE
	2 PRELIMINARY INFORMATION SHEET 3 TYPICAL SECTIONS SHEET	C-3B C-10	SIDEWALK RAMPS AND MEDIAN ISLANDS	02-17-2022	DRANAGE AREA: 59,8 tq. ml.	STRUCTURE TYPE: Slingle Spain
	# EARTHWORK TYPICAL SECTION	E-10	CURBING ROLLED EROSION CONTROL PRODUCT, TYPE I	02-17-2022 04-07-2020	CHARACTER OF TERRAN: Hilly to mountainous rural watershed STREAM CHARACTERISTICS: Sinuous with wide fived plain	1-2-1
	5 GENERAL NOTES SHEET	E-12	STABILIZED CONSTRUCTION ENTRANCE	04-07-2020	NATURE OF STREAMBED; Cobbie	CLEAR SPAN(NORMAL TO STREAM): 137.0 ft. VERTICAL CLEARANCE ABOVE STREAMBED: 18.1 ft.
	6 - 8 QUANTITY SHEET 1 - 3 9 EARTHWORK SHEET	E-13 E-15	NLET PROTECTION DEVICE, TYPE 1 SILT FENCE	04-07-2020		WATERWAY OF FULL OPENING: 1,364.0 sq. ft.
	10 CONVENTIONAL SYMBOLOGY LEGEND	E-13	SILT PENCE: STANDARD SIGN PLACEMENT - CONVENTIONAL ROAD	04-07-2020 08-08-1895	PEAK FLOWDATA - ANNUAL EXCEEDANCE PROBABILITY (AEP)	WATER SURFACE ELEVATIONS AT:
	11 SURVEY THE SHEET 12 LAYOUT SHEET	E-1318	BICYCLE GUIDE SIGN DETAILS	07-25-2024	43% = 2,200 cfs 2% = 6,000 cfs	WATER SURFACE ELEVATIONS AT:
	12 LAYOUT SHEET 13 PROFILE AND BANKING DIAGRAM	G-1 G-1D	STEEL BEAM GUARDRAIL DETAILS (POST, DELINEATOR, TYPICALS)	03-10-2017	10% = 3,800 cts 1% = 7,100 cfs	43% AEP = 713.4 ft. VELOCITY= 7.5 fps
	14 SIDEWALK LAYOUT SHEET	G-19	STEEL BEAM GUARDRAIL DETAILS (END TERMINAL, ANCHOR, MEDI/ GENERIC GRADING PLANS FOR GUARDRAIL END TERMINALS	03-10-2017 10-02-2018	4% = 5,000 cfs 0.2% = 8,300 cfs	10% AEP = 714.7 ft. 9.1 fps 4% AEP = 715.7 ft. 9.0 fps
	15 TRUCK DETOUR ROUTE 16 LOCAL DETOUR ROUTE	8-400	BRIDGE JOINT ASPHALTIC PLUG	04-07-2020	DATE OF FLOOD OF RECORD : 8/28/2011	4% AEP = 715.7 ft. 9.9 fps 2% AEP = 716.5 ft. 9.9 fps
	17 TRAFFIC CONTROL NOTES	S-500 S-501	CONCRETE DETAILS AND NOTES CONCRETE DETAILS AND NOTES	02-15-2023	ESTIMATED DISCHARGE: Unknown	1% AEP = 717.2 ft. 11.1 fps
	18 LOCAL PEDESTRIAN DETOUR	S-800	STRUCTURAL DETAILS AND NOTES	02-15-2023	WATER SURFACE ELEV.: 721.7 ft. NATURAL STREAM VELOCITY: 2% AEF = 10.1 ps*	IS THE ROADWAY OVERTOPPED BELOW 1% AEP: No
	19 - 27 LOCAL PEDESTRIAN DETOUR SHEET 1 - 9 28 DRAINAGE LAYOUT SHEET	S-801	STRUCTURAL STEEL PLATE GROER DETAILS AND NOTES	02-15-2023	ICE CONDITIONS: Moderate	FREQUENCY: N/A
	29 ORAINAGE PROFILE	T-1 T-2	TRAFFIC CONTROL GENERAL NOTES TRAFFIC SIGN GENERAL NOTES	04-25-2018 04-07-2020	DEBRIS: Moderate to Heavy	RELIEF ELEVATION: N/A
	30 DRAINAGE DETAILS	T-10	CONVENTIONAL ROADS CONSTRUCTION APPROACH SIGNING	08-08-2012	DOES THE STREAM REACH MAXIMUM HIGHWATER ELEV, RAPIDLY? Unknown IS ORD INARY RISE RAPID? Unknown	DISCHARGE OVER ROAD @ 1% AEP: N/A
	31 DRAINAGE TABLES 32 UTILITY LAYOUT SHEET	T-42	BRIDGE NUMBER PLAQUE	04-09-2014	IS STAGE AFFECTED BY UPSTREAM OR DOWNSTREAM CONDITIONS? Yes	BRIDGE LOW CHORD ELEVATION: 723.08 ft.
	33-35 LITLITY DUCT BANK PLAN AND PROFILE, 1, 3				IF YES, DESCRIBE: The stage is controlled by an uncontrolled darm directly	FREEBOARD: @ 2% AEP = 06.57 ft.
	38 UTILITY DUCT BANK SECTIONS				downstream of the structure	SCOUR: 7.0 ft.**
	37 - 38 LIGHTING PLAN SHEETS 1 - 2 39 SIGN AND LINE LAYOUT SHEET				WATERSHED STORAGE: 1.0% HEADWATERS:	
	40 CROSSWALK DETAILS				UNFORM: X MMEDIATELYABOVE SITE:	REQUIRED CHANNEL PROTECTION: Stone Fill Type IV***
	41 SIGN AND LINE TABLE SHEET					PERMIT INFORMATION
	42 RAIL LAOUT SHEET 43 TEMPORARY PARKING LAYOUT				EXISTING STRUCTURE INFORMATION	
	44 BORING LAYOUT SHEET				STRUCTURE TYPE: 3-Span Concrete T-Beam Bridge	AVERAGE DAILYFLOW: - CEPTH OR ELEVATION: -
	45 - 50 BORING LOG SHEET 1 - 6 51 BRIDGE DECK PLAN				YEAR BUILT: 1926, Reconstructed in 1958	ORDINARY LOW WATER:
	52 BRIDGE DECK PLAN 52 BRIDGE DECK REINFORCING SECTION				CLEAR SPAN(NORMAL TO STREAM): 105,0 ft.	
	53 BRIDGE DECK DETAILS				VERTICAL CLEARANCE ABOVE STREAMBED: 20.3 R. WATERWAY OF FULL OPENING: 1.661,2 m., R.	TEMPORARY BRIDGE REQUIREMENTS
	54 FRAMING PLAN				DISPOSITION OF STRUCTURE: Full Revisionment	STRUCTURE TYPE: N/A
	55 GRDER DETAILS 56 CAMBER TABLE				TYPE OF MATERIAL UNDER SUBSTRUCTURE: See Borings	CLEAR SPAN (NORMAL TO STREAM): N/A
	57 APPROACH SLAB DETAILS SHEET				WATER SURFACE ELEVATIONS AT:	VERTICAL CLEARANCE ABOVE STREAMBED: N/A WATERWAY AREA OF FULL OPENING: N/A
	58 ABUTMENT 1 PLAN SHEET 59 ABUTMENT PILE DETAIL SHEET					
	80 WINGWALL PILE DETAIL SHEET				43% AEP = 713.6 ft. VELOCITY = 6.9 fps 10% AEP = 715.1 ft. VELOCITY = 8.4 fps	ADDITIONAL INFORMATION
	81 ABUTMENT CONNECTION DETAIL 82 ABUTMENT 1 REINFORCEMENT				4% AEP = 716.1 R. 9.4 fbs	* Natural velocity is slightly larger because deceleration occurs near bridge opening
	63 WINGWALL 2 DETAILS				2% AEP = 717.0 ft. 9.8 fps	** Assumes that existing abulments are they exposed and scours similar to pier at abulments
	64 ABUTMENT 2 PLAN SHEET				1% AEP = 717.7 ft. 10.2 fps	***E-Stone Type M is to be used for all in channel work
	68 ABUTMENT 2 REINFORCEMENT				LONG TERM STREAMBED CHANGES: Unknown	TRAFFIC MAINTENANCE NOTES
	66 WINGWALL 3 DETAILS 67-70 SOLDIER PILE WALL DETAILS 1-4					MAINTAIN TRAFFIC ON AN OFF SITE DETOUR.
	71 WINGWALLS 1 AND 4				IS THE ROADWAY OVERTOPPED BELOW 1% AEP: No	TRAFFIC SIGNALS ARE NOT NECESSARY. SIDEWALKS ARE NECESSARY.
	72-74 BRIDGE RAILING DETAILS SHEET 1 - 3				FREQUENCY: N/A	4. BICYCLES AND PEDESTRIANS WILL BE ACCOMMODATED
	75 MOMENT SLAB DETAILS SHEET 76 REINFORCING STEEL SCHEDULE				RELIEF ELEVATION: N/A	
	77-83 ROADWAY CROSS SECTIONS SHEET 1 - 7				DISCHARGE OVER ROAD @ 1% AEP: N/A	1. DESIGN VALUES HL-93
	84 MATERIAL TRANSITION DIAGRAM 85-94 CHANNEL CROSS SECTIONS SHEET 1 - 10				UPSTREAM STRUCTURE	
	95-96 EPSC NARRATIVE SHEET 1 - 2					2. FUTURE PAVEMENT dp: 2.5 INCH 3. DESIGN SPAN L: 140 FT
	97 EPSC EXISTING SITE PLAN				TOWN: Nortifield DISTANCE: 350.0 ft HIGHWAY#: NE Central Faultoad Routoury STRUCTURE #: Unknown	4. MIN. MID-SPAN POS. CAMBER & RELEASE (PRESTRESSED UNITS) 4:
	98 EPSC CONSTRUCTION SITE PLAN 99 EPSC FINAL SITE PLAN				CLEAR SPAN; Unknown CLEAR HEIGHT: Unknown	5. PRESTRESSING STRAND 6. PRESTRESSED CONCRETE STRENGTH 7 c:
	100 - 101 EPSC DETAILS - 1 - 2				YEAR BUILT: Unknown FULL WATERWAY: Unknown STRUCTURE TYPE: Simple Span	
	102 LANDSCAPE PLAN				STRUCTURE TYPE: Simple Span	7. PRESTRESSED CONCRETE RELEASE STRENGTH f'el: 8. S.P. (PERFORMANCE-BASED CONCRETE, CLASS PCD) f'e: 4.0 KSI
	DETAIL SHEETS				DOWNSTREAM STRUCTURE	9. S.P. (PERFORMANCE-BASED CONCRETE, CLASS PCS) f'c; 3.5 KSI
	DETAIL SHEETS				TOWN: Northfield DISTANCE: 1.1 ml.	10. S.P. (PERFORMANCE-BASED CONCRETE, CLASS PSS) f'e: 4.0 KSI 11. CONCRETE, CLASS C f'e: 3.0 KSI
					HIGHWAY#: VT-12 STRUCTURE#: BR 61	12. REINFORCING STEEL 6: 60 KSI
					CLEAR SPAN: 170. ft. CLEAR HEIGHT: Unknown	13. STRUCTURAL STEEL AASHTO M270, GR50W fy: 50 KSI
					YEAR BUILT: 1977 FULL WATERWAY: Unknown STRUCTURE TYPE: 2 9pm Continuous Rolled Bearn	14. NOMINAL BEARING RESISTANCE OF SOIL gn:
					The state of the s	15. SOIL BEARING RESISTANCE FACTOR (REFER TO AASHTO LIFED) 6:
					LRFD LOAD RATING FACTORS	18. NOMINAL BEARING RESISTANCE OF ROCK 4/1: 17. ROCK BEARING RESISTANCE FACTOR (REFER TO AASHTO LIFE) 4:
					TRUCK	
					11 10 10 10 10 10 10 10 10 10 10 10 10 1	
					TORNAGE 20 38 36 66 30 34.6 38 INVENTORY 1,14	19. LATERAL PILE DEFLECTION Δ 20. BASIC WIND SPEED V39:
					POSTING 1,14	21. MINIMUM GROUND SNOWLOAD Pg:
					OPERATING 1.48 2.12 281 4.41 3.89 3.83	22, SEISMIC DATA PGA: \$a:
					COMMENTS:	23.
						24.
						25
					į į	
					ļ, l	PROJECT NAME: NORTHFIELD
		TRAFFIC DATA		AS BUILT "REBAR"		PROJECT NUMBER: BF 024I(58)
_				LEVEL LEVEL LEVEL	4.4	
Y	TEAR ADT DHV %D %T A	DDT 20 year ESAL for flexible pavement from	m 2024 to 2044 : 571480	TYPE: TYPE: TYPE:		FILE NAME: zi9]223forms.dgn PLOT DATE: 5/29/2025
	2024 4300 530 52 5.5 2	80 40 year ESAL for flexible pavement from		GRADE: GRADE: GRADE:		PROJECT LEADER: K. SMITH DRAWN BY: D. WELLS DESIGNED BY: D. WELLS CHECKED BY: K. SMITH
- 7		70 Design Speed: 30 mph			' ' ' ' ' ' ' ' ' ' ' ' ' ' ' ' ' ' '	DESIGNED BY: D. WELLS CHECKED BY: K. SMITH PRELIMINARY INFORMATION SHEET SHEET 2 OF 102
	7					COMMUNICATION OF STREET OF INC.

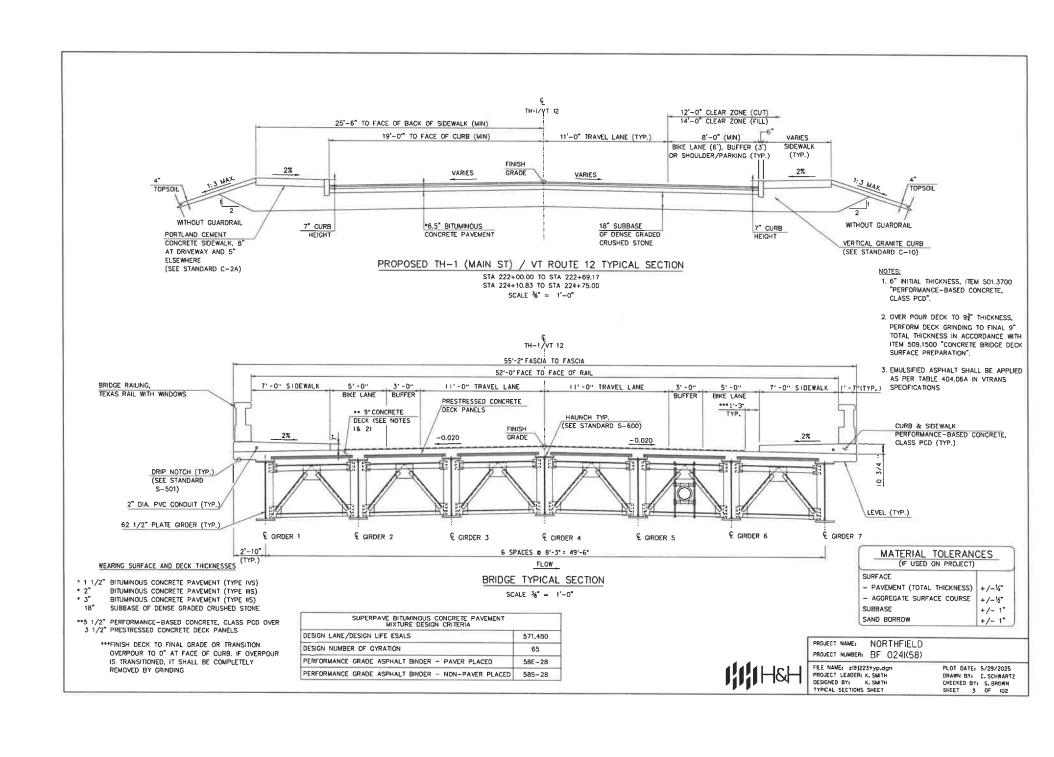

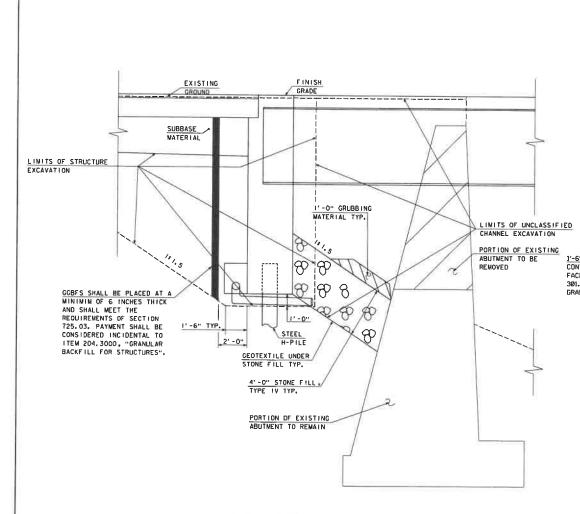


ABUTMENT EARTHWORK TYPICAL SECTION

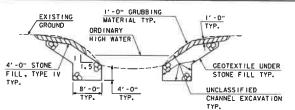

TYPICAL CHANNEL SECTION (NOT TO SCALE)

- 1) GRUBBING MATERIAL SHALL BE PLACED UNDERNEATH STRUCTURES WHERE THERE IS MORE THAN 6 FEET VERTICALLY FROM ORDINARY HIGH WATER (OHW) TO THE BOTTOM OF SUPERSTRUCTURE AND MORE THAN 6 FEET HORIZONTALLY FROM OHW LINE TO FRONT FACE OF ABUTMENT. THIS MATERIAL SHALL START JUST ABOVE THE OHW ELEVATION AND TERMINATE 3 FEET HORIZONTALLY FROM THE FRONT FACE OF THE ABUTMENT. THIS MATERIAL SHALL NOT BE PLACED UNDERNEATH DOWNSPOUTS. SEE THE CHANNEL SECTIONS FOR ADDITIONAL DETAILING.
- 2) WHENEVER CHANNEL SLOPE INTERSECTS ROADWAY SUBBASE, GRUBBING MATERIAL SHALL BEGIN AT THE BOTTOM OF SUBBASE.

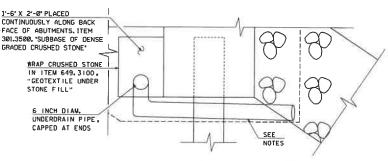

SUBSTRUCTURE DRAINAGE DETAIL

- 3) 6" UNDERDRAIN OUTLET PIPE CONNECTED TO UNDERDRAIN AT BACK FACE OF ABUTWENTS. OUTLET PIPE TO BE WRAPPED IN ITEM 649.3100, "GEOTEXTILE UNDER STONE FILL" AND PLACED TO AVOID PILES AND CUSHION SAND.
- 4) SLOPE UNDERDRAIN PIPE AT A MINIMUM OF 1/8" PER FOOT.
- 5) UNDERDRAIN OUTLET PIPE TO TERMINATE A MINIMUM OF 6"
 BEYOND GRANULAR BACKFILL FOR STRUCTURES. ENDS OF UNDERDRAIN
 OUTLET PIPE WILL BE PROTECTED FROM DAMAGE DURING PLACEMENT
 OF STOME FILL TYPE IV. ANY DAMAGED SECTIONS OF PIPE SHALL
 BE REPLACED TO THE SATIFACTION OF THE ENGINEER AND AT THE
 CONTRACTORS EXPENSE.
- 6) PAYMENT FOR ALL UNDERDRAIN PIPES SHALL BE UNDER ITEM 605. 1006, "UNDERDRAIN PIPE, 6 INCH".



PROJECT NAME: NORTHFIELD PROJECT NUMBER: BF 024I(58)

FILE NAME: ZI9]223e+s.dgn PROJECT LEADER: K. SMITH DESIGNED BY: K. HO EARTHWORK TYPICAL SECTION PLOT DATE: 5/29/2025 DRAWN BY: T. MARQUETTE CHECKED BY: C. JENNE SHEET 4 OF 102

GENERAL

- ALL MATERIALS AND CONSTRUCTION SHALL CONFORM TO THE STATE OF VERMONT ACENCY OF TRANSPORTATION STANDARD SPECIFICATIONS FOR CONSTRUCTION 2024, AND ITS LATEST REVISIONS, AND THE AASHTO LRFD BRIDGE DESIGN SPECIFICATIONS, DATED 2020.
- ALL DIMENSIONS SHOWN IN THE PLANS ARE HORIZONTAL OR VERTICAL AND ARE GIVEN AT 68 DEGREES FAHRENHEIT, UNLESS NOTED OTHERWISE.
- THE REMOVAL OF EXISTING STRUCTURE WILL BE PAID FOR UNDER ITEM 529,2000, PARTIAL REMOVAL OF STRUCTURE. THIS WORK SHALL INCLUDE BUT NOT BE LIMITED TO THE REMOVAL OF
 - A. APPROACH SLABS
 - B. APPROACH RAILING AND BRIDGE RAILING
 - C. SIDEWALKS
 - D. DECK AND SUPERSTRUCTURE
 - E. PORTIONS OF EXISTING ABUTMENTS AND WINGWALLS AS SHOWN IN THE PLANS
 - F. PORTIONS OF THE EXISTING WINGWALLS AND
 - RETAINING WALLS WITHIN THE LIMITS OF THE PROPOSED SUBSTRUCTURE
 - G. PIERS AND PIER FOOTINGS
- 4. THE CONTRACTOR SHALL PROTECT ALL EXISTING UTILITIES FROM DAMAGE DURING ALL STACES OF CONSTRUCTION. COSTS FOR UTILITY PROTECTION SHALL BE CONSIDERED INCIDENTAL TO ALL PROJECT ITEMS, ANY DAMAGE TO UTILITIES SHALL BE REPARED TO THE SATISFACTION OF THE ENGINEER AND AT THE CONTRACTOR'S EXPENSE.
- 5. THE EXISTING SIGN AT THE SOUTHEAST CORNER OF THE MAP MESCO REALTY, LLC. PROPERTY SHALL BE REMOVED AND RESET. THE PROPESED LOCATION OF THE SIGN SHALL BE APPROVED BY THE ENGINEER, A TEMPORARY STANDALONE SIGN TO ADVERTISE FULL PRICES SHALL BE INSTALLED FOR THE DURATION THAT A PERMANENT SIGN IS NOT IN PLACE. THE TEMPORARY SIGN SHALL BE APPROVED BY THE ENGINEER PRIOR TO INSTALLATION. PAYMENT FOR THE TEMPORARY AND PERMANT SIGNS SHALL BE INCLUDED UNDER THEM 675.6000002, TREMOVE AND RESET PRIVATE SIGN SSHALL BE INCLUDED.

TRAFFIC CONTROL

- THAFFIC MANAGEMENT WILL BE ACCOMPLISHED USING AN OFF-SITE LOCAL DETOUR ON WATER STREET AND WALL STREET, AND A TRUCK DETOUR ON VT-647-887/US-2 DURING A 12 WEEK BROGE CLOSHER PERIOD, A BICYCLE/PEDESTRIAN DETOUR VIA LOCAL ROADS WILL BE SIGNED AS SHOWN, REFER TO 'TRAFFIC CONTROL PLAN' SHEET FOR ADDITIONAL HOFOMATION PERI NAMING TO TRAFFIC CONTROL.
- THE SIDEWALK AND CURB ADJACENT TO THE WESCO FUEL PUMP ISLAND WILL BE REMOVED TO MAINTAIN ACCESS TO THE FUEL PUMPS DURING THE BRIDGE CLOSURE PERIOD.
- 8. THE COST TO MAINTAIN ACCESS TO EACH PROPERTY WILL BE INCLUDED IN THE PAYMENT OF ITEM 64LIDO, "TRAFFIC CONTROL, ALL-INCLUSIVE."

EPSC

 FOR THE WET CROSSING, ALL CONSTRUCTION EQUIPMENT SHALL BE CLEAN AND WELL MAINTAINED, FREE OF FUEL, HYDRAULIC AND GEAR OIL LEAKS.

EARTHWORK AND RELATED ITEMS

10. THE "STONE FILL TYPE IV" UNDER THE BRIDGE AS SHOWN IN THE PLANS SHALL BE PLACED BEFORE THE NEW STEEL CIRDERS ARE SET.

STRUCTURAL STEEL

- ALL FIELD CONNECTIONS SHALL BE MADE USING % DIAMETER BOLTS IN % -DIAMETER HOLES, PER SECTION 506.18, UNLESS OTHERWISE SPECIFIED.
- 12. ALL WELDING SHALL CONFORM TO THE PROVISIONS OF SUBSECTION 506.10.
- ANY CONNECTIONS THAT ARE NOT DETAILED ON THE PLANS SHALL BE DETAILED BY THE FABRICATOR AND SUBMITTED TO THE STRUCTURE ENGINEER FOR APPROVAL.
- 14. STRUCTURAL STEEL MEMBERS DESIGNATED "CVN" IN THE PLANS SHALL BE CHARPY V-NOTCH TESTED IN ACCORDANCE WITH SUBSECTION 714,01 OF THE STANDARD SPECIFICATIONS.
- 15. END OF GIRDERS ARE TO BE VERTICAL IN THEIR FINAL POSITION.
- 16. AFTER SUPERSTRUCTURE STEEL HAS BEEN ERECTED, ELEVATIONS ALONG THE TOP OF THE ORIDERS SHALL BE TAKEN AS DIRECTED BY THE RESIDENT ENDMETER, FOR USE IN DETERMINING THE HEIGHT OF DECK PANEL BEDINGS STRIPS. AFTER THE DECK PANELS HAVE BEEN SET AND BEFORE THE HAUNCH POUR IS PLACED, THE CONTRACTOR SHALL RE-PROFILE THE TOP FLANCES OF THE GROBE AS DIRECTED BY THE RESIDENT ENDMETER, FOR USE IN DETERMINING SCREED RAIL ELEVATIONS AND CHAIR HEIGHTS FOR PREPORTING STEEL.

17. FLEMING BRACKETS OR SIMILAR FALSE WORK SHALL BE SPACED AS REQUIRED BY DESIGN BUT SHALL BE LIMITED TO A MAXIMUM SPACING OF 4 FEET, THE DESIGN OF FALSE WORK SHALL BE THE RESPONSIBILITY OF THE CONTRACTOR AND SHALL EXTEND AT LEAST 75% OF THE DEPTH OF THE WEB.

PAVEMENT

18. AT BEGN AND END BRIDGE, PRIOR TO GRINDING, THE 9½-DECK WILL BE ½-HICHER THAN THE WEARING COURSE, INSTALL A TEMPORARY TAPER OR WEDGE OF BITUMHOUS CONCRETE PAYEMENT AT A MINIMUM SLOPE OF 130 PRIOR TO ALLOWING TRAFFIC ON THE BRIDGE, TAPER AND/OR WEDGE SHALL BE REMOVED WHEN DECK CHINDING OCCURS.

CONCRETE

- 19. THE APPROACH SLABS AND PORTIONS OF THE ABUTMENT BELOW THE BRIDGE SEAT ELEVATION SHALL BE PERFORMANCE—BASED CONCRETE, CLASS PCS AND SHALL BE PAID UNDER ITEM 50138DO, PERFORMANCE—BASED CONCRETE, CLASS PCS' DECK CONCRETE (INCLUDING THE ABUTMENT CONCRETE ABOVE BRIDGE SEAT OR CAP ELEVATION, THE SIDEWAKES, AND MOMENT SLABS SHALL BE PERFORMANCE—BASED CONCRETE, CLASS PCD AND SHALL BE PAID LINDER ITEM 5013700, "PERFORMANCE—BASED CONCRETE, CLASS PCD."
- 20. THE DECK SHALL BE CAST TO AN INITIAL THICKNESS OF 9½", AFTER THE DECK HAS CURED AND BRIDGE RAIL AND SDEWALK ARE INSTALLED THE ENTIRE BRIDGE DECK SURFACE AND PORTIONS OF THE BRIDGE APPROACHES SMALL BE GROUND FOR A RESULTING DECK THICKNESS OF 9 INCHES, PAYVENT WILL BE MADE LUNDER ITEM 509300, "CONCRETE BRIDGE DECK SURFACE PERPERATION."
- 21. THE DECK SHALL BE POURED IN ONE CONTRUIOUS POUR WITH A MAXIMUM DURATION OF EIGHT HOURS, EXCEPT FOR THE CLOSURE POUR SECTIONS AT THE ABUTMENTS WHICH SHALL BE PLACED AT LEAST 72 HOURS AFTER THE DECK POUR HAS BEEN COMPLETED, IF CIRCUMSTANCES BEYOND THE CONTRACTOR'S CONTROL. PREVENT THE PLACEMENT IN ONE POUR, A TRANSVERSE CONSTRUCTION JOINT SHALL BE USED BETWEEN ADJACENT POURS, THE MAMMUM TIME DELAY BETWEEN ADJACENT DECK POURS SHALL BE INCLUDED IN THE CONTRACTOR'S PLACEMENT PLAN AND DISCUSSED DURNG THE PRE-PLACEMENT MEETING.
- WATER REPELLENT, SILANE, SHALL BE APPLIED TO ALL EXPOSED CONCRETE SURFACES, EXCEPT THE UNDERSIDES OF THE DECK BETWEEN DRIP NOTCHES.
- JOINTS AND SCORE MARKS IN CONCRETE SHALL BE CONSTRUCTED AS SHOWN IN THE PLANS OR AS DIRECTED BY THE RESIDENT ENGINEER,
- 24. ALL EXPOSED EDGES OF CONCRETE SHALL BE CHAMFERED I'X I',

REINFORCING STEEL

- 25. ALL REMFORCMO STEEL IN THE APPROACH SLABS SHALL MEET THE REQUIREMENTS FOR LEVEL IEPOXY COATED, ITEM SOTJIOD, TRENFORCING STEEL, LEVEL IEPOXY COATED! ALL OTHER RENFORCING SHALL BE LEVEL II, IN ACCORDANCE WITH SECTION 507 OF THE STANDARD SPECIFICATIONS AND PAID FOR UNDER ITEM 5071200, TRENFORCING STEEL, LEVEL II.
- 26. CUITING AND REPAIRING DAMAGED AREAS OF COATED REINFORCING STEEL SHALL BE PERFORMED IN ACCORDANCE WITH SUBSECTION 507,04 OF THE STANDARD SPECIFICATIONS.

INTEGRAL ABUTMENT PILES

- FOR ESTIMATING PURPOSES, THE PILE TIP ELEVATIONS WERE ASSUMED AS SHOWN ON THE BORING LOGS AND THE PROPOSED PILE SUMMARY TABLE. THE ACTUAL IN PLACE LENGTHS MAY VARY.
- PROPOSED PILES SHALL BE IN ACCORDANCE WITH SUBSECTION 730.01 OF THE STANDARD SPECIFICATIONS.
- 29. PLES SHALL BE PRE-DRILED PER THE REQUIREMENTS OF ITEM \$46,0000, "PRE-EXCAVATION OF ABUTMENT PILES, ROCK" TO THE DEPTHS \$400MN ON THE PLANS, THE MINIMUM DIAMETER OF THE EXCAVATED HOLES FOR EACH PILE SHALL BE PER THE ABUTMENT PILE SUMMARY TABLE.
- 30. THE INTERIOR OF THE PRE-BORED HOLES SHOULD BE THOROUGHLY CLEANED OF SOIL AND DEBRIS PRIOR TO THE LOWERING OF THE PILE. A WEIGHTED TAPE SHOULD BE USED TO INSPECT THE BOTTOM OF THE HOLE FOR CLEANLINESS.
- 31. FOLLOWING THE PLACEMENT OF THE PILE, FILL THE ANNULUS BETWEEN THE PILE AND THE ROCK SOCKET WITH SELF-CONSOLDATING CONCRETE. ISCORDY GRANTY FROM THE LOWEST POINT OF THE SOCKET USING THE TREME METHOD, SCC PLACEMENT SHALL CONTINUE UNTIL UNCONTAMINATED CONCRETE SUPPASSES THE LUMIS OF THE ROCK SOCKET, BUT DOES NOT EXTEND PAST THE LUMIS OF SCC SHOWN ON THE ABUTMENT PILE DETAIL SHEET, THE TEMPORARY CASING SHOULD BE EXTRACTED WHILE PLACING THE SCC SIGN THAT THE BOTTOM OF THE TEMPORARY CASING IS AT THE TOP OF THE CONCRETED SOCKET.

INTEGRAL ABUTMENT PILES (CONTINUED)

- 32. AFTER THE SCC HAS CURED, BACKFILL THE REMAINDER OF THE ANNULUS WITH CUSHION SAND AT ABUTMENT PILE LOCATIONS WHILE SIMULTANEOUSLY REMOVING THE TEMPORARY CASING, CUSHION SAND SHALL MEET THE REQUIREMENTS OF SECTION 703.03 OF THE STANDARD SPECIFICATIONS.
- CONCRETE SHALL ACHIEVE A MINIMUM 28-DAY COMPRESSIVE STRENGTH OF 5000 PSI AND MEET THE MATERIAL REQUIREMENTS OF STANDARD SPECIFICATIONS SECTION 707.0KE).
- 34. ALLOW CONCRETED SOCKETS TO CURE FOR A MINIMUM OF 24 HOURS PRIOR TO PRE-EXCAVATING WITHIN 3 SOCKET DIAMETERS OR BACKFILLING THE REST OF THE
- 35. TOLERANCES FOR THE TOPS OF THE PILES AFTER BATTER AND ROTATION SHALL MEET THE REQUIREMENTS OF SECTION 505.04(B). PILE PLACEMENT SHALL NOT VARY FROM THE POSITION SHOWN ON THE PLANS BY MORE THAN 3 INCHES.
- THE COMPRESSION RESISTANCE FACTOR FOR THE PROPOSED ROCK SOCKETS IS 0.50 FOR THE STRENGTH LIMIT STATE LOAD COMBINATION.

SOLDIER PILE RETAINING WALLS

- 37. WMNGWALLS 2 & 3 SMALL BE SOLDIER PILE WALLS, PAYMENT FOR THESE WINGWALLS SHALL BE UNDER ITEM 225.0300001, "SOLDIER PILE RETAINING WALLS".
- CONTRACTOR SHALL SUBMIT THE ARCHITECTURAL CONCRETE FACING PATTERN TO THE ENGINEER FOR APPROVAL PRIOR TO CONSTRUCTING.

WINGWALL PILES

- FOR ESTIMATING PURPOSES, THE PILE TIP ELEVATIONS WERE ASSUMED AS SHOWN ON THE BORING LOGS AND THE PROPOSED PILE SUMMARY TABLE, THE ACTUAL IN PLACE LENGTHS MAY VARY.
- PROPOSED PILES SHALL BE IN ACCORDANCE WITH SUBSECTION 730.01 OF THE STANDARD SPECIFICATIONS.
- 41. PILES SHALL BE PRE-DRILED PER THE REQUIREMENTS OF ITEM 546,0000, PRE-EXCAVATION OF ABUTMENT PILES, EARTH, AND ITEM 546,2000, PRE-EXCAVATION OF ABUTMENT PILES, ROCK TO THE DEPTHS SHOWN ON THE PLANS, THE MINRALM CHAMETER OF THE EXCAVATED HOLES FOR EACH PILE SHALL BE PER THE WINCHALL PILE SIMMARY TABLE.
- 42. THE INTERIOR OF THE PRE-BORED HOLES SHOULD BE THOROUGHLY CLEANED OF SOIL AND DERNS PRIOR TO THE LOWERING OF THE PILE, A WEIGHTED TAPE SHOULD BE USED TO INSPECT THE BOTTOM OF THE HOLE FOR CLEANINESS.
- 43. FOLLOWING THE PLACEMENT OF THE PILE, FILL THE ANNULUS BETWEEN THE PILE AND THE ROCK SOCKET WITH SELF-CONSOLUCATING CONCRETE (SCC) BY GRAVITY FROM THE LOWEST POINT OF THE SOCKET USING THE TREME METHOD, THE SCC PLACEMENT SHALL CONTINUE UNTIL THE BOTTOM OF THE CONCRETE WALL PANELS AS SHOWN ON THE WINCWALL PILE DETAIL SHEET, THE TEMPORARY CASING SHOULD BE EXTRACTED WHILE PLACING THE SCC SUCH THAT THE BOTTOM OF THE TEMPORARY CASING IS AT THE TOP OF THE CONCRETED SOCKET.
- 44. AFTER THE SCC HAS CURED, BACKFILL THE REMAINDER OF THE ANNULUS WITH CONTROLLED LOW STRENGTH MATERIAL COLSMA AT PILE LOCATIONS WHILE SMULTAMEDUSLY REMOVING THE TEMPORARY CASING, CUSHION SAND SHALL MEET THE REQUIREMENTS OF SECTION 703,03 OF THE STANDARD SPECIFICATIONS.
- CONCRETE SHALL ACHIEVE A MINIMUM 28-DAY COMPRESSIVE STRENGTH OF 5000 PSI AND MEET THE MATERIAL REQUIREMENTS OF STANDARD SPECIFICATIONS SECTION 707.0KE).
- 46. ALLOW CONCRETED SOCKETS TO CURE FOR A MINIMUM OF 24 HOURS PRIOR TO PRE-EXCAVATING WITHIN 3 SOCKET DIAMETERS OR BACKFILLING THE REST OF THE PILE SOCKET,
- 47. TOLERANCES FOR THE TOPS OF THE PILES AFTER BATTER AND ROTATION SHALL MEET THE REQUIREMENTS OF SECTION 505.04(B). TOLERANCES FOR THE PLACEMENT OF THE WINGWALL PILES SHALL ALSO WEET THE REQUIREMENTS OF SECTION 505.04(B).
- 48. THE COMPRESSION RESISTANCE FACTOR FOR THE PROPOSED ROCK SOCKETS IS 0.50 FOR THE STRENGTH LIMIT STATE LOAD COMBINATION.



PROJECT NAME: NORTHFIELD

PROJECT NUMBER: BF 0241(58)

FILE NAME: zi9J223no+es.dgn PROJECT LEADER: K. SMITH DESIGNED BY: S. BROWN CENERAL NOTES SHEET PLOT DATE: 5/29/2025
DRAWN BY: C. JAMISON
CHECKED BY: K. SMITH
SHEET 5 OF 102

QUANTITY SHEET 1

SUMMARY OF I	ESTIMATED QU	ANTITIES				тот	ALS		DESCRIPTIONS	
	1011 - ROADWAY	1031 - TRANING	EROSION CONTROL	1211 - BREGE NO. 1	1990 - FULL C.E. ITEMS	GRAND TOTAL	FMAL	UNIT	ITEMS	MEM NUMBER ROUN
				80000		80000		DL	NCENTIVE OR DISINCENTIVE (N.A.B.L.)	199,8101
	1					1		LS	CLEARING AND GRUBBING INCLUDING INDIVIDUAL TREES AND STUMPS	1 201.1000 I
	1200					1200		CY	COMMONEXCAVATION	203.1500
	5					5		CY	SOLID ROCK EXCAVATION	203,1600
	15	1 -	1			15		CY	UNCLASSFIED EXCAVATION	203.1700
	1950					1950		CY	UNCLASSIFIED CHANNEL EXCAVATION	203.2700
	900	1				900		CY	TRENCH EXCAVATION OF EARTH	204.2000
	1					.1		CY	TRENCH EXCAVATION OF ROCK	204.2100
	1					1 -		CY	TRENCHEXCAVATION OF EARTH, EXPLORATORY (NA.B.L)	204.2200
				748		748		CY	STRUCTURE EXCAVATION	204.2500
				698		698		CY	GRANULAR BACKFILL FOR STRUCTURES	204,3000
	230	9				230		SY	COARSE-MILLING, BITUMNOUS PAVEMENT	1
				1				LS		210,1000
									RETAINING WALL, CAST-IN-PLACE CONCRETE (MINOWALL 2)	225.0300
			<u> </u>	1					RETAINING WALL, CAST-IN-PLACE CONCRETE (WINGWALL 3)	225.0300
								LS	RETAINING WALL, CONCRETE (WING/WALL 1)	225,0500
	500000			1		1		LS	RETAINING WALL CONCRETE (WINGWALL 4)	225,0500
						500000		DL	DISPOSAL OF CONTAMINATED MATERIALS (N.A.B.L)	230.0010
	1					1		LS	PROJECT OPERATIONS PLAN	230.0030
	1				- 1	. 1		LS _	PROJECT OPERATIONS COMPLETION REPORT	230.0040
	480					480		HR.	ENVIRONMENTAL OVERSIGHT	230,0050
	1-1-					1.		LS	MANAGEMENT OF CONTAMINATED GROUNDWATER	230.0060
	848					848		CY	SUBBASE OF DENSE GRADED CRUSHED STONE	301,3500
	100					100		CWT	TACK COAT EMULSIFIED ASPHALT	404,1100
	155	1				155		TON	BITUMINOUS CONCRETE PAVEMENT, TYPE RS, QATTER III	406,0230
	138				-	138		TON	BITUMNOUS CONCRETE PAVEMENT, TYPE IIS, QATIER II	408.0330
	220				-	220	_	TON	BITUMINOUS CONCRETE PAVEMENT, TYPE IVS, QA TIER II	406.0430
	310					310		SY	BITUMINOUS CONCRETE PAVEMENT, NON-PAVER PLACED, TYPE IVS	406.3400
 	+-1					1_1_		DL	PAY ADJUSTMENT, BCP, MIXTURE PROPERTIES (N.A.B.L)	406.9100
 	ļI			355	I	355		CY	PERFORMANCE-BASED CONCRETE, CLASS PCD	501.3700
				145		145		CY	PERFORMANCE-BASED CONCRETE, CLASS PCS	501,3800
	-			1		1		LS	FURNISHING EQUIPMENT FOR DRIVING PILING	504.1000
				364		384		LF	STEEL PILING, HP 12 × 84	505,1850
				2		2		EACH	DYNAMIC PILE LOADING TEST	505,4500
				327200		327200		LB	STRUCTURAL STEEL, PLATE GIRDER	508.5500
				7800		7800		LB	REINFORCING STEEL, LEVEL!	507,1100
				101100		101100		LB	REINFORCING STEEL, LEVEL II	507,1200
				1		1		LS	SHEAR CONNECTORS (1974 - 7/9 X 7IM)	508,1500
				5384		5384		SF	CONCRETE BRIDGE DECK SURFACE PREPARATION	509,1500
				5588		55/18		SF	PRESSRESSED CONCRETE DECK PANELS	510.4000
				50		50		GAL.	WATER REPELLENT, SILANE	
								GAL,	PRICE CONTROL SEARCE	514.1000 !

	_	DETAILED SUMMARY OF QUANTITIES
QUANTITIES	URIT	ITEMS
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PROJECT NAME: NORTHFIELD

PROJECT NUMBER: BF 0241(58)
FILE NAME: 291223quon1111ee.dgn
PROJECT LEADER: K. SMITH
DESIGNED BY:
UNANTITIES SHEET I PLOT DATE: 5/29/2025 DRAWN BY: C. JAMISON CHECKED BY: K. SMITH SHEET 6 OF 102

QUANTITY SHEET 2

11 C 20 C 10 C	SUMMA	RY OF ESTIMATED QUA	WITTES				TOTA	ALS		DESCRIPTIONS	
		1011 - RCADWAY	1031 - TRANNG	EROSION CONTROL	1211 - BRIDGE NO, 1	1909 - FULL C.E. ITEMS	GRAND TOTAL	FWAL	UNIT	ITEMS	ITEM NUMBER ROU
					76		76		LF	BRIDGE EXPANSION JOINT, ASPHALTIC PLUG	516.1000
					76		76		LF	JONT SEALER, HOT POURED	524,1100
				_	329		329		LF	BRIDGE RAILING, TEXAS RAIL WITH WINDOWS	525.5200
					11		1		EACH	PARTIAL REMOVAL OF STRUCTURE	529.2000
		1					,			FLOWABLE FILL, EXCAVATABLE	541,4600
		- I.			224		224			PRE-EXCAVATION OF ABUTIMENT PILES, EARTH	548.1000
		+	1		98		98	~	LF	PRE-EXCAVATION OF ABUTIMENT PILES, ROCK	
		110					110		LF	24 NCH CPEP	548.2000 601.0920
		70				-	70		LF	30 NCH CPEPISL)	
		63									601.2825
							83		LF	36 NCH CPEP(SL)	601.2630
		1	+ -				1		EACH	30 NCH CPEPES	601.7025
							1		EACH	38 NCH CPEPES	601.7030
		2					2		EACH	PRECAST REINFORCED CONCRETE DI WITH CAST IRON GRATE	604,1800
		2	- 1				2		EACH	CHANGING ELEVATION OF DIS, CATCH BASINS, OR MANHOLES	604,4000
		3					3 _		EACH	CAST RON GRATE WITH FRAME, TYPE D	604.4504
		158				-	158		LF	UNDERDRAIN PIPE, 8 INCH	605.1008
	United the second	180					180		CY	E-STONE FILL, TYPE I	613,06D1
		900			910		1810		CY	STONE FILL, TYPE IV	813.1004
				7	_		1		LS	IN-WATER SEDIMENT ISOLATION MEASURES	B14.2000
		280		-	-		280		······	VERTICAL GRANITE CURB	616.2100
		33	**			-	33	_	LF	REMOVING AND RESETTING CURB	618,4000
		37				_	37		LF	REMOVAL OF EXISTING CURB	818.4100
		170					170		SY	PORTLAND CEMENT CONCRETE SIDEWALK, 5 INCH	618,1005
		81					61		SY	PORTLAND CEMENT CONCRETE SIDEWALK, 8 INCH	818.1008
		25					25				
									SF	DETECTABLE WARNING SURFACE	618.3000
	water of feeting to	20					20		LF.	CHAIN-LINK FENCE, 8 FOOT	620,1006
		20					20		LF	REMOVAL OF EXISTING FENCE	620.5500
	Address of the state of the sta	100	E	i		-	100		LF	REMOVAL OF GUARDRAIL	621,0100
			- 	11	-		1		LS	WATER MAN ON BRIDGE, ALL-INCLUSIVE	629.1700002
						1	1		LS	FIELD OFFICE ENGINEER'S	631.1000
						1	1	_	LS.	TESTING EQUIPMENT, CONCRETE	631,1600
						1 1	1		LS	TESTING EQUIPMENT, BITUMNOUS	631,1700
						3000	3000		DL	FIELD OFFICE COMMUNICATIONS (N.A.B.L.)	631,2600
		14					14		EACH	CPM SCHEDULE	633,1000
			520				520		HR	EMPLOYEE TRAINEESHIP	634,1000
							7		LS	MOBILIZATION/DEMOBILIZATION	835,1100
		1		1					LS	TRAFFIC CONTROL, ALL-INCLUSIVE	841.1100
						-	1		LS	MAINTENANCE OF PEDESTRIAN TRAFFIC	841,1200
		1650					1850		LF	DURABLE 4 INCH WHITE LINE, EPOXY PAINT	- 1
		1120					1120		LF	DURABLE 4 INCH WHITE DINE EPOXY PAINT DURABLE 4 INCH YELLOWLINE EPOXY PAINT	648.4030 846.4130

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DETAILED SUMMARY OF QUANTITIES



FILE NAME: zi9J223quantftles.dgn PROJECT LEADER: K. SMITH DESIGNED BY: QUANTITIES SHEET 2 PLOT DATE: 5/29/2025 DRAWN BY: C. JAMISON CHECKED BY: K. SMITH SHEET 7 OF 102

QUANTITY SHEET 3

				1011 - ROADWAY	1031 - TRAINING	EROSION CONTROL	1211 - BRIDGE NO. 1	1999 - FULL C.E. ITEMS	GRAND TOTAL	FINAL	UNIT	TEMS	ПЕМ НОМВЕК	ROUNE
				1280	-				1280		LF	DURABLE 6 INCH WHITE LINE, EPOXY PAINT	848,4230	
				1 12					12		EACH	DURABLE LETTER OR SYMBOL EPOXY PAINT	648,4930	
				80					80		LF	DURABLE CROSSWALK MARKING, THERMOPLASTIC	648.5020	
							685		885		SY	GEOTEXTILE UNDER STONE FILL	649,3100	
			2		i	1780			1780		SY	TURF ESTABLISHMENT, GENERAL SEED	651,1500	
	1 1 1 1 1 1					198			198		CY	TOPSOIL	851,3500	
						1 510			510		SY	GRUBBING MATERIAL		
						1			1		LS	EPSC PLAN	853.0100	
						: 80		-	- 80		HR	MONITORING EPSC PLAN	653.0200	
						3000			3000			MAINTENANCE OF EPSC PLAN (NA.B.L)	653.0300	
						1			1		TON	HAYMULCH	653.1000	
						282			282		SY	ROLLED EROSION CONTROL PRODUCT, TYPE I		
				-		120			120		CY	STABILIZED CONSTRUCTION ENTRANCE	653,2001	
						10			10			NUET PROTECTION DEVICE, TYPE I	653,4002	
						3			3		EACH	FILTER BAG		
						280			260			SILT FENCE, TYPE I	653,4500	
						600			600			BARRIER FENCE	653,4702	
				1					1			TREE PROTECTION	653,5000	
				45					45		SF		858,8500	
				87	-		1	-	87			TRAFFIC SIGN, FLAT SHEET ALUMINUM	875.2000	
	~ .			2					2			SQUARE TUBE SIGN POST AND ANCHOR	B75.3410	
				3		1 - 1			3			FOUNDATION FOR TUBULAR STEEL POST	675.4300	
				4					4			SIGN REMOVAL, FLAT SHEET ALUMNUM	675.5000	
									1			RESETTING SIGNS	875,6000	
				4					1 4			REMOVE AND RESET PRIVATE SIGN ASSEMBLY, LIGHTED	675.6000002	
												DELINEATOR WITH STEEL POST	676.1000	
		-							1			REMOVE AND RESET LIGHT POLE	879.2500	
1									1			PRICE ADJUSTMENT, ASPHALT (NA.B.I.)	690.0300	
				20								PRICE ADJUSTMENT, FUEL (N.A.B.I.)	690,0400	
	-			20					20		LF	F-184-5.1 FENCE	899,5150	
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QUANTITIES	UNIT	ITEMS
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PROJECT NAME: NORTHFIELD
PROJECT NUMBER: BF 024I(58)

FILE NAMEs zi9J223quon+1+1es.dgn PROJECT LEADERs K. SMITH DESIGNED BY: QUANTITIES SHEET 3 PLOT DATE: 5/29/2025 DRAWN BY: C. JAMISON CHECKED BY: K. SMITH SHEET 8 OF 102

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		TOTAL EX	EAVATION RTH	EXCA	OCK VATION	ЕМВА	NKMENT					TOTAL EX	CAVATION RTH	EMBAI	NKMENT	EXCA!	OCK VATION					SUN	MARY AN	ID BALAN	CES			
TATION	DIST	AREA	VOLUME	AREA	VOLUME	AREA	VOLUME	AREA	VOLUME	STATION	DIST	AREA	VOLUME	AREA	VOLUME	AREA	VOLUME	AREA	VOLUME	STATION TO STATION	TOT EXC.	ROCK EXCAV	EMBANK	EXCE	SSES	ACUMULATIV	E EXCESSES	
	FT.	S.F.	C.Y.	S,F,	C.Y.	8.F.	C.Y.	S.F.	C.Y.		FT.	S.F.	C.Y.	S.F.	C,Y.	δ.F.	C,Y,	S.F.	C.Y.		C.Y.	C.Y.	C.Y.	CUT	FILL	сит	FILL	
AIN ST	VT 12)		!		1		-j			DOG RIVER	(CHANN	EL)								N MAIN ST (VT 12)			_				1	
20+30		0.0			-	0.0	-	-		50+00		0.0		0,0			-			220+30 222+89	878	2.5	0	881				
	20		0.0		### · ***		0.0				25		0.0							224+11 226+50	607	. 2.5	0	610				
0+50	25	0.0	0.0	-	+	0.0	0.0			50+25	25	0.0	0,0	0.0	0.0					50+00 52+59	1921	0	0	1921				
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1+00	25	0.0	0.0			0.0	0.0			50+93	43	0.0	0.0	0.0	0.0	-	-				_					_		-
21+25	25	9.5	4.4			Q.D	0.0			51+00	7	228.3	29.6		0,0		1											
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21+50	25	10.9	39.3		1	0.0	1_00	-	_	51+10	10	320.7	174.4	0.5	0,4		į —						-				4	
21+75		73.9			1	0.0	1			51+20		620.9		1.9			<u> </u>										7.5	
22+00	25	129.8	94.3		1	_ 0.0	0.0	-		51+30	10	411.2	191,1	0.0	0.4	-	-					-						_
22+25	50		278,3				0.0				10		153.B		0.0				Selection hade # 1			~				-1		
	44	162.7	313.5		•	0.0	0.0			51+40	10	419.5	157.1	0.0	0.0	-	-		-			-						-
22+50	19	170.B	1 139.0			0.0	0.0			51+50		428.8		0.0					-									
22+69	18	220.6				0.0	1			51+60	10	436.0	160,1	0.0	0.0													-
ECAL BO	WATE O T	222+69	0.0	,			_ 0,0			51+70	.10	441.0	162.4		0.0				-					.,				
ND BRID	DGE STA	224+10.83	3							51+/0	10	441.0	195.5	0.0	1.1						_	_						-
24+11		212.9	L							51+80	10	614.5		5.8														
12 1	14	212.9	132.8		-	0.0	0.0			51+90	10	325.8	174.1	3.7	1.8	-			_	-	_				-			
24+25		298.5	0000			0.0	-i				10 _		103.4		_3.1_													
24+50	_ 25	154.9	209.9			0.0	0.0			52+00	15	232.7	119.9	13.2	11.6				~		*********				-			
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	25	_93,5	74.6		+	.0.0_	0.0	-		52+25	_10	176.1	69.5	34.2	11.6				·						-			
25+00	25	67.7	53.2		-	0.0		-		52+50.0	25		115.9		15.8													
25+25	25	47.2	33.Z	150	k=1134	0.0	ļ 0.0 <u>.</u> .				- · · · · · · ·	74,3	12.4	0.0	0.0				-									
25+50	25	0.0	21.8	-		0.0	: 0.0			52+59		0.0		0.0		_			-									
	25		0.0				0.0															-	_					
25+75	25	0.0	0.0		-	0.0	. 0.0	-								-	-		7.7.									
26+00		0.0	1			0.0			-								1				_		1	_	_			-
26+25	25	0.0	0.0		-	0.0	0.0				-	-	-	-		-	_											
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29+50	-	0.0	-	-		0.0	_	-				-	-	-			-			TOTAL	2496	5	0	3411	0	3411		
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-	-	-	-	-	•	-	-	-	-	-			-	-	-	-	-		1									
						-														EARTH AND ROCK EXC	CAVATION	-		3411				
			-	-	_	-	+	-		-	-	-	-	-	+	-	-	-	-	SOLID ROCK EXCAVAT EARTH EXCAVATION	HON			3406				
				_	1																			3400				
	+			-	+		+			-		-		-				-	-	PLANMETERED FILL LESS FACTORED SOLI	DROCK			0				
			1		+		1	-												LESS DISPLACEMENT	OF ANY LA	RGE STRUC	TURES	0				
_	_	_		-	1	-	1	-	-	-	-	+	-	-	_	-	+		+	NET PLANDMETERED FI	TILL.			115		-		
																				PLANMETERED FILL N	CLUDING F	ACTOR		1.15				
			1						-		_	1	-	+	1	+	1	-					-					
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	-	1			+ -		1	-				-	-	-	-	-			-	EARTH EXCAVATION CHANNEL EXCAVATION				1485				
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PROJECT NAME: NORTHFIELD
PROJECT NUMBER: BF 024(58)

FILE NAME: 219,2230-ws.dgn PROJECT LEADER: K. SMITH DESIGNED BY: K. HO EARTHWORK SHEET

PLOT DATE: 5/29/2025 DRAWN BY: J. DIAZ CHECKED BY: C. JENNE SHEET 9 OF 102

GENERAL INFORMATION

SYMBOLOGY LEGEND NOTE

STMBOLOGY LEGEND NOTE

THE SYMBOLOGY ON THIS SHEET IS INTENDED TO COVER
STANDARD CONVENTIONAL SYMBOLOGY. THE SYMBOLOGY IS
USED FOR EXISTING & PROPOSED FEATURES WITH HEAVIER
LINEWEIGHT, IN COMBINATION WITH PROJECT ANNOTATION,
AS NOTED ON PROJECT PLAN SHEETS. THIS LEGEND
SHEET COVERS THE BASICS. SYMBOLOGY ON PLANS
WARY, PLAN ANNOTATIONS AND NOTES SHOULD BE
USED TO CLARIFY AS NEEDED,

R.O.W. ABBREVIATIONS (CODES) & SYMBOLS

POINT	CODE	DESCRIPTION	
	BF	BARRIER FENCE	-
	CH	CHANNEL EASEMENT	
	CONST	TOTAL ENGLISHE	
	CUL	CULVERT EASEMENT	
	D&C	DISCONNECT & CONNECT	
	DIT	DITCH EASEMENT	
	DR	DRAINAGE EASEMENT	
	DRIVE	DRIVEWAY EASEMENT	
	EC	EROSION CONTROL	
	HWY	HIGHWAY EASEMENT	
	I&M	INSTALL & MAINTAIN EASEMENT	
	LAND	LANDSCAPE EASEMENT	
	PDF	PROJECT DEMARCATION FENCE	
	R&RES		
	R&REP		
	R.T. & I.		
	SR	SLOPE RIGHT	
	UE	UTILITY EASEMENT	
	(P)	PERMANENT EASEMENT	
	(T)	TEMPORARY EASEMENT	
	BNDNS	BOUND SET	
Ô	BNDNS	BOUND TO BE SET	
0	IPNF	IRON PIN FOUND	
•	IPNS	IRON PIN TO BE SET	
×	CALC	EXISTING ROW POINT	
0	PROW	PROPOSED ROW POINT	
[LENG	THT	LENGTH CARRIED ON NEXT SHEET	

COMMON TOPOGRAPHIC POINT SYMBOLS

POINT	CODE	DESCRIPTION
#	APL	BOUND APPARENT LOCATION
٥	BM	BENCHMARK
•	BND	BOUND
(C)	CB	CATCH BASIN
ф	COMB	COMBINATION POLE
	DITHR	DROP INLET THROATED DNC
ф	EL	ELECTRIC POWER POLE
•	FPOLE	FLAGPOLE
0	GASFIL	GAS FILLER
0	GP	GUIDE POST
	GSO	GAS SHUT OFF
	GUY	GUY POLE
•	GUY₩	GUY WIRE
100	GV	GATE VALVE
₿	н	TREE HARDWOOD
Δ	HCTRL	CONTROL HORIZONTAL
A	HVCTRL	CONTROL HORIZ. & VERTICAL
•	GYH	HYDRANT
•	IP	IRON PIN
•	IPIPE	IRON PIPE
ф	LI	LIGHT - STREET OR YARD
\$	MB	MAILBOX
٥	Мн	MANHOLE (MH)
19	ММ	MILE MARKER
•	PM	PARKING METER
В	PMK	PROJECT MARKER
•	POST	POST STONE/WOOD
8	RRSIG	RAILROAD SIGNAL
•	RRSL	RAILROAD SWITCH LEVER
***	S	TREE SOFTWOOD
•	SAT	SATELLITE DISH
63	SHRUB	SHRUB
ਚ	SIGN	SIGN
凡	STUMP	STUMP
٥	TEL	TELEPHONE POLE
•	TIE	TIE
0.0	TSIGN	SIGN W/DOUBLE POST
A.	VCTRL	CONTROL VERTICAL
D	WELL	WELL
-	₩S0	WATER SHUT OFF

THESE ARE COMMON VAOT SURVEY POINT SYMBOLS FOR EXISTING FEATURES, ALSO USED FOR PROPOSED FEATURES WITH HEAVIER LINEWEIGHT, IN COMBINATION WITH PROPOSED ANNOTATION.

PROPO:	SED GEOMETRY CODES	
CODE	DESCRIPTION	
PC	POINT OF CURVATURE	
PI	POINT OF INTERSECTION	
CC	CENTER OF CURVE	
PT	POINT OF TANGENCY	
PCC	POINT OF COMPOUND CURVE	
PRC	POINT OF REVERSE CURVE	
POB	POINT OF BEGINNING	
POE	POINT OF ENDING	
STA	STATION PREFIX	
ΔH	AHEAD STATION SUFFIX	
BK	BACK STATION SUFFIX	
D	CURVE DEGREE OF (IOOFT)	
R	CURVE RADIUS OF	
T	CURVE TANGENT LENGTH	
L	CURVE LENGTH OF	
Ε	CURVE EXTERNAL DISTANCE	
CB	CHORD BEARING	

INDERGROUND UTILITIES	
UGU	UTILITY (GENERIC-UNKNOWN)
- vr	TELEPHONE
— υε — · · · -	ELECTRIC
— uc — · · - · · -	CABLE (TV)
— UEC	ELECTRIC+CABLE
UET · · -	ELECTRIC+TELEPHONE
— ucr — · · - · · -	CABLE+TELEPHONE
— UECT — · · - · · -	ELECTRIC+CABLE+TELEPHONE
- c - · · - · · -	GAS LINE
- *	WATER LINE
— s — · · - · · -	SANITARY SEWER (SEPTIC)
<u>+</u> ε <u>+ · · · · · · · · · · · · · · · · · · </u>	UTILITY (GENERIC-UNKNOWN) TELEPHONE ELECTRIC CABLE (TV)
EC _ ET	ELECTRIC+CABLE ELECTRIC+TELEPHONE
— ET — · · - · · - · · - · · — · · · · · · ·	
— ET — · · - · · -	ELECTRIC+TELEPHONE
— ET — · · - · · - · · - · · — · · · · · · ·	ELECTRIC+TELEPHONE ELECTRIC+TELEPHONE

PROJECT CONSTRUCTION SYMBOLOGY

PROJECT DESIGN & L	AYOUT SYMBOLOGY
_ · · · cz - · · ·	CLEAR ZONE PLAN LAYOUT MATCHLINE
	PLAN LATOUT MATCHLINE

PROJECT CONSTRUCTION FEATURES

	TOP OF CUT SLUPE
0 0 0 0	TOE OF FILL SLOPE
8 8 8 8 8 8	STONE FILL
	BOTTOM OF DITCH &
=======::	CULVERT PROPOSED
	STRUCTURE SUBSURFACE
PDFPDF	PROJECT DEMARCATION FENCE
BF	BARRIER FENCE
**************************************	TREE PROTECTION ZONE (TPZ)
111111111111111111	STRIPING LINE REMOVAL
~~~~	SHEET PILES

### CONVENTIONAL BOUNDARY SYMBOLOGY

BOUNDARY LINES

10m US C	TOWN BOUNDARY LINE
	COUNTY BOUNDARY LINE
min un	STATE BOUNDARY LINE
<del></del>	PROPOSED STATE R.O.W.
	(LIMITED ACCESS)
	PROPOSED STATE R.O.W.
	STATE ROW (LIMITED ACCESS)
	STATE ROW
	TOWN ROW
	PERMANENT EASEMENT LINE (P)
.=	TEMPORARY EASEMENT LINE (T)
	SURVEY LINE
P - P -	PROPERTY LINE (P/L)
SR SR SR	SLOPE RIGHTS
8	6F PROPERTY BOUNDARY
# ——— # ——	4F PROPERTY BOUNDARY
HAZ	HAZARDONS WASTE

### EPSC LAYOUT PLAN SYMBOLOGY

OWWOOWWOOWWO	FILTER CURTAIN
	SILT FENCE
0 0 X 0 X 0 X	
<b>*</b>	CHECK DAM
L	DISTURBED AREAS REQUIRING RE-VEGETATION
	EROSION MATTING
<b>&gt;&gt;</b>	EROSION LOG
SEE EPSC DETAIL	SHEETS FOR ADDITIONAL SYMBOLOGY
ENVIRONMENTAL	RESOURCES
	WETLAND BOUNDARY
	RIPARIAN BUFFER ZONE
	WETLAND BUFFER ZONE
	SOIL TYPE BOUNDARY
	THREATENED & ENDANGERED SPECIES
HAZ — HAZ —	HAZARDOUS WASTE AREA
	AGRICULTURAL LAND
	FISH & WILDLIFE HABITAT
- FLOOD PLAN-	FLOOD PLAIN
	ORDINARY HIGH WATER (OHW)
	STORM WATER
	USDA FOREST SERVICE LANDS
	WILDLIFE HABITAT SUIT/CONN
RCHEOLOGICAL	& HISTORIC
— ARCH—	ARCHEOLOGICAL BOUNDARY
-HISTORIC DIST-	HISTORIC DISTRICT BOUNDARY
	HISTORIC AREA
	merene anda
•	HISTÓRIC STRUCTURE

### CONVENTIONAL TOPOGRAPHIC SYMBOLOGY

XISTING FEATURES	
	ROAD EDGE PAVEMENT
***************************************	ROAD EDGE GRAVEL
	DRIVEWAY EDGE
	DITCH
	FOUNDATION
×	FENCE (EXISTING)
0	FENCE WOOD POST
000-	FENCE STEEL POST
	GARDEN
00000	ROAD GUARDRAIL
<b>-0110000000000000000000000000000000000</b>	RAILROAD TRACKS
	CULVERT (EXISTING)
CONTROL CONTRO	STONE WALL
	WALL
Lutututut	WOOD LINE
where	BRUSH LINE
***************************************	HEDGE
<u> </u>	BODY OF WATER EDGE
NICONIUS SILIS SILIS	LEDGE EXPOSED

PROJECT	NAMEL	NOI	RTHFIELD
PROJECT	NUMBER:	BF	024(58)
EU E 1411			

FILE NAME: si91223symlegend.dgn PROJECT LEADER: K. SMITH DESIGNED BY: VTRANS CONVENTIONAL SYMBOLOGY LEGEND PLOT DATE: 5/29/2025 DRAWN BY: VTRANS CHECKED BY: VTRANS SHEET IO OF 102

S z 0 0_ ROI ONTE  $\bar{\circ}$ S GP

STATE PLANE COORDINATES WERE DERIVED THROUGH THE USE OF RTK GPS UTILIZING THE VERMONT CORS SYSTEM POINTS ONE AND TWO WERE OCCUPIED WITH LEICA GSI5 GNSS UNITS, POINTS THREE, TEN, AND THIRTY ONE WERE CREATED WITH A LEICA ISIG ROBOTIC TOTAL STATION

VCAP

NORTH = 642.229.41

EAST = 1.618.636.27


ORTHO HEIGHT = 617.5


This is a GPS Continuously Operating Reference Station, VERNONT CAPITAL CORS ARP


CORS.10 - VTRU
PID - AF9563


STATE/COUNTY - VTWASHINGTON


COUNTRY - USCONDER - U

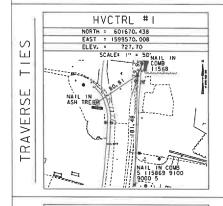

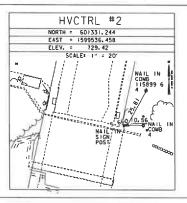

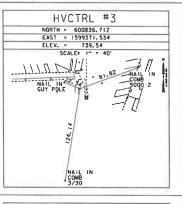

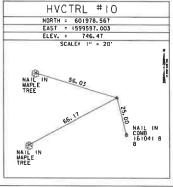

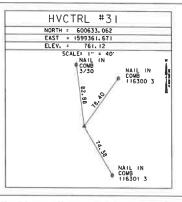

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	EAST = 1599565, 674	
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POB 220+25.00
NORTH = 600972.89
EAST = 1599429.98
NOT TIED

PC 224+70.83	
NDRTH = 601409,00	_
EAST = 1599522.55	
NOT TIED	

PT 226+33.41
NORTH = 601570.00
EAST = 1599544.00
NOT TIED

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	POE 228+04.68	
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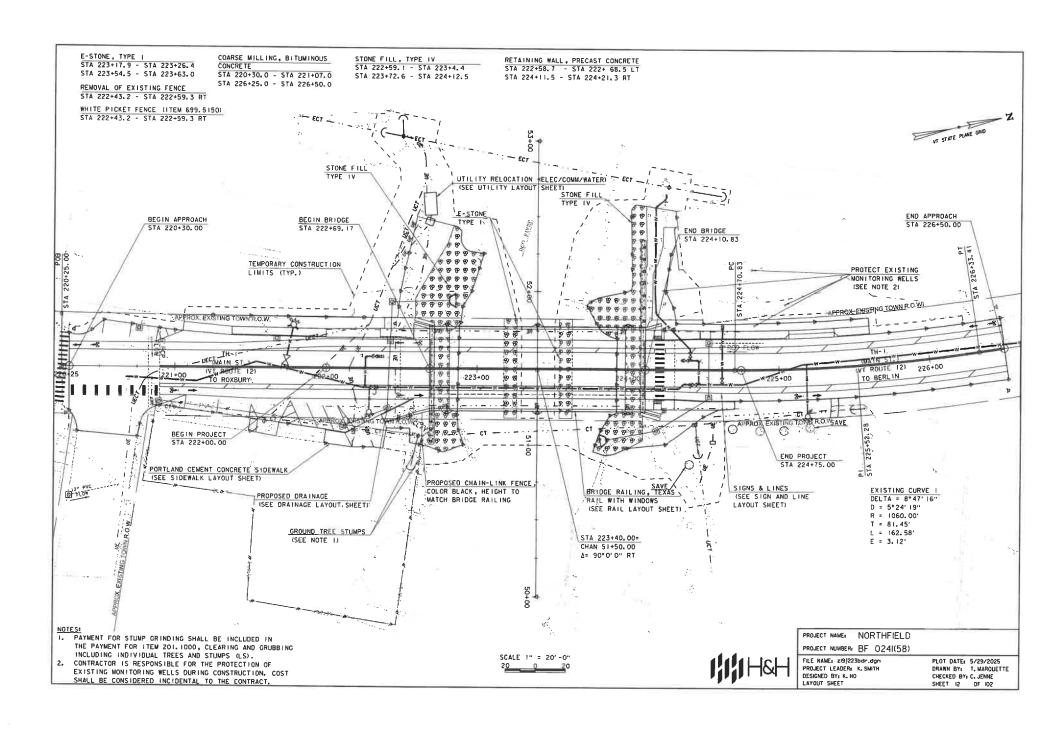
DATUM


NAVO 88 VERTICAL HORIZONTAL NAD 83 (2010) ADJUSTMENT Least Sq.


PROJECT NAME: NORTHFIELD PROJECT NUMBER: BF 0241(58)


FILE NAME: 219322311.dgm PROJECT LEADER: K. SMITH DESIGNED BY: K. HO SURVEY TIE SHEET

PLOT DATE: 5/29/2025 DRAWN BY: S.BROWN CHECKED BY: K,HO SHEET II OF 102



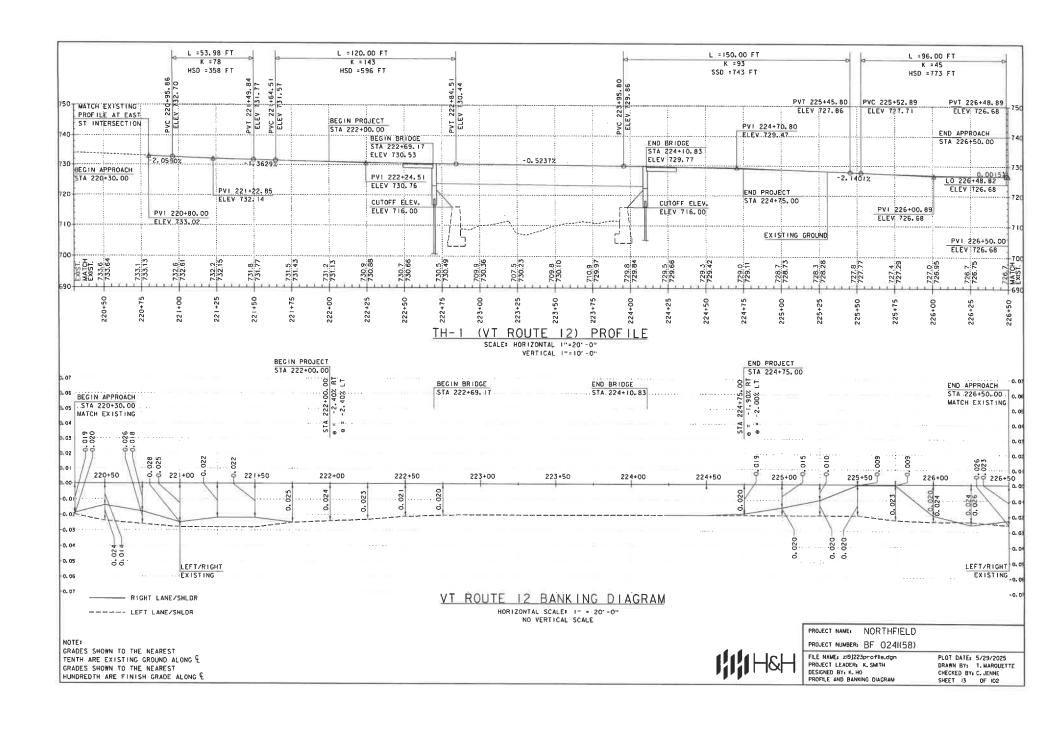

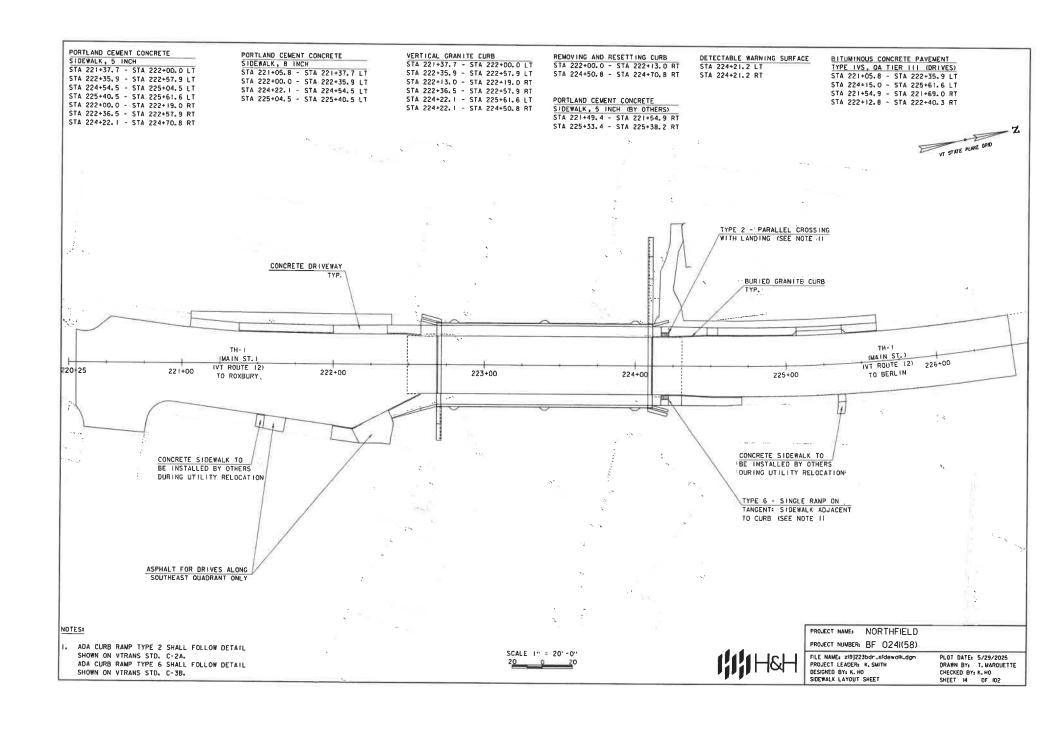

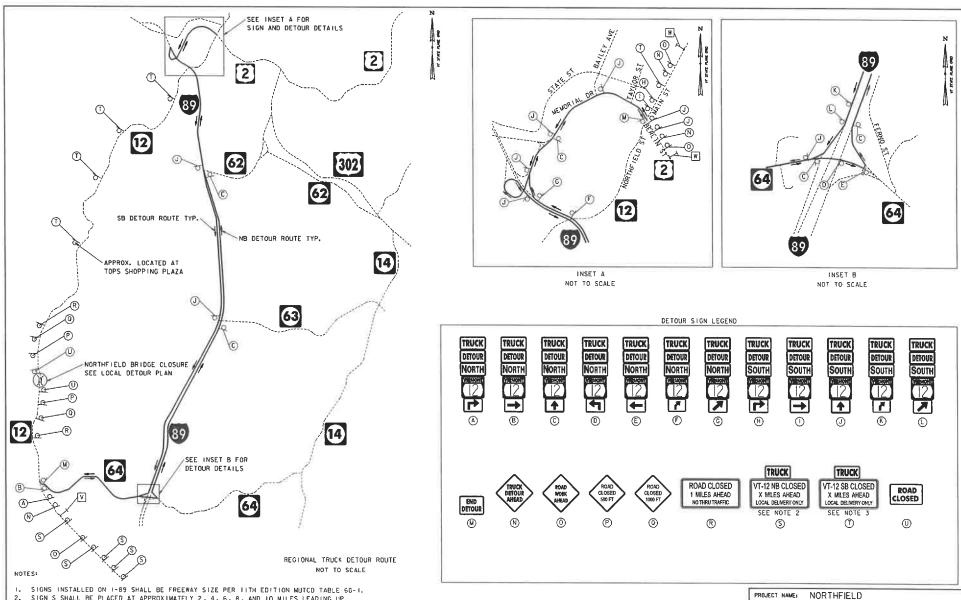

SIGN S SHALL BE PLACED AT APPROXIMATELY 2, 4, 6, 8, AND 10 MILES LEADING UP


3. SYMBOL V REFERS TO A PCMS DISPLAYING THE MESSAGE: "VT-12 NORTH CLOSED 7 PM MM/DD - 7 AM MM/DD".

4. SYMBOL W REFERS TO A PCMS DISPLAYING THE MESSAGE: "VT-12 SOUTH CLOSED 7 PM MM/DD - 7 AM MM/DD".

PROJECT NUMBER: BF 0241(58)

FILE NAME: zi9J223detour.dgn PROJECT LEADER: K, SMITH DESIGNED BY: K. HO TRUCK DETOUR ROUTE

PLOT DATE: 5/29/2025 DRAWN BY: T. MARQUETTE CHECKED BY: C. JENNE SHEET IS OF 102

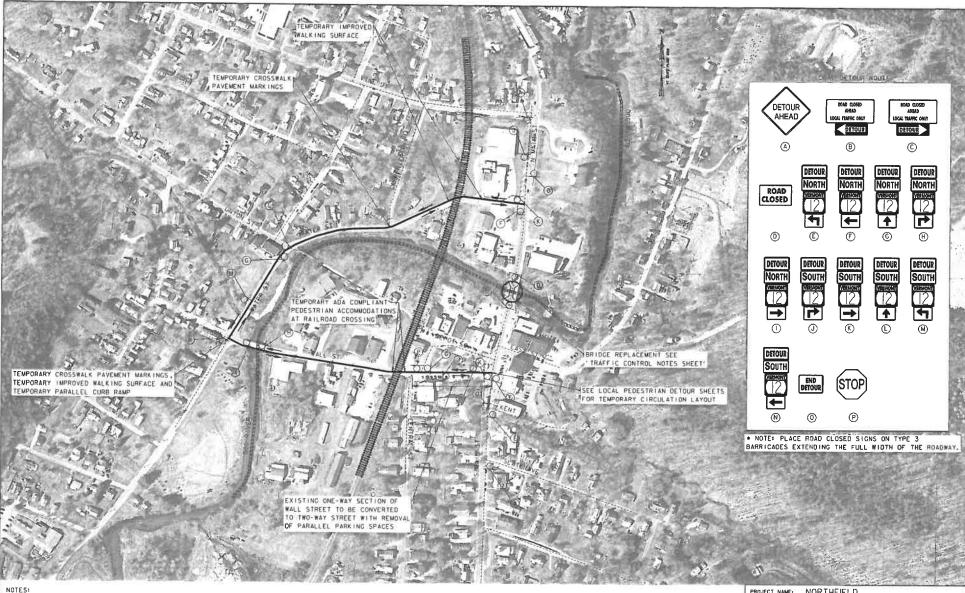

- 1. REFER TO LOCAL PEDESTRIAN DETOUR SHEETS FOR ADDITIONAL DETAILS.
- 2. SIDEWALK AND DRIVEWAY ACCESS TO COMMERCIAL BUSINESSES SHALL BE MAINTAINED AT ALL TIMES.



PROJECT NAME: NORTHFIELD PROJECT NUMBERS BF 0241(58)

FILE NAME: zi9]223detour.dgn PROJECT LEADER: K, SMITH DESIGNED BY: K. HO LOCAL DETOUR ROUTE

PLOT DATE: 5/29/2025 DRAWN BY: T. MARQUETTE CHECKED BY: C. JENNE SHEET 16 OF 102

### TRAFFIC CONTROL NOTES

- TRAFFIC MANAGEMENT WILL BE ACCOMPLISHED USING AN OFF-SITE LOCAL DETOUR ON WATER STREET
  AND WALL STREET, AND A TRUCK DETOUR ON VT-64/I-89/US-2 DURING A 12 WEEK BRIDGE CLOSURE PERIOD.
- 2. A BICYCLE/PEDESTRIAN DETOUR VIA LOCAL ROADS WILL BE SIGNED AS SHOWN.
- 3. SIDEWALK AND DRIVEWAY ACCESS TO COMMERCIAL BUSINESSES SHALL BE MAINTAINED AT ALL TIMES.
- 4. TRAFFIC FROM GAS STATION ON NORTH SIDE OF BRIDGE TO USE PORTION OF DRIVEWAY AS EGRESS.
- A PORTION OF THE GAS STATION DRIVEWAY WILL BE CLOSED WITH TEMPORARY CONCRETE BARRIERS FOR WORK ZONE PURPOSES.
- EXISTING ONE-WAY SECTION OF WALL STREET TO BE CONVERTED TO TWO-WAY STREET WITH REMOVAL OF PARALLEL PARKING SPACES. SEE DWG FOR DETAILS.
- PAYMENT FOR ALL ELEMENTS ASSOCIATED WITH WORK ZONE TRAFFIC CONTROL SHALL BE INCLUDED UNDER 'ITEM 64LIOOO - TRAFFIC CONTROL', UNLESS OTHERWISE NOTED ON THE PLANS.

### PEDESTRIAN TEMPORARY TRAFFIC CONTROL NOTES

- I. THE CONTRACTOR SHALL PROVIDE A TEMPORARY PEDESTRIAN ACCESS ROUTE (TPAR) FOR REVIEW AND WRITTEN APPROVAL BY THE RESIDENT ENDINEER A MINIMUM OF THREE WEEKS BEFORE SUCH PLAN IS IMPLEMENTED. THIS PLAN SHALL DETAIL THE CONSTRUCTION PHASING AND SCHEDULE AND THE SPECIFIC METHODS OF MAINTAINING SAFE PEDESTRIAN ACCESS THROUGHOUT THE CONSTRUCTION AREA. THIS PLAN SHALL PROVIDE THE LOCATION AND DETAILS OF TEMPORARY CONSTRUCTION SIGNING, MARKINGS, BARRICADES, CHANNELIZING DEVICES, TPARS AND METHODS TO MAINTAIN ACCESS TO ADJACENT PROPERTIES, BUSINESSES, RESIDENCES, ETC.
- THE CONTRACTOR SHALL MAINTAIN PEDESTRIAN THROUGH MOVEMENTS FROM ONE END OF THE
  CONSTRUCTION AREA TO THE OTHER, ON AT LEAST ONE SIDE OF THE STREET DURING CONSTRUCTION,
  ANY SIDEWALK CLOSURES SHALL MEET THE REQUIREMENTS OF THE MANUAL ON UNIFORM TRAFFIC
  CONTROL DEVICES (MUTCO), PART 6.
- PEDESTRIAN ACCESS SHALL BE PROVIDED TO ALL ADJACENT PROPERTIES, BUILDINGS, RESIDENCES, COMMERCIAL PROPERTIES AND TRANSIT STOPS. THIS MAY INCLUDE TEMPORARY WALKWAYS SPANNING THE CONSTRUCTION AREA.
- 4. IF SIDEWALKS ARE CLOSED, A TEMPORARY PEDESTRIAN ACCESS ROUTE (TPAR) SHALL BE PROVIDED ON THE SAME SIDE OF THE ROAD AS THE CLOSED SIDEWALK, IF POSSIBLE, SIGNS AND BARRICADES SHALL BE USED TO PROVIDE ADVANCE NOTICE OF THE CLOSURE AND THE ROUTE OF ANY PEDESTRIAN DETOURS. THE TPAR SHALL HAVE A MINIMUM UNOBSTRUCTED WIDTH OF 4 FEET, IF THE TPAR IS LESS THAN 5 FEET IN WIDTH, A 5 FOOT BY 5 FOOT PASSING SPACE MUST BE PROVIDED AT LEAST EVERY 200 FEET. THE SURFACE OF THE TPAR SHALL BE FIRM, STABLE AND SLIP-RESISTANT AND CONTINUOUS WITH A MINIMUM 80 INCHES OVERHEAD CLEARANCE FOR THE LENGTH OF THE TPAR, THE TPAR SHALL MAINTAIN THE SAME LEVEL OF ACCESSIBILITY AND DETECTABILITY AS THE FACILITY THAT IS BEING CLOSED. THE TPAR SHALL NOT LEAD PEDESTRIANS INTO CONFILICTS WITH VEHICLES, EQUIPMENT, OR CONSTRUCTION OPERATIONS.
- 5. WHEN TEMPORARY CROSSWALKS ARE UTILIZED FOR THE TPAR, TEMPORARY DETECTABLE WARNINGS SHALL BE PLACED AT EACH END OF THE TEMPORARY CROSSWALKS. THE TEMPORARY CROSSWALK SHALL BE DELINEATED WITH TEMPORARY PAYEMENT MARKINGS OR TAPE. THE MARKINGS SHALL BE PARALLEL 12-INCH-WIDE WHITE LINES PLACE 7 FEET ON CENTER APART. IT SHOULD BE NOTED THAT CURB PARKING SHALL BE PROHIBITED FOR AT LEAST 20 FEET IN ADVANCE OF MIDBLOCK CROSSWALKS. TEMPORARY CROSSWALK SIGNS SHALL BE PROVIDED FOR THE CROSSWALK.


- 6. IF THERE IS WORK OCCURRING OVER AN OPEN SIDEWALK, PROTECTIVE OVERHEAD COVERING MUST BE PROVIDED AS NECESSARY TO ENSURE PROTECTION FROM FALLING OBJECTS AND DRIPPING FROM OVERHEAD STRUCTURES, COVERED WALKWAYS SHOULD BE STURDILY CONSTRUCTED AND ADEQUATELY LIGHTED FOR NIGHTIME USE.
- 7. INDIVIDUAL CHANNELIZING DEVICES, TAPE, OR ROPE USED TO CONNECT INDIVIDUAL DEVICES AND OTHER DISCONTINUOUS BARRIERS AND DEVICES, PAVEMENT MARKINGS ARE NOT DETECTABLE BY PERSONS WITH VISUAL DISABILITIES. THESE MEASURES DO NOT PROVIDE ACCEPTABLÉ PATH CUIDANCE ON TEMPORARY OR RE-ALIGNED SIDEWALKS OR OTHER PEDESTRIAN FACILITIES. PEDESTRIAN CHANNELIZING DEVICES SHALL INCLUDE A CONTINUOUSLY DETECTABLE BOTTOM AND TOP EDGE THROUGHOUT THE LENGTH OF THE FACILITY SUCH THAT IT CAN BE FOLLOWED BY PEDESTRIANS USING LONG CANFS FOR GUIDANCE.
- 8. CHANNELIZING DEVICES ON BOTH SIDES OF THE TPAR SHALL INCLUDE A CONTINUOUS SOLID TOP
  AND BOTTOM RAILS. THE TOP EOGE OF THE TOP RAIL SHALL BE BETWEEN 32 INCHES AND 38 NCHES
  ABOVE THE CROUND LEVEL. THE BOTTOM RAIL SHALL BE AT LEAST 8 INCHES WIDE PER INTH EDITION MUTCD,
  WITH THE BOTTOM EDGE OF THE BOTTOM RAIL SURFACE NO HIGHER THAN 2 INCHES ABOVE THE GROUND.
- IF THE TPAR IS ADJACENT TO MOVING TRAFFIC, CONSTRUCTION OPERATIONS/EQUIPMENT, OR DROPOFFS, THEN CRASHWORTHY CHANNELIZING DEVICES THAT MEET THE REQUIREMENTS OF THE 18TH EDITION MUTCO SHALL BE USFD.
- THE CONTRACTOR SHALL NOT STORE OR PLACE ANY CONSTRUCTION MATERIALS, EQUIPMENT OR SIGNS IN THE PEDESTRIAN PATH OF TRAVEL.
- PROVISION OF THE TPAR AND ALL ITS ELEMENTS, INCLUDING BUT NOT LIMITED TO SIGNS, CHANNELIZING DEVICES, BARRICADES, TEMPORARY CURB RAMPS, TEMPORARY PAVEMENT MARKINGS AND OTHER TRAFFIC CONTROL DEVICES IS TO BE PAID FOR INCIDENTAL TO TRAFFIC CONTROL (ITEM 641,1000).
- 12. THE CONTRACTOR SHALL REVIEW AND USE THE "VERMONT BICYCLE AND PEDESTRIAN WORK ZONE TRAFFIC CONTROL GUIDE", AVAILABLE ON YTRANS WEBSITE TO DESIGN AND IMPLEMENT TRAFFIC CONTROL FOR BICYCLE AND PEDESTRIAN INTO THEIR SITE-SPECIFIC TRAFFIC CONTROL PLAN FOR ALL STAGES OF CONSTRUCTION.




PROJECT NAME: NORTHFIELD
PROJECT NUMBER: BF 024I(58)

FILE NAME: zi9J223+rafficNotes.dgo PROJECT LEADER: K. SMITH DESIGNED BY: K. HO TRAFFIC CONTROL NOTES

PLOT DATE: 5/29/2025
DRAWN BY: T, MAROUETTE
CHECKED BY: C, JENNE
SHEET 17 OF 102

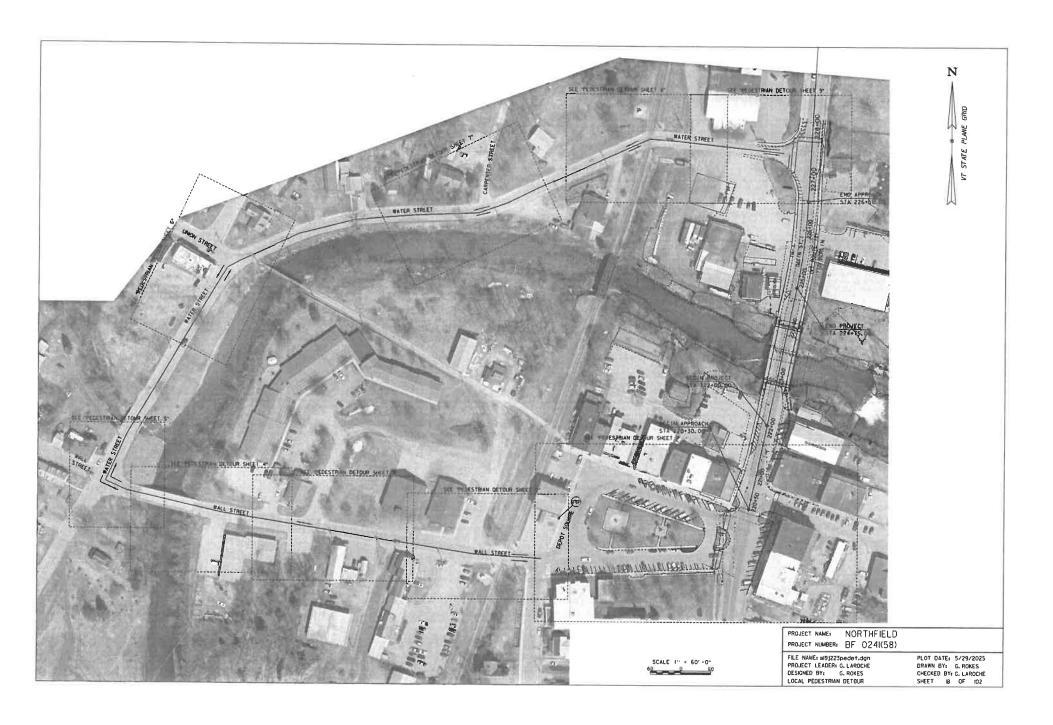

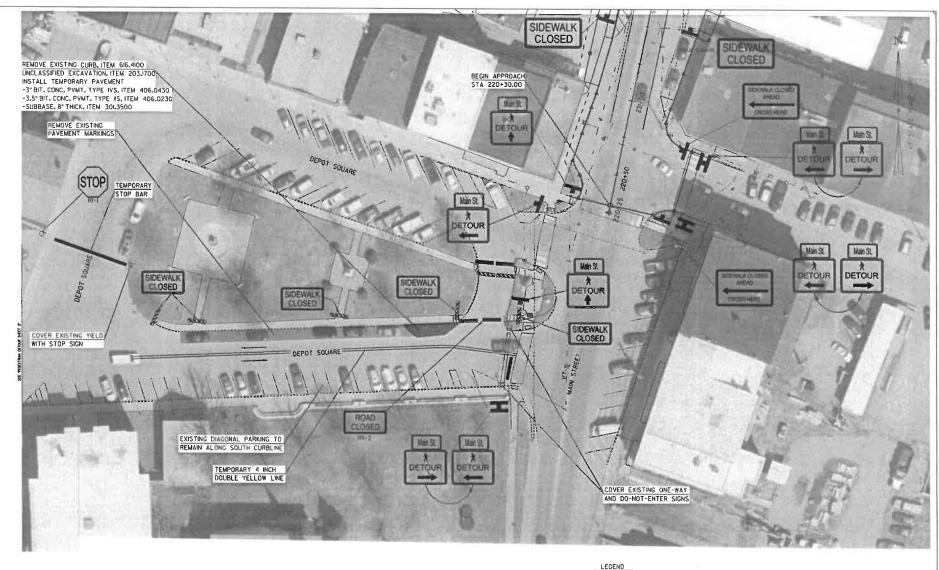

### NOTES:

- PLACEMENT OF THE DEVICES SHOWN ON THIS SHEET ARE REFERENCED FROM "VERMONT BICYCLE AND PEDESTRIAN WORK ZONE TRAFFIC CONTROL GUIDE".
- SIDEWALK AND DRIVEWAY ACCESS TO COMMERCIAL BUSINESSES SHALL BE MAINTAINED AT ALL TIMES.
- ANY AREAS IMPACTED BY CONSTRUCTION SHALL BE RESTORED IN KIND TO PRE-CONSTRUCTION CONDITIONS PRIOR TO PROJECT COMPLETION.


### NOTE: SEE TPAR NOTES SHEET


SCALE I" = 20'-0"


PEDESTRIAN DETOUR SIGN (TEMP)
PEDESTRIAN DETOUR SIGN (TEMP)
(BACK TO BACK)
LONGITUDINAL CHANNELIZING DEVICE (PCD)
SSSS PEDESTRIAN BARRICADE (TYPE II) (PCD)
DETECTABLE WARNING SURFACE (TEMP)

PROJECT NAME: NORTHFIELD PROJECT NUMBER: BF 0241(58)

FILE NAME: s19 J223 pedet.dgn PROJECT LEADER: G. LAROCHE DESIGNED BY: C. ROKES LOCAL PEDESTRIAN DETOUR SHEET 1 PLOT DATE: 5/29/2025 DRAWN BY: G. ROKES CHECKED BY: G. LAROCHE SHEET 19 OF 102

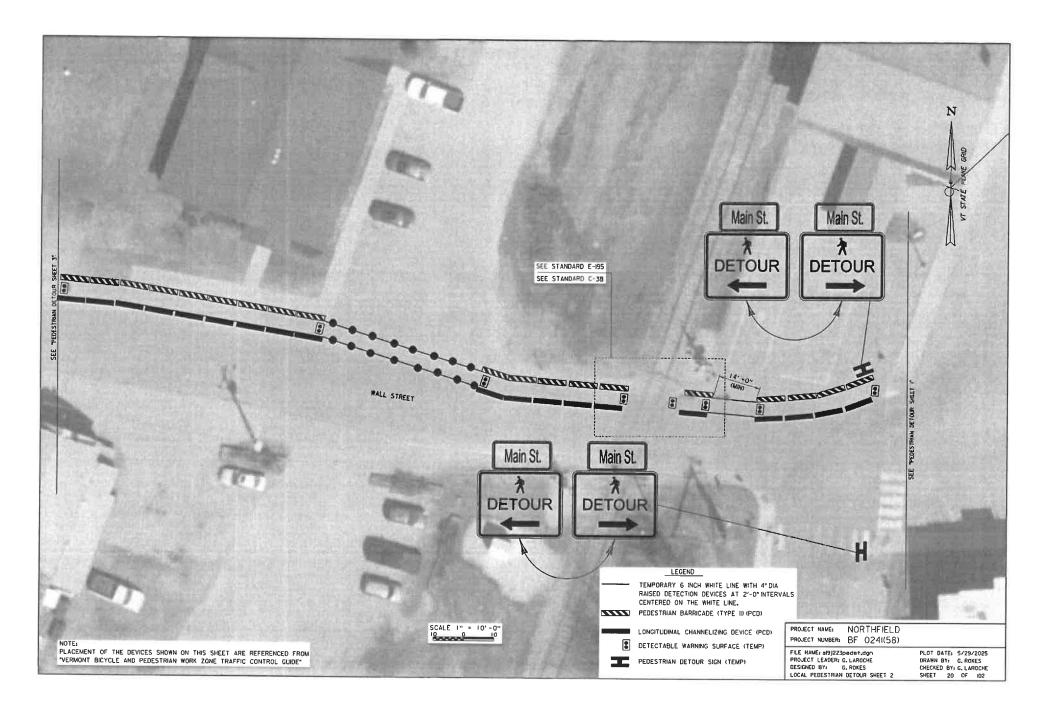

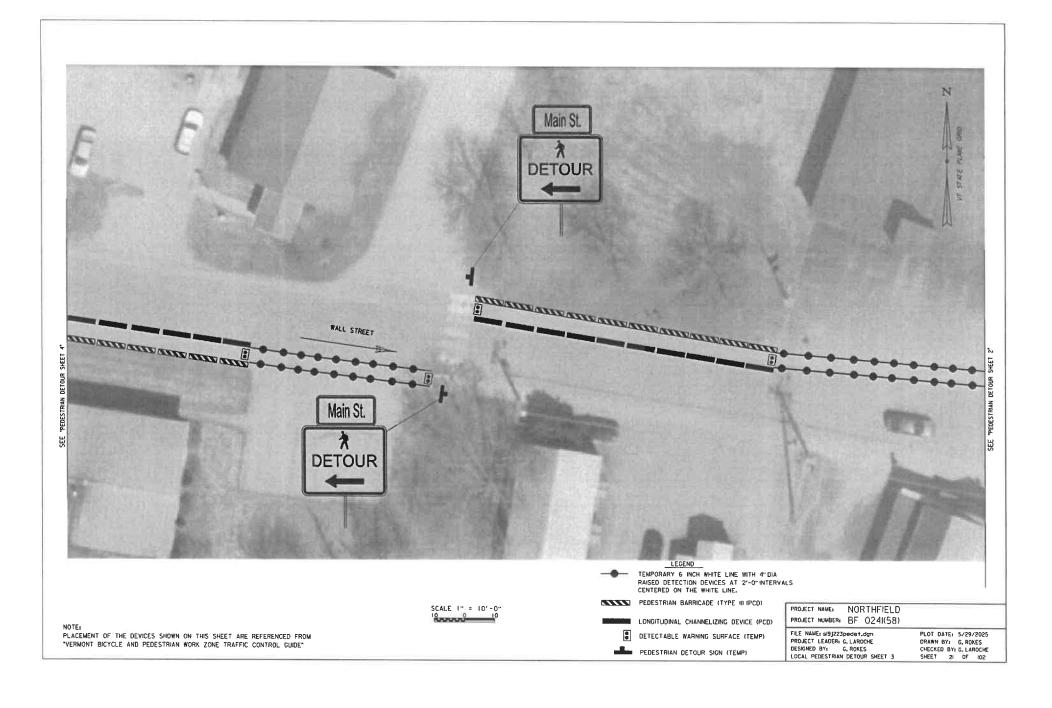

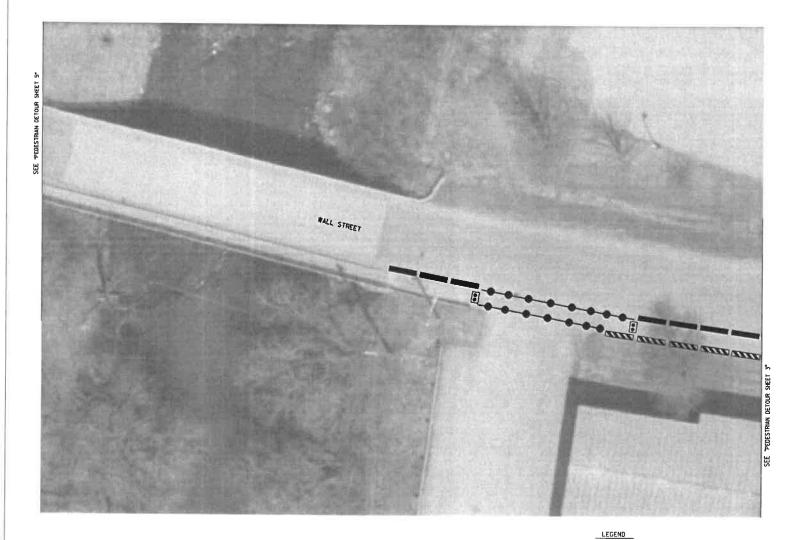

CENTERED ON THE WHITE LINE.

PEDESTRIAN BARRICADE (TYPE II) (PCD)

LONGITUDINAL CHANNELIZING DEVICE (PCD)

TEMPORARY 6 INCH WHITE LINE WITH 4" DIA RAISED DETECTION DEVICES AT 2'-0" INTERVALS

DETECTABLE WARNING SURFACE (TEMP)


FILE NAME: 8/9/223padet.dgn PROJECT LEADER: G. LAROCHE DESIGNED BY: G. RDKES LOCAL PEDESTRIAN DETOUR SHEET 4


PROJECT NAME: NORTHFIELD PROJECT NUMBER: BF 0241(58)

PLOT DATE: 5/29/2025 DRAWN BY: G, ROKES CHECKED BY: G, LAROCHE SHEET 22 DF 102


PLACEMENT OF THE DEVICES SHOWN ON THIS SHEET ARE REFERENCED FROM "VERMONT BICYCLE AND PEDESTRIAN WORK ZONE TRAFFIC CONTROL GUIDE"


SCALE I" = 10'-0"

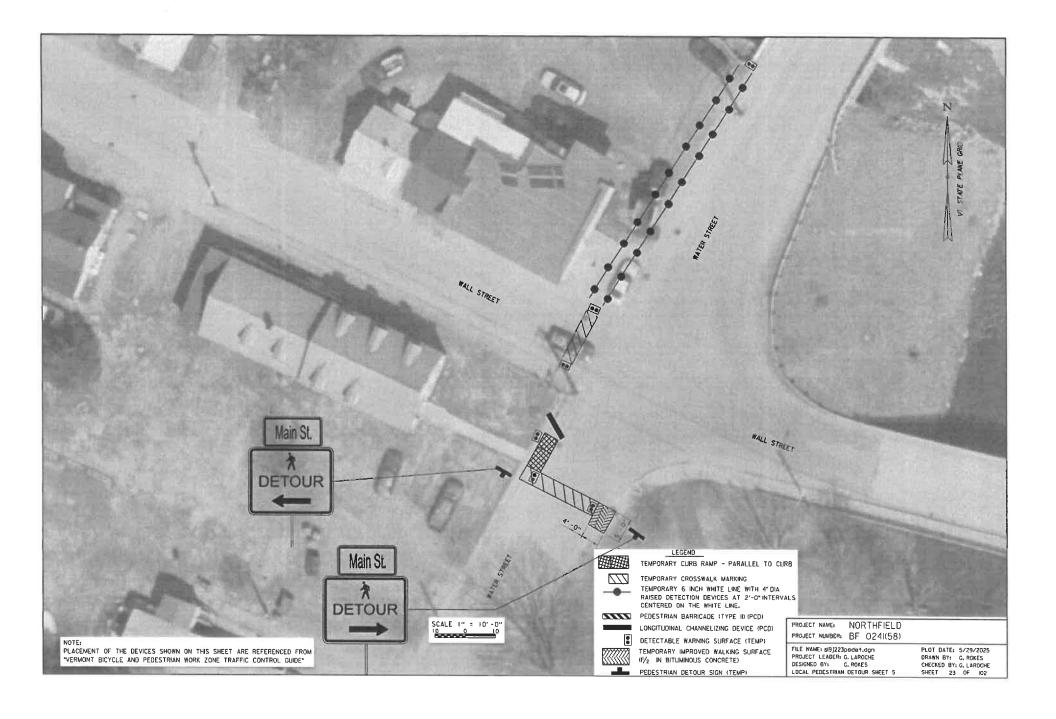


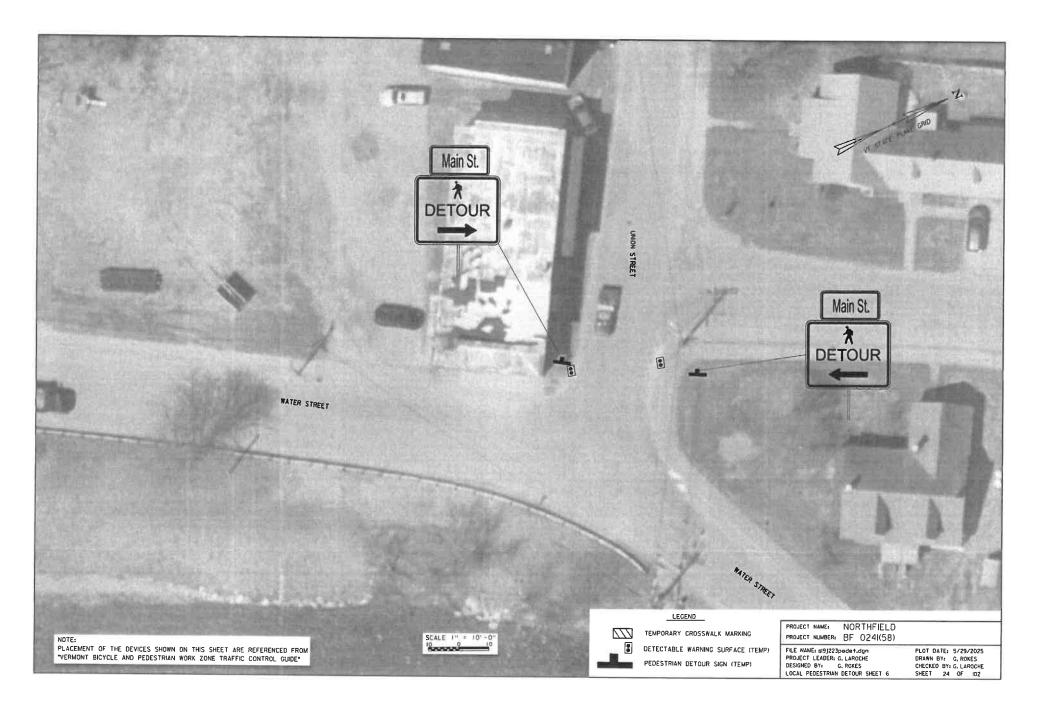




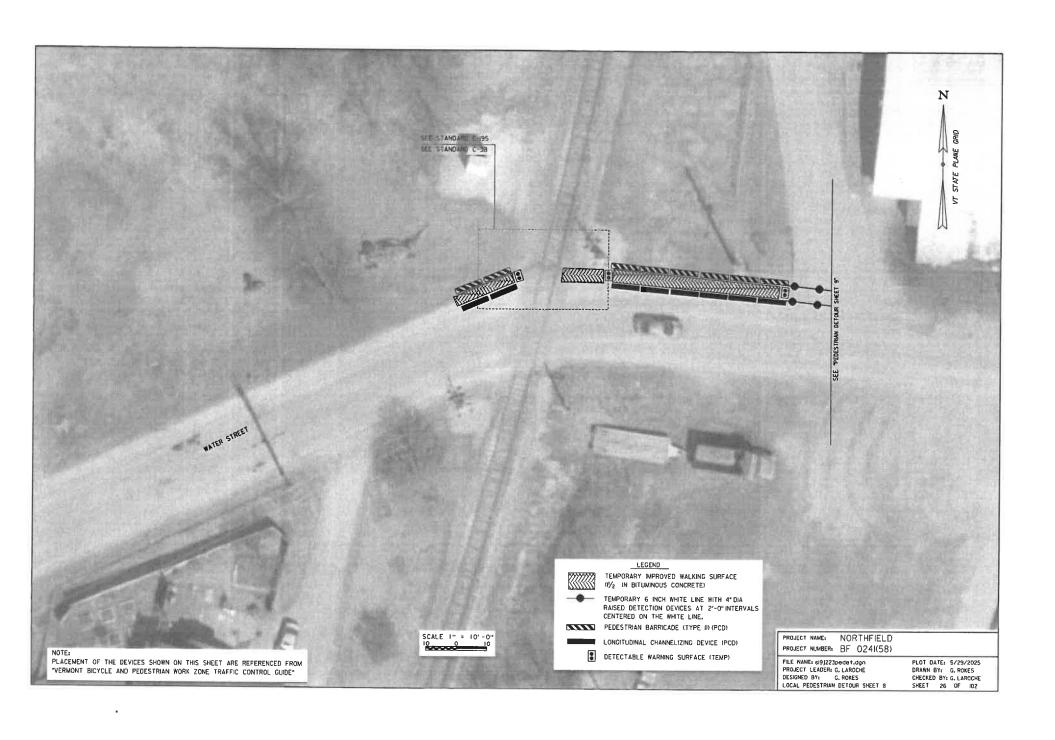

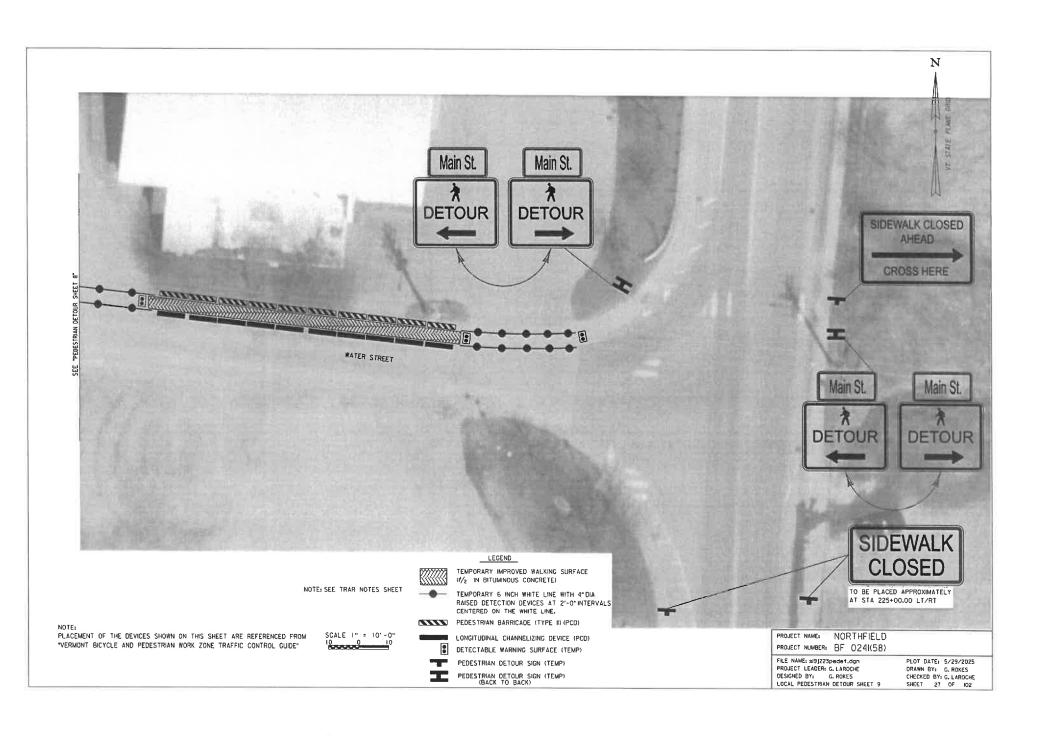

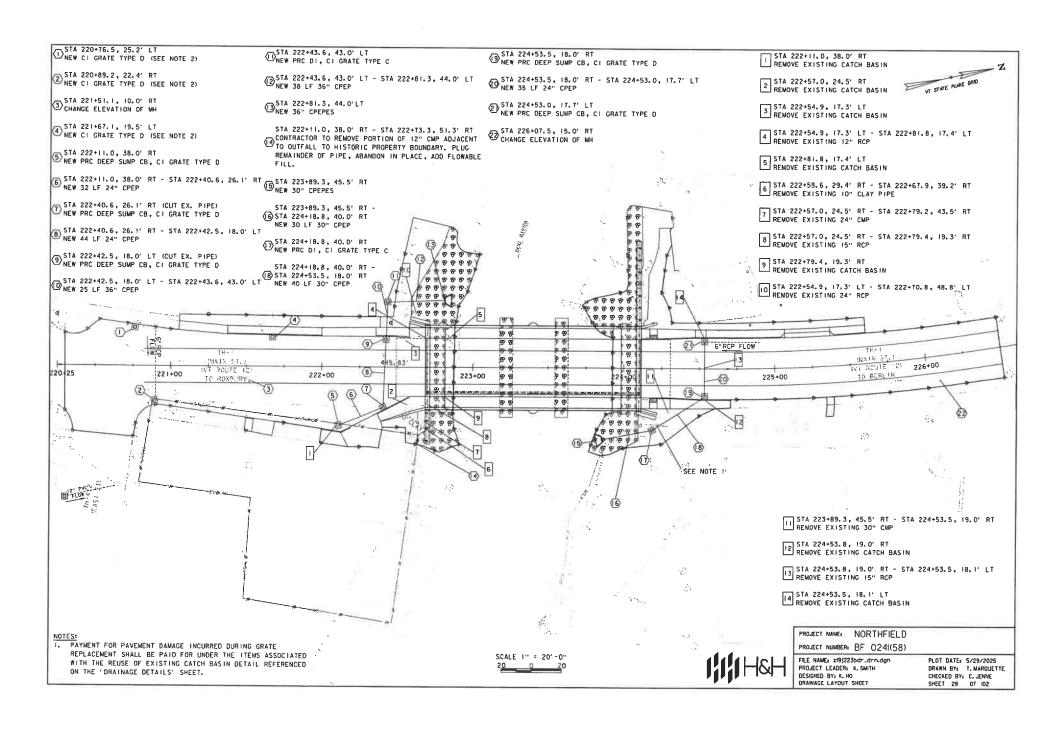


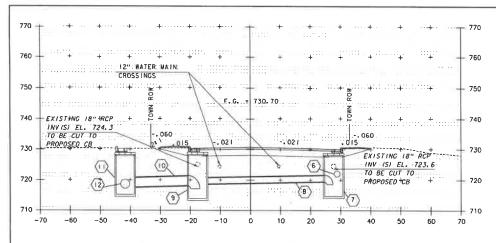

DRAINAGE PROFILE @ STA 222+40.6

- 6 STA 222+11.0, 38.0' RT STA 222+40.6, 26.1' RT NEW 32 LF 24" CPEP INLET EL 721.2 OUTLET EL 721.0
- T STA 222+40.6, 26.1' RT NEW PRC DEEP SUMP CB. CI GRATE TYPE D TOP OF GRATE EL 730. I SUMP EL 718.6
- 8 STA 222+40.6, 26.1' RT STA 222+42.5, 18.0' LT NEW 44 LF 24" CPEP INLET EL 719.4 OUTLET EL 718.7
- 9 STA 222+42.5, 18.0' LT NEW PRC DEEP SUMP CB, CI GRATE TYPE D TOP OF GRATE EL 730.3 SUMP EL 717.2

- (10) STA 222+42.5, 18.0' LT STA 222+43.6, 43.0' LT NEW 25 LF 36" CPEP INLET EL 718.21 OUTLET EL 717.7
- (II) STA 222+43.6, 43.0' LT NEW PRC DI. CI GRATE TYPE C TOP OF GRATE EL 730, 2 OUTLET EL 717.18
- (12) STA 222+43.6, 43.0' LT STA 222+81.3, 44.0' LT NEW 38 LF 36" CPEP INLET EL 717.18 **OUTLET EL 716.00**

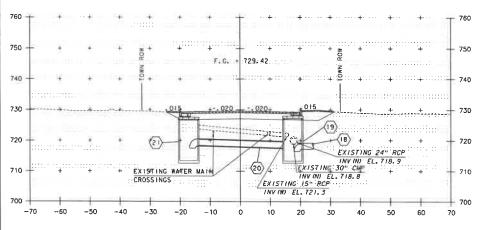

DRAINAGE PROFILE @ STA 224+53.5

- (8) STA 224+18.8, 40.0' RT STA 224+53.5, 18.0' RT NEW 40 LF 30" CPEP INLET EL 717.25 OUTLET EL 716.7 (SEE CHANNEL XS AT STA 51+10 FOR DI INFO)
- (19) STA 224+53.5, 18.0' RT NEW PRC DEEP SUMP CB. CI GRATE TYPE D TOP OF GRATE EL. 729.28 SUMP EL. 716.5
- (20) STA 224+53.5, 18.0' RT STA 224+53.0, 17.7' LT NEW 35 LF 24" CPEP INLET EL. 718.4 OUTLET EL. 717.6
- (21) STA 224+53.5. 17.7' LT NEW PRC DEEP SUMP CB. CI GRATE TYPE D TOP OF GRATE EL 728.81 SUMP EL 717.52


PROJECT NUMBER: BF 0241(58)

PROJECT NAME: NORTHFIELD


FILE NAME: z191223xs.dan

PROJECT LEADER: K. SMITH DESIGNED BY: K. HO DRAINAGE PROFILE

PLOT DATE: 5/29/2025 DRAWN BY: J. DIAZ CHECKED BY: C. JENNE SHEET 29 OF 102

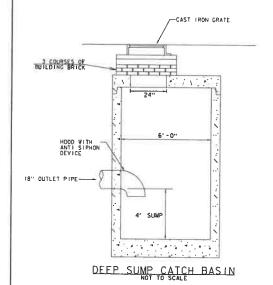

NOTE: WATERSTOP WITH PIPE GASKET, CAST IRON FRAME AND GRATES, MANHOLE RUNGS, HOOD WITH ANTI SIPHON DEVICE, ARE INCIDENTAL TO ITEM 604.2000 PRECAST REINFORCED CONCRETE CATCH BASIN WITH CAST IRON GRATE (DEEP SUMP)

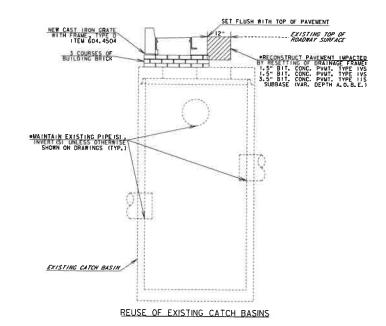

BOTTOM OF PAVEMENT BOX

SENSTING

ONCRETE TRASSMENT

DIA.

PROPOSED MILLITY
ON TREEPHORE

OF TELEPHORE

UNDERGROUND UTILITY CLEARANCE DIAGRAM


OL L E

PROJECT NAME: NORTHFIELD
PROJECT NUMBER: BF 0241(58)

FILE NAME: zi9j223drn_det.dgn PROJECT LEADER: K_SMITH DESIGNED BY: K. HO DRAINAGE DETAILS


PLOT DATE: 5/29/2025 DRAWN BY: J. DIAZ CHECKED BY: C. JENNE SHEET 30 OF 102


STATE OF VERMONT AGENCY OF TRANSPORTATION  DRAINAGE DETAIL SHEET  ***TATE OF VERMONT**  **TATE OF VERMONT**  ***TATE OF VERMONT**  ***TATE OF VERMONT**  **TATE OF VERMONT**  ***TATE OF VERMONT**  **TATE OF V															D	E	$\mathbf{T}_{I}$	Al		S	HI		: T	1																										
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PROJECT NAME: NORTHFIELD

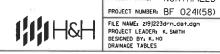PLOT DATE: 5/29/2025 DRAWN BY: J. DIAZ CHECKED BY: C. JENNE SHEET 31 OF 102



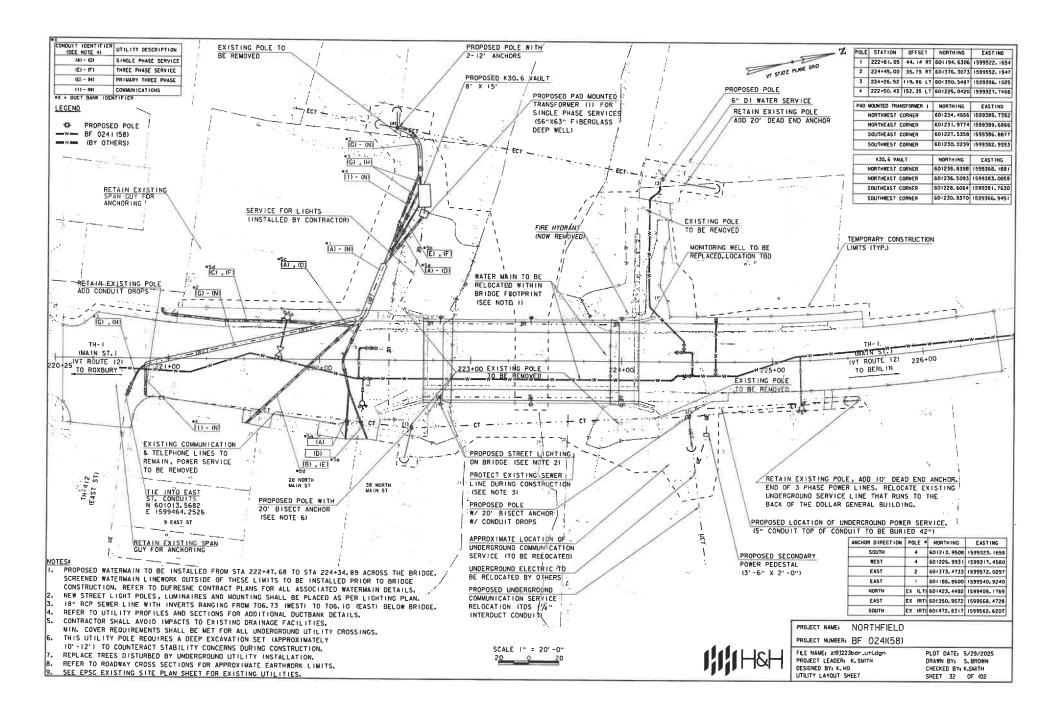

POWER, COMMS, AND POWER SERVICES DUCT BANK PROFILE

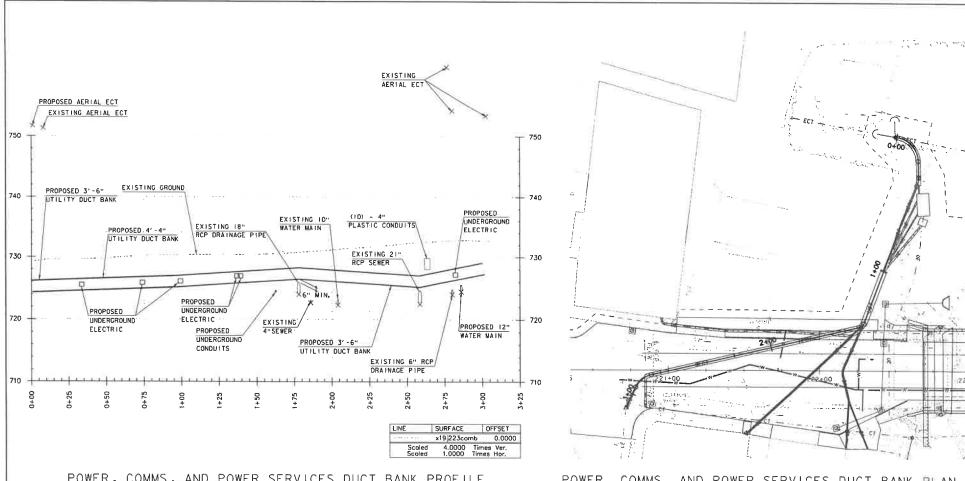POWER, COMMS, AND POWER SERVICES DUCT BANK PLAN



MOTES:

1. INVERTS SHOWN FOR EXISTING UTILITIES ARE ASSUMED BASED ON AVAILABLE INFORMATION. THE CONTRACTOR SHALL VERIFY THE POSITION OF ALL EXISTING UTILITIES.


2. PROPOSED UTILITY DUCT BANKS SHALL MAINTAIN 18" MINIMUM VERTICAL CLEARANCE FROM EXISTING UNDERGROUND UTILITIES UNLESS OTHERWISE SHOWN. LOCATIONS WITH LESS THAN 18" VERTICAL CLEARANCE HAVE BEEN AGREED UPON BETWEEN VTRANS, GMP, NED AND THE TOWN OF NORTHFIELD.




PROJECT NAME: NORTHFIELD PROJECT NUMBER: BF 0241(58)

FILE NAME: zi9)223utl_pro.dgn PROJECT LEADER: K. SMITH

PLOT DATE: 5/29/2025 DRAWN BY: J. DIAZ DESIGNED BY: K. HO UTILITY DUCT BANK PLAN & PROFILE - I CHECKED BY: C. JENNE SHEET 33 DF 102

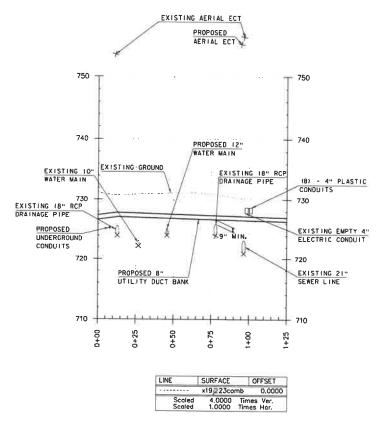

2 - 4" POWER SERVICE DUCT BANK PROFILE

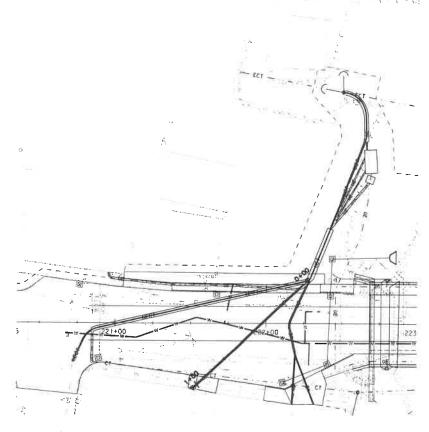

I - 4" POWER SERVICE DUCT BANK PLAN

SCALE 1" = 20'-0"


NOTES: 1. INVERTS SHOWN FOR EXISTING UTILITIES ARE ASSUMED BASED ON AVAILABLE INFORMATION. THE CONTRACTOR SHALL VERIFY THE POSITION OF ALL EXISTING UTILITIES.

2. PROPOSED UTILITY DUCT BANKS SHALL MAINTAIN 18" MINIMUM VERTICAL CLEARANCE FROM EXISTING UNDERGROUND UTILITIES UNLESS OTHERWISES SHOWN. LOCATIONS WITH LESS THAN 18" VERTICAL CLEARANCE HAVE BEEN AGREED UPON BETWEEN VIRANS, GMP, NED AND THE TOWN OF NORTHFIELD.




PROJECT NAME: NORTHFIELD PROJECT NUMBER: BF 0241(58)

FILE NAME: zi9j223utl.pro.dgn PROJECT LEADER: K. SMITH DESIGNED BY: K. HO UTILITY DUCT BANK PLAN & PROFILE - 2 PLOT DATE: 5/29/2025 DRAWN BY: J. DIAZ CHECKED BY: C. JENNE SHEET 34 OF 102

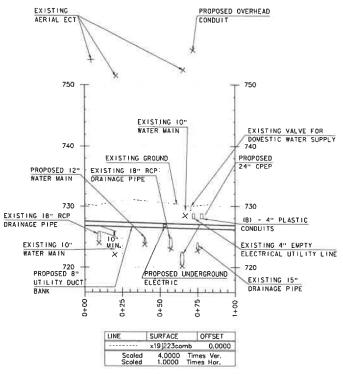

2 - 4" POWER SERVICES DUCT BANK PROFILE

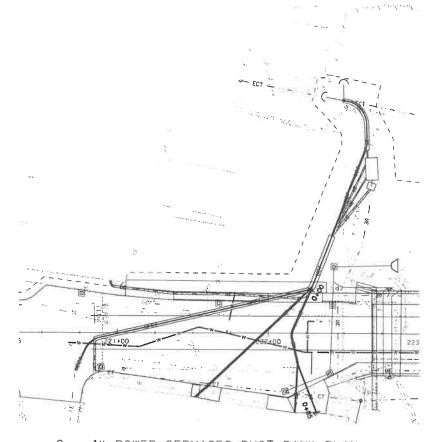

2 - 4" POWER SERVICES DUCT BANK PLAN



NOTES:

1. INVERTS SHOWN FOR EXISTING UTILITIES ARE ASSUMED BASED ON AVAILABLE INFORMATION. THE CONTRACTOR SHALL VERIFY THE POSITION OF ALL EXISTING UTILITIES.


2. PROPOSED UTILITY DUCT BANKS SHALL NAINTAIN 18" MINIMUM VERTICAL CLEARANCE FROM EXISTING UNDERGROUND UTILITIES UNLESS OTHERWISES SHOWN, LOCATIONS WITH LESS THAN 18" VERTICAL CLEARANCE HAVE BEEN AGREED UPON BETWEEN VIRANS, GMP, NED AND THE TOWN OF NORTHFIELD.





PROJECT NAME: NORTHFIELD
PROJECT NUMBER: BF 0241(58)


FILE NAME: z/9/223u+1.pro.dgn
PROJECT LEADER: K. SMITH
DESIGNED BY: K. HO
UTILITY DUCT BANK PLAN & PROFILE - 3

PLOT DATE: 5/29/2025
DRAWN BY: J. DIAZ
CHECKED BY: C. JENNE
SHEET 35 OF 102

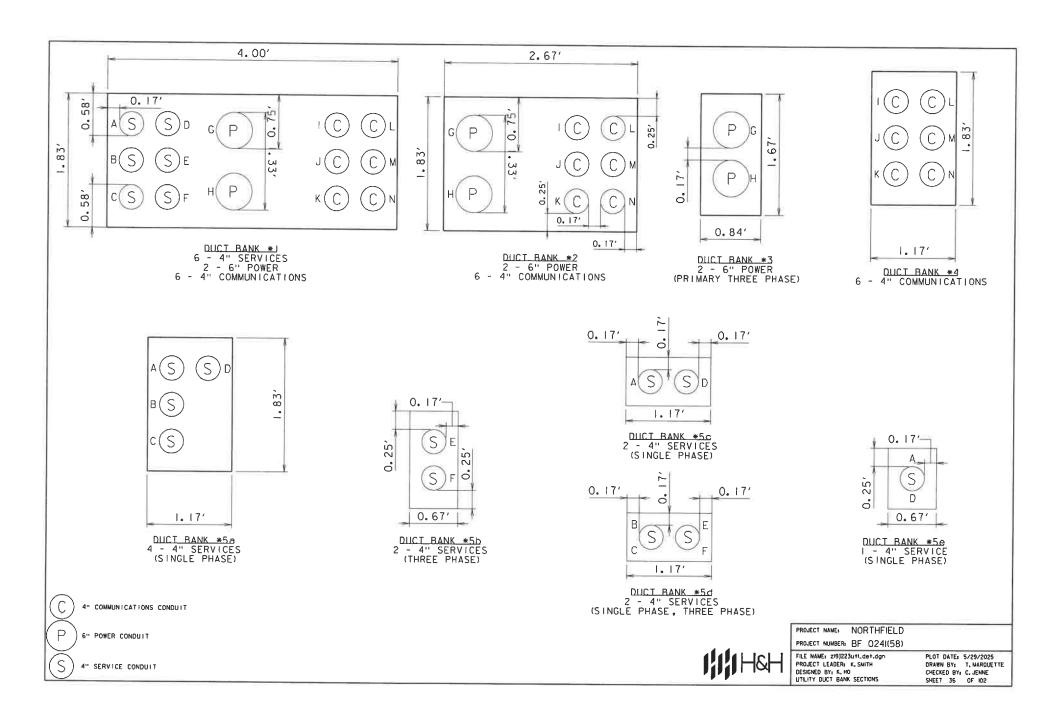

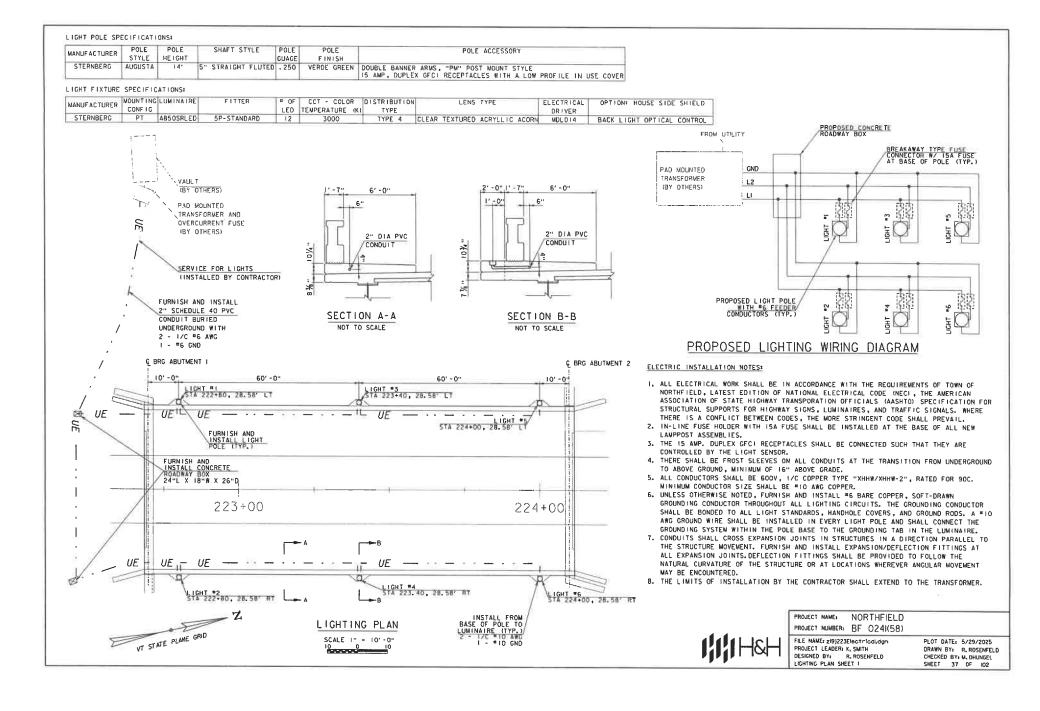


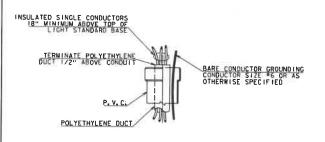

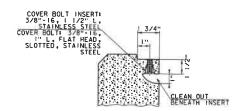


# CABLE IN DUCT TERMINATION AT LIGHT STANDARD BASE


THREADED INSERT

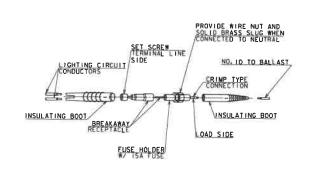


BREAKAWAY FUSE CONNECTOR

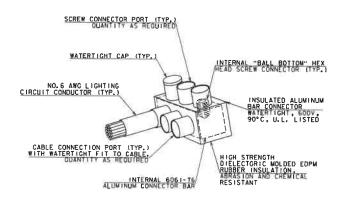

WATERTIGHT CONNECTOR

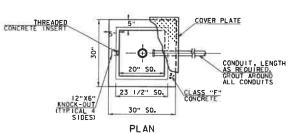

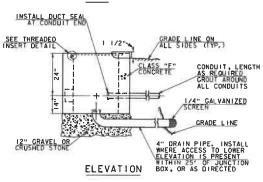


CONCRETE JUNCTION BOX




PROJECT NAME: NORTHFIELD
PROJECT NUMBER: BF 024I(58)

FILE NAME: zi9]223Electrical.dgm PROJECT LEADER: K. SMITH DESIGNED BY: R. ROSENFELD LIGHTING PLAN SHEET 2 PLOT DATE: 5/29/2025 DRAWN BY: R. ROSENFELD CHECKED BY: M. DHUNGEL SHEET 3B OF 102

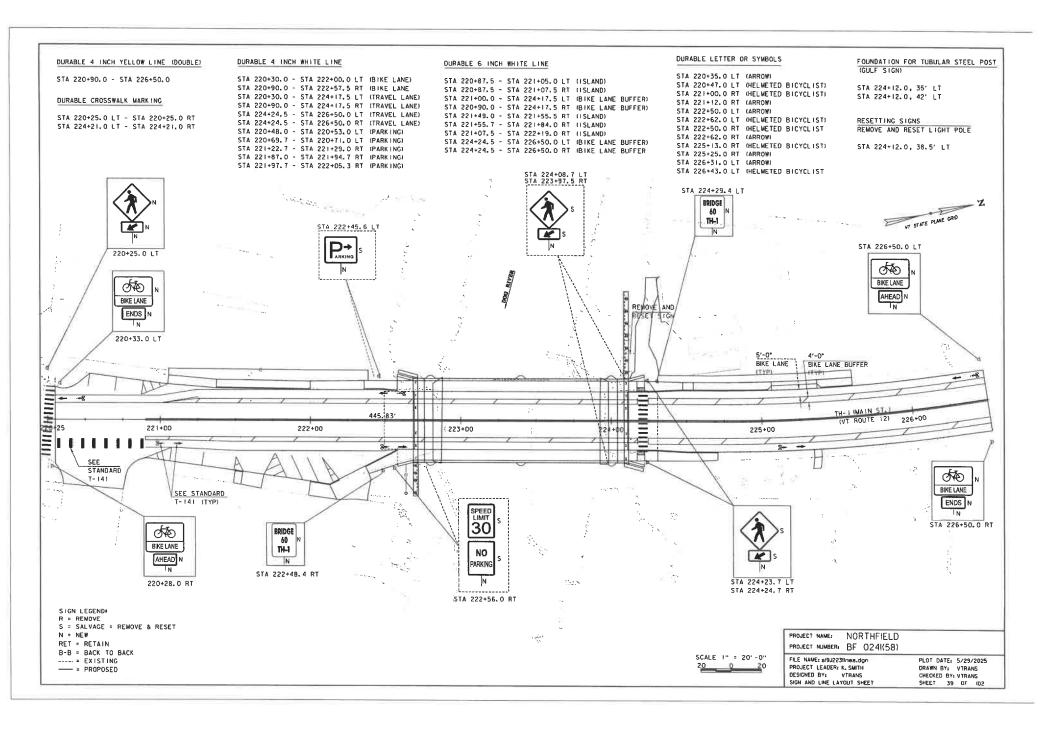


## **BLOCK PATTERN CROSWALK PAVEMENT MARKING DETAILS**

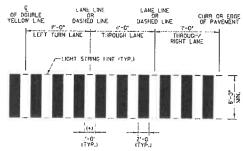

BLOCK PATTERN CROSSWALK DETAIL
MAY VARY WITH 31-0" OR 121-0" LANE

s

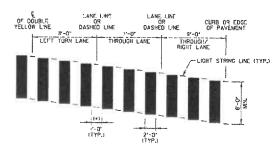

## SKEWED BLOCK PATTERN CROSSWALK DETAIL MAY VARY WITH 11-0" OR 121-0" LANE.

### NOTES

- 1. THIS DETAIL IS CONFIGURED FOR AN ''-O' LANE.
- 2. MARK LIGHT STRING LINE ON PAVEMENT ACROSS ROADWAY (CURB-TO-CURB).
- 3. ESTABLISH THE CENTER LINE OF THE ROADWAY (DOUBLE YELLOW LINE OR LANE LINE).
- BLOCKS ARE PARALLEL TO THE CENTERLINE (DOUBLE YELLOW LINE OR LANE LINE), IOCESET BLOCKS VERTICALLY TO ACHIEVE REQUIRED SKEW!
- 5. ALWAYS START MEASURING FROM THE CENTEPLINE OR LANE LINE RIGHT WITH THE FLOW OF TRAFFIC.
- 6. PAINTED BLOCKS SHALL BE 2'-0" (TYPICAL), (OPTION ITEM)
- (*) 7. THIS SPACING WILL INCREASE TO 2'-0" FOR A 12'-0" LANE.
- (+) 8. ADJUST SPACING TO AVOID WHEEL PATHS AS DIRECTED BY THE ENGINEER.

PROJECT NAME: NORTHFIELD PROJECT NUMBER: BF 0241(58)

FILE NAME: 619J223,DGN
PROJECT LEADER: C. BAKER
DESIGNED BY: VTRANS
CROSSWALK DETAILS

PLOT DATE: 5/29/2025 DRAWN BY: VTRANS CHECKED BY: VTRANS SHEET 40 OF ID2

	OF VERMONT TRANSPORTATION							T	F	RA	F		CS	SI	GI	N	S	Uľ	ΝN	A A	۱R	Y	S	H	El	ΞΤ							
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ILE MARKER, ATION OR SIGN NUMBER	SKON LEGEND	EACH	MDTH (In)	HE IOH(	*A*	-e- {	BALV SA	RETAIN	SALVAGE	1 POST	(LB/I	÷		LB/FT)	3.35		SLEEVE	(LB /	FTI	FOUNDATION	7.60	3.50 (LB	4.00 (FT) 10.80		FTG. 6125	Heli	POGTSIZE	SIGN FRAME	REGUINED	REMARKS		DETAIL ON SHEET NUMBER	OR FHA
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STA 220+25.0 LT			24,0	12,0	2,0				T	Ť						P	PAIRED	WITH NEW	/W11-2 8K	IN LISTE	DABOVE	E				-!							
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STA 222+56.0 RT	SPEED LIMIT 30	1	24,0	30.0	5.0					1.0				12.0		x														BLACK ON WH	ITÉ		Muti R2-
STA 222+56.0 RT	NO PARKING	1	24.0	30.0	5.0							-				PA	AIRED V	WITH EXIST	TNG R2-1 S	GNLIST	ED ABOV	VE								RED ON WHAT	TE .		MUTI R8+3
222+48.4 RT	BRIDGE	1	6.0	10.0	0.4					1.0				12.0		x												T		WHITE DN GRE	EEN	T-42	
224+29,4 LT	60 TH-1	1	6.0	10.0	0.4					1,0				12.0		x														WHITE ON GRE	EEN	T-42	
OST SIZES ARE COMP	ARE TO BE DETERMINED IN THE FIELD, PUTEO BASED ON INFORMATION FANDARD SHEETS AND THE VTRANS JUDIE INFE										-		РТ	FT 87.	F		EA .	LB U			LB	LB	LB	LB									
CIGIT FOOT DEGICAL OF	or to the first the second		TOTAL	.s	SF 48.83	SF .	EA.	SF .			F		F		FT 87.		-	Ų	3	EA.		1	b	$\exists$	EA. E	A. LB							


SIGN LEGEND:
R = REMOVE
S = SALVAGE = REMOVE & RESET
N = NEW
RET = RETAIN
B-B = BACK TO BACK
----- EXISTING
---- = PROPOSED


PROJECT NUMBER: BF 0241(58)

FILE NAME: 20)2236gn.dgn
PROJECT LEADER: K. SMITH
DESKINGED BY K. HO
SIGN AND LINE TABLE SHEET

PROJECT NAME: NORTHFIELD

PLOT DATE: 5/29/2025 DRAWN BY: 5. TANG CHECKED BY: C. JENNE SHEET 41 DF 102

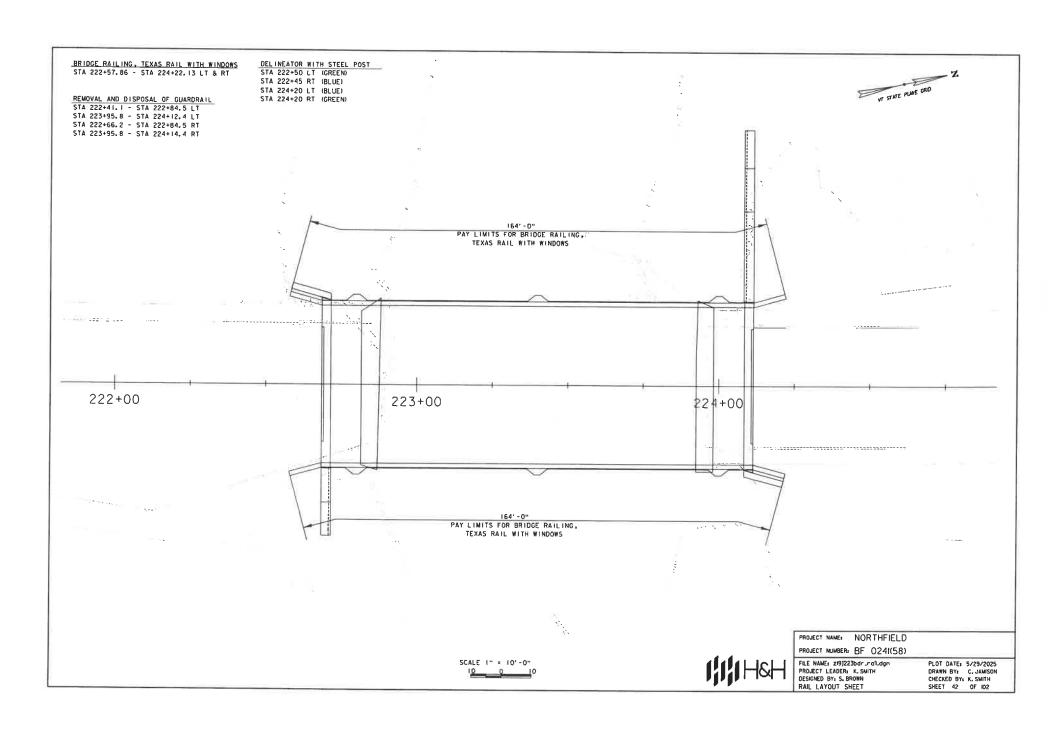

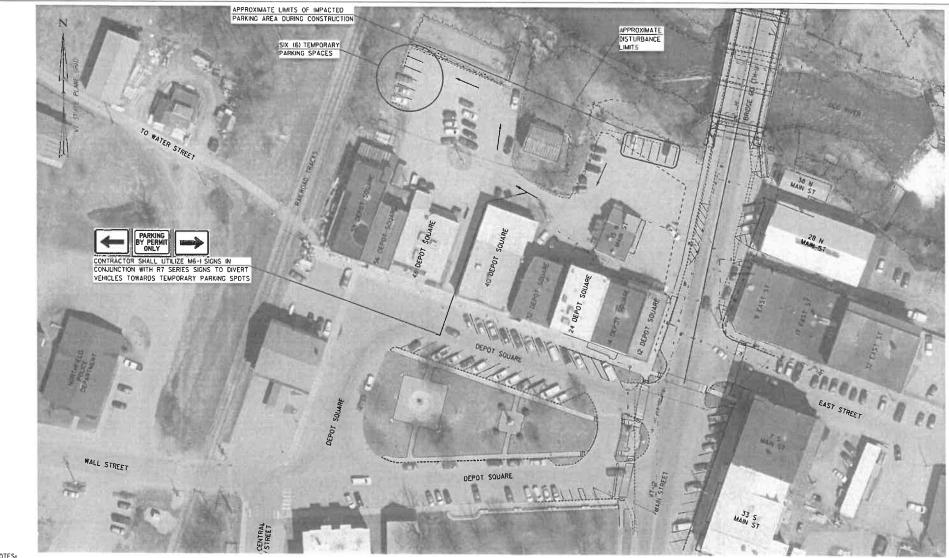

NOTES:

1. TEMPORARY PARKING LAYOUT SHALL BE IN PLACE FOR DURATION OF WORK ASSOCIATED WITH UTILITIES RELOCATION AND BRIDGE REPLACEMENT.

2. LAYOUT OF SIGNAGE AND PERMIT PARKING AS SHOWN IS SCHEMATIC AND SHALL BE COORDINATED WITH THE TOWN OF NORTHFIELD.

3. COSTS FOR TEMPORARY SIGNING AND STRIPING AS SHOWN SHALL BE INCLUDED UNDER PAY ITEM 641,1000 - TRAFFIC CONTROL.

SCALE 1" = 30' -0"

PROJECT NAME: NORTHFIELD PROJECT NUMBER: BF 0241(58)

FILE NAME: si9]223†parking.dgn PROJECT LEADER: K. SMITH DESIGNED BY: K. HO TEMPORARY PARKING LAYOUT

PLOT DATE: 5/29/2025 DRAWN BY: J. DIAZ CHECKED BY: C. JENNE SHEET 43 DF 102

### SOIL CLASSIFICATION

### AASHTO

Al Grovel and Sand
As Fine Sand
As Fine Sand
As Sity or Clayey Grovel and Sand
As Sity Soil - Low Compressibility
As Sity Soil - Highly Compressibile
Clayey Soil - Lighty Compressible
Clayey Soil - Lighty Compressible

### ROCK QUALITY DESIGNATION

R.O.D. (2)	ROCK DESCRIPTION
<25	Very Poor
25 to 50	Poor
51 to 75	Fair
76 to 90	Good
>90	Excellent

### SHEAR STRENGTH

UNDRAINED SHEAR STRENGTH	
IN P.S.F.	CONSISTENCY
<250	Very Soft
250-500	Soft
500-1000	Med, Stiff
1000-2000	Stiff
2000-4000	Very Stiff
>4000	Hond

### CORRELATION GUIDE OF "N" TO DENSITY/CONSISTENCY

	DENSITY LILAR SOILSI		NSISTENCY ESIVE SOILS)
N	DESCRIPTIVE TERM	_N_	DESCRIPTIVE TERM
<5 5-10	Very Loose	<2 2-4	Very Soft
11-24	Med. Dense	5-8	Med. Stiff
25-50	Dense Very Dense	9-15 16-30	Stiff Very Stiff
750	vor y bando	31-60	Hard
		>60	Very Hard

### COMMONI V. LISED SYMBOLS

▼	Water Elevation
69	Standard Penetration Boring
0	Auger Boring
0	Rod Sounding
S	Sample
N	Standard Penetration Test
	Blow Count Per Foot Fors
	2" O. D. Sampler
	1% I.D. Sampler
	Hammer Weight Of 140 Lbs.
.11	Hammer Fall Df 30"
٧S	Fleid Vane Shear Test
US	Undisturbed Soil Sample
В	Blast
DC	Dlamond Core
MD	Mud Drill
WA	Wash Ahead
HSA	Hollow Stem Auger
AX	Core Size 1/6"
BX	Core Size 1%"
NX	Core Size 2 1/8"
M	Double Tube Core Bornel Used
LL	Liquid Limit
PL	Plastic Limit
PI	Plasticity index
NP	Non Plastic
w	Moisture Content (Dry Wgt. Bosis)
D	Dry
M	Moist
MTW	Moist To Wet
w.	Wet
Sat	Saturated
Во	Boulder
Gr	Gravel
So	Sond
SI	SII+
CI	Cloy
HP	Hardpan
Le	Ledge
NLTD	No Ledge To Depth
CNPF	Can Not Penetrate Further
TLOB	Top of Ledge Or Boulder
NR	No Recovery
Rec.	Recovery
XRec.	Percent Recovery
ROD CBR	Rock Quality Designation
	California Bearing Ratio
5	Less Than
2	Greater Than

bik	Black	pnk	Plok
ы	Blue	pu	Pumple
brn	Brown	rd	Red
dk	Dark	tn	Tan
gry	Gray	wh	White
an .	Green	yel	Yellow
Ĭ†	Light	mitc	Multicolored
or	Orange		

_C	OMMONLY USED SYMBOLS
♥ • • • • • •	Water Elevation Standard Penetration Boring Auger Boring Rod Sounding Sample
N	Standard Penetration Test Blow Count Per Foot For: 2°0.D. Sampler 1¾°1.D. Sampler Hammer Weight Of 140 Lbs. Hammer Fail Of 30°
٧5	Fleid Vane Shear Test
US	Undisturbed Soil Sample
B DC	Blast
MD	Diamond Core Mud Drill
WA	Wash Ahead
HSA	Hollow Coom Access
ΔX	Core Size (1/e*
BX	
NX M	Core Size 2 1/8"
ĽL	Double Tube Core Borrel Used Liquid Limit
PL	Pigstic Limit
Ρĺ	Plasticity Index
ΝP	Non Plastic
w D	Moisture Content (Dry Wgt. Basis)
M	Ory Moist
MTW	Moist To Wet
w	Wet
Sat	Saturated
Во	Boulder
Gr So	Grovel Sand
SI	SII+
Či	Cloy
HP	Hardpan
Le	Ledge
NLTD	No Ledge To Depth
CNPF	Can Not Penetrate Further Top of Ledge Or Boulder
NR	No Recovery
Rec.	Recovery
%Rec.	Percent Recovery
ROD	Rock Quality Designation
CBR	California Bearing Ratio
\$	Less Than
,	Greater Thon

Refusal (N. > 100) VTSPG NAD83 - See Note 7

		JULUH	
bik	Black	pnk	Plok
ы	Blue	DU	Purple
brn	Brown	rd	Red
dk	Dark	tn	Tan
gry	Gray	wh	White
an .	Green	yel	Yellow
ĬŤ.	Light	mitc	Multicolored

	1/4	nn (1)		
			Name of the Park	VI STATE POINT CHO
	B-101A B-102 H-101MH-111 B-102		8-104MW 8-104	
222+00 H- 102- <b>9</b> 0	B-103C)	1 ¹ 1 ¹	241+00 8-105 QH-104	225+00
7				
20 0 20 SCALE: 1" = 20'-0"			BORING CHART	

HOLE NO.	NORTHING	EASTING	STATION	OFFSET	ELEV TLOB
B-101	601218,43	1599459.36	222+71,29	22.2' LT	
B-10IA	601222.65	1599458.73	222+75.29	23.7' LT	
B-102	601213.45	1599480.83	222+70.87	0.2' LT	698.5
B-103	601208.44	1599492,27	222+68.35	12.0' RT	700.3
B-104	601364.21	1599483.86	224+18.98	28.5° L T	701.6
B-104MW	601365.53	1599480.06	224+19.48	32.5' LT	
B-I05	601352.94	1599511,91	224+13.78	L2' RT	704.7
B-106	601347,71	1599537.30	224+13.93	27.2' RT	706.0

HOLE NO.	NORTHING	EASTING	STATION	OFFSET
H-101	601215,68	1599468.47	222+70.49	12.8' LT
H-IOIMW	601213.73	1599468.06	222+68.49	12.8' LT
H-I02	50161.44	1599480.88	222+20.01	IO.6' RT
H-103	601373.36	1599498.83	224+31.03	15.8' LT
H-104	601363.07	1599529.46	224+27.33	16.3' RT

### DEFINITIONS (AASHTO)

BEDROCK (LEDGE) - Rock in its notive location of indefinite thickness. BOULDER - A rock fragment with an overage dimension > 12 inches. COBBLE - Rock fragments with an average dimension between 3 and 12 inches.

GRAVEL - Rounded particles of rock < 3" and > 0.0787" (*i0 sleve).

SAND - Particles of rock ( 0,0187° (*10 sieve) and > 0,0029° (*200 sieve). SILT - Soli ( 0,0029" ("200 sleve), non or slightly plastic and exhibits no strength when air-dried.

CLAY - Fine grained soil, exhibits plasticity when moist and consider oble strength when dir-dried.

VARVED - Alternate layers of slit and clay.

HARDPAN - Extremely dense soil, cemented layer, not softened when wet,

WIGH WOT.

NUCK - Soft- organic soil (containing
) 10% organic material.

MOISTURE CONTENT - Weight of water
divided by dry weight of soil.

FLOWING SAND - Granular soil so sofunded (loose) that it flows into drill casing during extraction of wash rod.

STRIKE - Angle from magnetic north to line of intersection of bed with a horizontal plane. DIP - inclination of bed with a harizontal plane.

The subsurface explorations shown herein were made between 9/20/2021 and 9/28/2021 by New England Boring Contractors.

2. Soll and rock classifications, proper-ties and descriptions are based on engineering interpretation from available subsurface information by the Agency and may not necessarily reflect actual variations in sub-surface conditions that may be encountered between individual boring or sample locations.

Observed water levels and/or conditions indicated are as record-ed at the time of exploration and may vary according to the prevail-ing rainfall, methods of exploration and other factors.

### GENERAL NOTES

4. Engineering judgment was exercised in preparing the subsurtace information presented herein, Analysis and interpretation of subsurface data was performed and interpreted for Agency design and estimating purposes. Presentation of the information in the Contract is intended to provide the Contract of the Contract is the contract of the Contract is a contract of the Contract is a contract in the Contract in Contract in the Contract in Contract in Contract in Contract in Contractor. or Judgment by the Contractor.

5. Pictorial structure details shown on the boring plan layout or soils profile are for illustrative purposes only and may not accurately partray final contract details.

6. Terminology used on boring logs to dascribe the hordness, degree of weathering, and socing of fractures, joints and other discontinuities in the bedrock is defined in the ASSHO, Manualon Subsurface Investigations, 1988.

7. Northing and Easting coordinates are shown in Vermont State Plane Grid North American Datum 1983 in meters and survey feet.



PROJECT NAME: NORTHFIELD PROJECT NUMBER: BF 0241(58)

FILE NAME: zi91223bor.dan PROJECT LEADER: K. SMITH DESIGNED BY: S. BROWN BORING LAYOUT SHEET

PLOT DATE: 5/29/2025 DRAWN BY: S. BROWN CHECKED BY: K. SMITH SHEET 44 OF 102

	_		CENT	TERIALS BUREAU RAL LABORATORY		BF 0241(	,		No.: ecked	_	19,J22 4. Saje	
Borin	g Crew;	M. St John (	NEBCI. R. C	Surriell (H&H)			mpler	Groundw	ater C	bserva	tions	
	Started:		ate Finished		Type:		5 in Date	Dep (ft		N	otes	
VTSF	G NAD83:	N 6012	18.43 ft E	1599459.36 ft	Hamm	er Wt: 300 14	O.fb,	- In	1			_
Statio	n: <u>222</u> -	71.29	Offsel;	22.2' LT	Hamm		) in	_	+		_	_
Grou	nd Elevation:	730.4	17 fl		Rig		r = 1					
Depth	Strata (1)			CLASSIFICATIO (Des	ON OF MA scription)	TERIALS	1.11	Blows/6" (N Value)	Moisture Content %	Gravel %	Send %	Eines %
	571.36	0.0 ft - 0.5 ft,						5-7-7-8	-		_	1
	°00.	Environmental	I Sample - N	o sample collected	., .	c. = 0.75 ft, 0.5 ft - 2.0 ft,		(14) 7-6-7-6 (13)		39.0	39.0	22
	10119					c. = 0.83 ft, 2.0 ft - 4.0 ft Rec. = 0.92 ft, 4.0 ft - 6.0	R	R.Q.11.				
5				0.0 H, 6,0 ft - 8,0 ft				(20) 13-12- 22-13				
						= 0.75 ft. 8.0 ft - 10.0 ft		22-13 (34) 11-7-7-			6	
10	1							12				
	С	S-6: Brown m	f Gravel, and	om(-)f Sand, little S	ilt, Rec. =	1.08 ft, 10.0 ft - 12.0 ft		(14) 24-19- 15-14	11.2	25.0	41,0	16
_				***				(34)				
15		S. 7: Ton S* G	Crow mf CDA	VEL and e/+lmf Sa	nd trans (	) Slit, Rec. = 0.67 ft, 15.0	# 165A	9-16-8-	15.1	50.0	41,2	8
		Small preen p	lass fragmer	its throughout		7 One, 1100 0.07 71, 10.0	111-102011,	(24)		30,0	71.2	Ľ
	1	Small green g	lass traumer									
20	-	Casing a	napped at ap	Hole stop proximately 15ft, Hol	ped @ 17. le abandor	0 ft ed with 5ft of casing left in	the hole.					
	4 1	<ol> <li>Mud Rotary</li> </ol>	/ drill used. C	Groundwater not reco	orded.							
	1 1		- 13fl, very	nard drifting	an Neo Policat	<b>.</b>						
		Hole locate     Boulder 8ft										
25		3. Boulder 8ft										
25		2. Hote locate 3. Boulder 8ft										
		2. Hote locate 3. Boulder Bit										
25		Hote locate     Boulder 8ft										
		2. Hote locate 3. Boulder 8ft										
30		2. Hote locate 3. Boulder 8ft										
		2. Hote locate 3. Boulder 8ft										
30		2. Hote locate 3. Boulder 8ft										
30		2. Hote locate 3. Boulder 8tt										
35		2. Hotel locate 3. Boulder 8ft										
35		2. Hote rocate 3. Bourder 6ft										
30		2. Hote locate 3. Boulder 8th										
35 40		2. Hote locate 3. Boulder 8th										
35 40		2. Hote locate 3. Bourder on										

	V	rans		STATE OF VERM AGENCY OF TRANSPO CONSTRUCTION MATERIALS BUR CENTRAL LABORA	ORTATION AND REAU	VTrans I	Vorthfield	NG LOG - VT-12 ove 0241(58)	r Dog Rive	Pa Pir	ning No. ge No. i No.: ecked	_	B-10 1 of 19,J22 A. Said	1
	Station	iterted: 3 NAD83:	9/28/21 N 601: +75.29	NEBC  R. Gurriell   H&H     Date Finished: 9/28/2   222.65 ft   E 1599458,73 ft     Offset: 23,7 t,T     47 ft	Hamm Hamm	er Fall: er/Rod Ty		N.A. N.A. AWJ	Gre Date	Der (fi	vater O	_	tions otes	
	Oepth (fg	Strata (1)			Rigz ICATION OF MA (Description)	MOB	<u></u>			Blowale (N Value)	Moisture Content %	Gravel %	Sand %	
MENT I PC 717,5°	5		Visual Descri Solid-Stern A	plion:, Brown omf SANO, lif uger, no sample taken - spi	ttile omf Gravel, t oils visually class	race Sitt, ified								
	15 -	8		iolid-Stern Auger, drilling be Nud Rotary, Very Hard drillin			laken							
NT A01:30T 59/22	30 -		2, Hole local:	Ho y drill used, Groundwater n ed 4ft North, 1.5ft West of E imples 0ft - 20ft, see B-101	B-101 as-drilled I									
O COPY NORTHFIELD - VT-12 OVER DOG RIVER.GPJ VERMONT ACT ODT	35 -													
OPY NORTHRELD - VI	Notes:	1. Errilles	on liney represent	special step between medical for harmer snergy. C _s is the seen made a lime and under	neterial types, Transit	ion may be g	radual.							

IIIIH&H

PROJECT NAME: NORTHFIELD
PROJECT NUMBER: BF 0241(58)

FILE NAME: ZI9JZ23bor-dop PROJECT LEADER: K. SMITH DESIGNED BY: R. GURRIELL BORING LOG SHEET I

PLOT DATE: 5/29/2025 DRAWN BY: 5, BROWN CHECKED BY: K, SMITH SHEET 45 OF 102

	V	Trans		STATE OF VERMONT AGENCY OF TRANSPORTAL CONSTRUCTION AND MATERIALS BUREAU CENTRAL LABORATORY		VTrans Northfiel Si	F 6241(5	2 over	Dog R	over Pi	oring N age No 'n No.: hecked	_	1 of 19J2	23
	Onte VTSF Statio	g Crew: Started: PG NAD83: on: and Elevation	9/22/21 [ N 6012 2+70.87	NEBC , R. Gurriell (H&H)	Type: I.D.: Harnm Harnm Harnm Rig:	er Falt: 30 in.		in (b. c	Date	Ground De	_	Observ	_	
	Capth	Strata (1)		CLASSIFICATION OF MAT (Description)		Model	Run (Dip deg.)	Core Rec. % (ROD %)	Dritt Rate minutes/ft	Blows/6" (N Value)	Moisture Content %	Gravel %	Sand %	Fines %
ENT 1 70 717.5	5 -	, C) .	S-1: Brown or 4.0 ft, Environ S-2: Grey cml S-3: Brown or Environmenta S-4: Brown/G Environmenta S-5: Black/Bro	Aschati Conrected Reber of SAND, Ittle mi Gravel, Ittle (-) mental Semple - No sample colle SAND, Ittle (-) om Gravel, Reb of SAND, Ittle (-) om Gravel, Reb of SAND, Ittle (-) mi Gravel, Rec if SAND, Ittle (-) imi Gravel, Rec Sample - No sample collected sy om GAND, Ittle com Gravel, Se Sample - No sample collected sy om GAND, Ittle com Gravel, Ittle Sample - No sample collected wm (-) mi (-) SAND, some (-) Si 10.0 fl - 12.0 fl	cted . = 0,67 ft, . = 0.58 ft, Rec. = 1.0	4.0 ft - 8.0 ft 6.0 ft - 8.0 ft, ft, 8.0 ft - 10.0 ft,				10-10- 11-11 12-11 22-17- 9-4 (26) 3-3-3- (6) 10-9-8 (15) 9-3-6-6 (9)		15.0	59.0	21.
	15 -		S-6: Dark Bro 17.0 ft, Wood	wn omf SAND, some om(+)f Gran fragments present in sample	el, Rec. =	0.5 ft, 15,0 ft -				3-3-4-7 (7)				
	20		(Confirmed by S-7: Grey/Blac Wood in tip of	7. Drilled through large piece of w wood stuck to casing upon remo it cm SAND, Rec. = 0.17 ft, 20.0 spoor.  ec. = 0.58 ft, 21.0 ft - 23.0 ft	val)					50/2* (100) 9-7-12- 16 (19)				
	25 -		8-9: Grey mf ( Wood fragmer	SRAVEL, little cmf Sand, Rec. = ts present in sample	I.33 ff, 25.	0 ft - 27.0 ft,				6-6-3-4 (9)				
AOT.GDT SW22	30 -	(57)	30.0 ft - 31.0 ft 8-10: J2 (Bott.	8"): Grey-Brown mf(+) SAND, so t 6"): Grey SILT trace (-), f Sand,		/				14-16- 16-15 (32)	31.3	1.0	2.0	97.0
ELGPJ VERMONT ADT.BDT	35 -		nt - 32.0 rt 32.0 ft, Approx 33.0 ft - 36.0 ft moderately to a cmf grains, 5+	Impte Top of Rock , Grey PHYLLITE, moderately to slightly fractured, moderately soft pieces	highly weat to moderal	ithered, tely hard rock,	C-1 (5-90)	91,7 (45)	6 4 4.5 12 3.5					
LE &	40 -		38.0 ft - 43.0 ft moderately fra 7+ pleces	, Grey PHYLLITE, moderately we druned, moderately soft to modera	eithered, in tely hard n	ntensely to ock, omf grains,	C-2 (5-90)	91.7 (33.3)	7 6 6 6					
COPY NORTHFIELD - VT-12 OVER DOG	45		<ol> <li>Hole located</li> <li>Lost water in</li> </ol>	Hole stopped @ 43.0 or drill used. Groundwater not record 0.5ft South, 2.5ft West of survey, casing all approximately 14ft and promotest boundary between material by ed for hatmare energy. C ₂ is the human made at times and tolled conditions and	fed. -marked lo									

		Q	Trans	STATE OF VERMONT AGENCY OF TRANSPORTAT CONSTRUCTION AND MATERIALS BUREAU CENTRAL LABORATORY		VTrans Northfiel	RING L Id - VT-1; F 0241(5	2 over	Dog R	ver Pi	oring No age No n No.: necked	· -	1 of 19J2	11
		Bonir	g Crew.	M. St John (NEBC), R. Gurriell (H&H)	Туре:	Casing WASH BO				Ground			_	
			Started:	9/21/21 Date Finished: 9/21/21	I.D.:	4 in	1.5	in_	Date	De (f		ı	Votes	
		1	PG NAD83:	N 601208,44 ft E 1599492,27 ft	Hamm	er Wt: 300 er Fall: 30 in.								_
		Statio Grou	on: <u>222</u> nd Blevation	2+68.35 Offset: 12.0' RT			anual/AV	/J	_	H	-			
		Depth	Strale (1)	CLASSIFICATION OF MAT (Description)	ERIALS		Run (Dip deg.)	Core Rec. % (ROD %)	Drill Rate minutes/ft	Blows/8" (N Value)	Moisture Content %	Gravel %	Sand %	Fines %
			468.4	0.0 ft - 0.5 ft, Asphalt 0.5 ft - 2.0 ft, Concrete/Rebar			1	-			Ť			
		5	0: ,0:	S-1: J1 (Top 7"): Brown mf SAND, little Sift, Re Environmental Sample - No same collected S-1: J2 (Bott. 4"): Grey cm(-) SAND, little (+) G S-2: Grey-Brown on GRAVEL, some (+) Sand, 4.0 ft - 6.0 ft	Fravel, 3.0 some Sit	ft - 4.0 ft , Rec. = 0.92 ft,				14-12- 10-9 31-25- 18-8 (43) 10-8	6.6	39.0	31.0	30.0
ABUTME BOT PO EL = 7	C	10	5:02:0	-8.0 ft S-4: Grey-Brown cmf SAND, some (+) cmf(+) c -10.0 ft S-5: Grey-Brown cmf SAND, fittle (+) mf Gravel	Gravel, Re	c. = 0,83 ft, 8,0 ft				10-13 14-6-5 (11) 12-19-				
Ť	74	-		12.0 ft, Highly decomposed shall burylitte	, 1400.					40-50 (59)				
		15		8-6: Brown ami SAND, little a(-)mi Gravel, Rec.	= 1.08 ft	15.0 ft - 17.0 ft				4-6-7-7 (13)				
		20 -	///	S-7: Dark Grey CLAY & SILT some (+), o(-)I Sa (PI=15), Rec. = 2.0 ft, 20.0 ft - 22.0 ft, Wood fra	nd, trace igments in	(-) f Gravel top 6" of sample				3 4 4 4 (8)	91.8	1,0	34.0	65.0
		25 -	ф.	S-6: Grey m(+)f Gravel and cm(-)f Sand, fittle St 27.0 ft	it, Rec. =	0.83 ft, 25.0 ft -				11-9-8- 20 (17)	12.5	25.0	42.0	16.0
	VERMONT AOT.GDT S9/22	30 -		30.0 ft - 35.0 ft, Grey PHYLLITE, moderately to intensely to intensely fractured, moderately soft cmf grains, 3+ pieces	highly we to modera	athered, very tely hard rook,	C-1 (0-30)	91.7 (13.3)	9					
1	No.	35 -							4.5					
EST. BOT PILE EL = 693.5'				35.0 ft - 40.0 ft, Grey PHYLLITE, moderately we fractured, moderately soft to moderately hard roo	athered, i ok, omf gr	noderately sins, 6 pieces	C-2 (30-90)	100 (56.7)	4 4 4.5 5					
	8	40 -	11111111	Hole stopped @ 40.0 i	1			_	6					-
	MORTHPELD - VT-12 OVER DOG RIVER SP	45		Remarks:  1. Mind Rotary drill used, Groundweller not reconsized.  2. Hole located 0.5ft South, 0.5ft West of survey.	ted.	ocation.								
	à-	Notes:	Stratification     N Values II     Water leve	on fines represent approximate boundary between material type save not been corrected for hammer energy. C _e is the hammer I readings have been made at times and under conditions state.	es, Trainsitio energy con ed. Fluctuall	n may be gradual. edition factor, one may accur due to of	ther factors	than Bhos	nd badara	rt of the On	na meas	wensn	ta were	made.



PROJECT NAME: NORTHFIELD PROJECT NUMBER: BF 0241(58)

PLOT DATE: 5/29/2025 DRAWN BY: S. BROWN CHECKED BY: K. SMITH SHEET 46 OF ID2

		V	[ranst		AGENCY	NSTRUCT	NSPORTATI	ON	VTrans	NorthReid		over E	log Ri	yer Pa	ing No.	: _	B-10	1
	-	1			CEN	ATERIALS MRAL LAB	BORATORY			E9-	0241(58)	J			No.: ecked	By:	19J22 A. Said	_
	- 1	Borino	Crew:	M. St John	(NEBC) R.	Gurrieli (H	-IRH)	T		Casing	Sampl	er		Groundw				
	- 1		Started;	9/24/21			/24/21	Type:	٧	VASH BOF 4 in	RE\$S 1.5 ir	- [	Date	Dep	th	N	otes	
	- 1	VTSP	G NAD83:		364.21 ft E		3.86 ft	Hamm		300	140 1	- h	9/28/2	1 18.		3-1041/	na/ Do	odina
	- 1	Station	n: <u>224</u> -	+18.98	Offset:	28.5	7LT	Hamm		30 in.	30 in	_ +	812CV2	10,	- 1	P IUNIN	W RO	Samp
	- 1	Groun	d Elevation:	729.5	56 ft			Rig	er/Rod Ty MOE		C _E =							_
		Cepth (f)	Strate (1)		CLAS		ON OF MAT scription)	ERIALS			Run (Dip deg.)	Care Rec. % (ROD %)	Orill Rate minutes/it	Bloward* (N Value)	Mosture Content %	Gravel %	Sand %	Fines %
ASUTMEN BOT PC EL = 718	- 1	5 - 10 - 15 - 20 -		0.0 ft - 0.5 ft, S-1: Brown or Environment S-2: Brown or S-2: SAME, F. S-4: Brown or S-5: SAME, F. S-4: Brown Co. S-5: SAME, F. S-6: Brown G. S-6: Brown G. S-7: Jar A (to 10.0 ft, 10.	mf SAND, sid Sample - I sid Sample - I mf (+) SAND, Rec. = 0.831 mf SAND, sides, s	No sample ), little cmf fil, 4.0 ft - 6 some (+) or fil, 8.0 ft - 1 vel, some ( umbbled roc umbbled roc cm cmf GRA Partial Envi ck CLAY & SANID, som out sample and (-) m(+	collected (Gravel, Rec 6.0 ft foravel, Re 10.0 ft (+) Silt, some ok  AVEL, some ironmental S  I.SILT, 16.5 t  The Silt, Rec e e) if Gravel, lit	c, = 0.83 fi dec, = 0.75 e (-) cm(-) omf Sand sample - w ft - 17.0 ft = 1.5 ft, 2	1, 2.0 ft - 4 5 ff, 6.0 ft If Sand, R If Sand, R	4.0 ft - 8.0 ft tec. = , Rec. = sample 2.0 ft,				(2.16.12-10) (2.19.10-10-10-10-10-10-10-10-10-10-10-10-10-1	8.9	47.0		
		1		28 0 ft, Appro	R - 27.0 ft, C	Decompose	e (+) c(-)mr ( ed Rock	Greavel, Id	ttle Sat, R	ec. =				15-26- 33-50 (59)				
	VERBONT ADTIGUT SAIZ2	30 -		29.0 ft - 34.0 fractured, mo	ft, Grey PH	YLLITE, IT	nuclerately to figrains, 7+ p	sligitly w pleces	voorthered,	slightly	C-1 (5-80)	100 (95)	4.5 4.5 5 5					
ST. 807 PILE L = 694,6'		-95 -		34.0 ft - 39.0 fractured, mo Bottom 6*; La	derately sof	ft to moden	lightly weath rately hard ro	ered, mod ock, cmf g	derately to rains, 6+	slightly pieces,	C-2 (5-80)	96.7 (66.7	5					
	NORTHRIELD - VT-12 OVER DOG RIVER.GPJ	40 -		Remarks: 1. Mud Roter 2. Hole locate 3. B-104MW	ed 4ft North,	Groundwa	of survey-ma	rded. arked loca	ition. drilled loca	ation.		'						
	2010 COPY N	Notes:	1. Strettficati 2. N Values 3. Water few	on fines represent : have not been com of readings have be	epproximate bo ected for harm sen made at tin	oundary betw ner energy, C nes and unde	veen material by C _e is the harmon er conditions at	pes. Yrangië er energy co ried. Fluctue	ion may be o prection fact plions may o	pradual. lor. secur due to o	duar factors	than the	se pres	ont at the t	me ma	Esureme	nts were	e med

	Ý	Trans	STATE OF VERMONT AGENCY OF TRANSPORTAT CONSTRUCTION AND MATERIALS BUREAU CENTRAL LABORATORY	ION	VTrans Northfield	ING LO - VT-12 0241(58)	over (	Dog Ri	ver Pa	ring N ge No.: No.: ecked	· _	B-10 1 of 19J22 A. Saj	3
	Boring	Crew:	M. St John (NEBC), R. Gurriell (H&H)		Casing	Sampl	er		Groundw	rater C	)bserve	dions	
×.	Date S	Started:	9/23/21 Date Finished: 9/23/21	Type:	WASH BOI 4 In	1.5 in	- [	Date	Dep		N	lotes	
	VTSP	G NAD83;	N 601352.94 ft E 1599511.91 ft	Hamn	ner Wt:300	1401	<u> </u>		(n	+	_	_	_
	Station	n: <u>224</u> 4	+13.78 Offset: 1.2' RT		ner Fall: 30 in. ner/Rod Type: Ma	30 In		_	_	-	_	_	
	Groun	d Elevation:	729.72 ft	Rig	MOBILE	C _e =				7			
	(if)	Strata (1)	CLASSIFICATION OF MAT	ERIALS		Run (Dip deg.)	Core Rec. % (ROD %)	Onli Rafe minutes/ft	Blows/6" (N Value)	Monsture Content %	Gravel %	Sand %	Fines %
	ă	E	(Description)			e e	88	투	82	500	5	Se Se	럂
	5 -	10:30 10:30	0.0 ft - 0.5 ft, Asphalt 5-1: GreyBrown mf Gravel, some (+) cm(-)f St ft, 0.5 ft - 2.0 ft S-2: SAME, Rec. = 0.92 ft, 2.0 ft - 4.0 ft S-3: SAME, Rec. = 0.58 ft, 4.0 ft - 6.0 ft				0		41-50- 46-39 (96) 17-13- 10-6 (23) 6-2-5-2	2.5	23.0	33.0	24.0
		1 1	S-4; Grey cmf GRAVEL, little cmf Sand, Rec. =	0.33 ft, (	3.0 ft - 8,0 ft				7.6-5-9 (11)				
ABUTMENT 2 BOT PC EL = 716.5'	10 -		S-5: Dark Brown crnf SAND, little (+) crnf Grav 10.0 ft						3-4-7- 11 (11)				
\\\\\\\\\\\\\\\\\\\\\\\\\\\\\\\\\\\\\\			S-6; Grey c(-)mf GRAVEL, trace cmf Sand, tra 10.0 ft - 12.0 ft, Crumbled Rock	oe (-) Silt,	Rec. = 1.08 ft,				11-11- 11-16 (22)				
	15 -												
			S-7; Grey cmf GRAVEL, little Silt, trace f Sand, fl, Crumbled Rock	Rec. = 0	.5 ft, 15,0 ft - 17,0				3-5-8- 20 (13)				
	20 -												
H W	l i		S-8: Grey cmf(+) SAND, trace cmf Gravel, Rec Environmental Sample - No sample collected	. = 0.67 f	t, 20.0 ft - 22.0 ft,				6-4-5-4				
		٠D	S-9: Grey-Black mf(+) Gravel, and (-) cm(-)f Si 1.5 ft, 22.0 ft - 24.0 ft	ind, some	(-) Silt, Rec. =				3-10- 16-23 (26)	12.4	44.0	35.0	21.0
\$6072	25 -		25,0 fl - 30.0 ft, Grey PHYLLITE, moderately w slightly fractured, moderately soft rock, cmf gra	eathered, ins, 5+ pi	moderately to eoes	C-1 (5-90)	91.7 (45)	3 3 6 5					
EST. BOT PILE 59	30		30.0 ff - 35.0 ft, Grey PHYLLITE, moderately w fractured, moderately soft rock, cmf grains, 5+	eathered, pieces	moderately	C-2 (5-90)	100 (58.3	5.5					
Š.	35 -	(Mill)		_				4.5					
RGPJ VE			Hole stopped @ 35.0	ft									
иомвал газ ама восе вичек сел тила сима госе	40 -		Remarks:  1. Must Robary drill used. Groundwater not reco.  2. Hote located 3.5ft North of survey-marked to 3. Could not meintein seel at bottom of casing.	cation.	roximately 750 gallor	ns of wate	er diunir	ng rock	coring.				
10 COPY MORTHFELL	Notes;	Stratificati     N Values     Water leve	on lives represent approximate boundary between material b have not been convoked for hammer energy. C ₂ is the ham of madings have made at time and under conditions at	pes. Transi er energy c sled, Fluctu	fon may be gradual, oresiden factor. authors may pecar due in a	fher factives	than the	me pres	and at the h	ma m~		ents were	ı mad-




PROJECT NAME: NORTHFIELD PROJECT NUMBER: BF 0241(58)

FILE NAME: ZI9J223bor.dgn PROJECT LEADER: K, SMITH DESIGNED BY: R, GURRIELL BORING LOG SHEET 3

PLOT DATE: 5/29/2025 DRAWN BY: S. BROWN CHECKED BY: K. SMITH SHEET 47 OF 102

	Q	Trans		AGENCY CON- MAT	TE OF VERMONT OF TRANSPORTAT STRUCTION AND ERIALS BUREAU RAL LABORATORY		VTrans Northfiel	RING L ld - VT-12 F 0241(5)	over	Dog R	lver Pi	oring No age No n No.: necked		B-1 1 of 19,J22 A. Sai	1
	Oate VTSF Static	g Crew: Started: PG NAD83: on: 224 and Elevation	9/20/21 D N 6013 +13.93	Offset:			er Fall: 30 in. er/Rod Type; M	1.5 140 30 in anual/AW		Date	Ground	vater (	Observ	_	EW3NE
	the Co	Strate (1)			FICATION OF MAT (Description)	Rig: _	MOBILE	Run (Dip deg.)	Core Rec. %	Orill Rate	Blowa/6" (N Value)	Moisture Content %	Gravel %	Sand %	Fines %
ABUTMENT 2 BOT PC EL = 716.5'	5 -		S-2 Brown cm 2.0 ft - 4.0 ft, ft S-3: Grey cm(- ft - 6.0 ft S-4: Grey cm(- ft - 8.0 ft S-5: Grey cm(- ft - 10.0 ft	and sand, little and sand, little and sand, so and sand, so and	conf Gravel, grass/ i Sample - no samp ornf Gravel, grass/ i Sample - no samp me (+) f Gravel, little me (+) f Gravel, little me (+) f Gravel, little ' SAND, trace f Gra	ie taken organics, i le taken e (+) Silt, F e (+) Silt, F e (+) Silt, F	Rec. = 0.42 ft, lec. = 1.0 ft, 4.0 lec. = 1.17 ft, 6.0 lec. = 0.5 ft, 8.0				4-6-13- (19) 15-12- (21) 9-8-6-5 (12) 6-7-11- (18) 9-8-16- (18) 8-16- (10) (20)		32.0	50,0	18.0
	15 -	0;·,0;·, //.6/.6	8-7: Brown 1 S 17.0 ft	AND, some S	Sitt, trace (-) f Grave	l, Rec. = 0	.75 ft, 15.0 ft -				6-8-9- 11 (17)	17.4	1.0	73.0	26.0
	20 -	0: ,0:	S-9: Grey mf(+ -24.0 ft, Approx 24.0 ft, Approx	vood fragmer Sample - no -) Gravel, son mposed Rock mate Top of , Grey PHYL	ne (+) of Sand, som Rock LITE, slighey weath	le e Silt, Rec	. = 1.5 ft, 22.0 ft	G-1 (30-90)	96.7 (63.3)	3.5 5.5	4-3-1-1 (4) 4-12- 21- 60/3*	10.6	40.0	32.0	28.0
278/25	30 -									6.5 6 6.5					
699.0' Q			30.0 ft - 35.0 ft moderately soft	, Grey PHYLI trock, mfgra	LITE, slightly weath ins, 3+ pieces	ered, sligh	tly fractured,	C-2 (60)	.100 (91.7)	7.5 8 8 7 7.5					
NORTHPIELD - VT-12 OVER DOG RIVER.GPJ VERMONT	40 -		Remarks; 1. Mud Rotary of 2. Hole located	drill used. Gra	ole stapped @ 35.0 oundwater not recor					/.5					
§	Notes:	1. Small code 2. N Values h 3. Water (eve	in lines represent app we mit been correct treadings have been	producte bound ad for hammer a made at limes a	ary between material typ nergy. C _a is the hamma and under conditions stat	es, Translitor r snergy com led, Fluctuetic	n may be gradual. robon factor, aha may occur due to o	Ever factors 1	fun tho	H Dresse	nd all the tin	se mass	Witimide	le were	made.

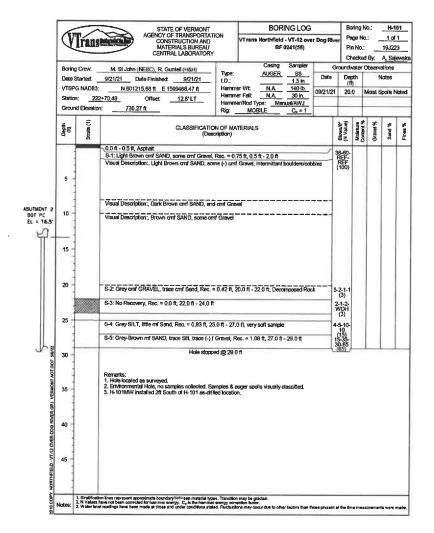





PROJECT NAME: NORTHFIELD
PROJECT NUMBER: BF 024I(58)

FILE NAME: 219]223bor.dgn PROJECT LEADER: K. SMITH DESIGNED BY: R. GURRIELL BORING LOG SHEET 4

PLOT DATE: 5/29/2025 DRAWN BY: S. BROWN CHECKED BY: K, SMITH SHEET 48 OF 102

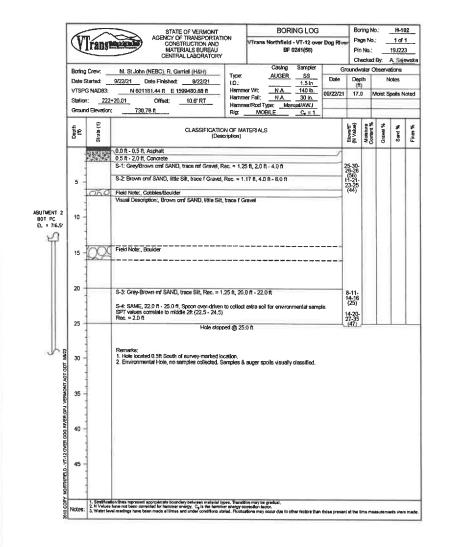

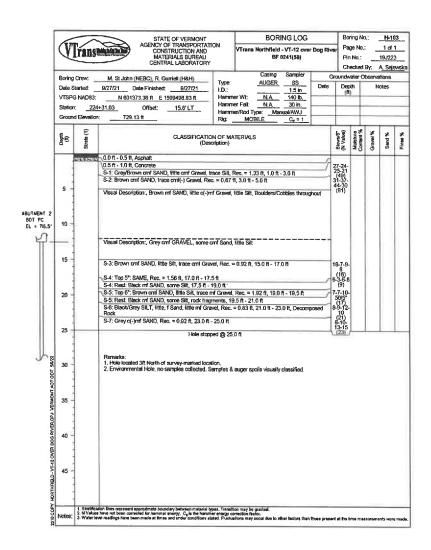




PROJECT NAME: NORTHFIELD
PROJECT NUMBER: BF 0241(58)

FILE NAME: 2193223bor.dgn PROJECT LEADER: K. SMITH DESIGNED BY: R. GURRIELL BORING LOG SHEET 5

PLOT DATE: 5/29/2025 DRAWN BY: 5. BROWN CHECKED BY: K, SMITH SHEET 49 OF 102

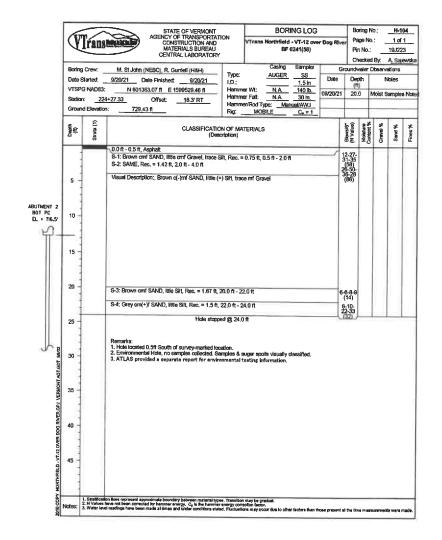


IIIIH&H

PROJECT NAME: NORTHFIELD
PROJECT NUMBER: BF 0241(58)

FILE NAME: 2/9/223bor.dgn PROJECT LEADER: K, SMITH DESIGNED BY: R. GURRIELL BORING LOG SHEET 6

PLOT DATE: 5/29/2025 DRAWN BY: S. BROWN CHECKED BY: K. SMITH SHEET 50 OF 102

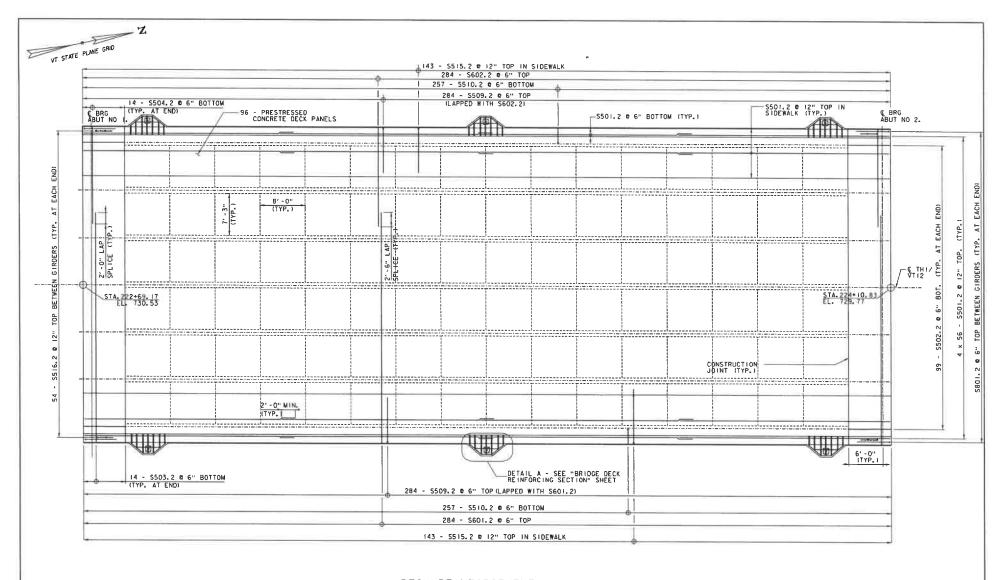

NOTES!

1. BRIDGE RAIL REINFORCEMENT NOT SHOWN FOR CLARITY. SEE "BRIDGE RAILING DETAILS !" AND "BRIDGE RAILING DETAILS 2" FOR BRIDGE RAIL REINFORCEMENT DETAILS.

2. SEE "ABUTMENT I REINFORCEMENT" AND 
"ABUTMENT 2 REINFORCEMENT" FOR STEM 
REINFORCEMENT DETAILS.


DECK REINFORCEMENT PLAN


SCALE: 1/6"=1'0"

H&H

PROJECT NAME: NORTHFIELD
PROJECT NUMBER: BF 0241(58)

FILE NAME: ZISJ223sup.dgn PROJECT LEADER: K. SMITH DESIGNED BY: N. BOB BRIDGE DECK PLAN PLOT DATE: 5/29/2025 DRAWN BY: C. JAMISON CHECKED BY: K. SMITH SHEET 5! OF ID2

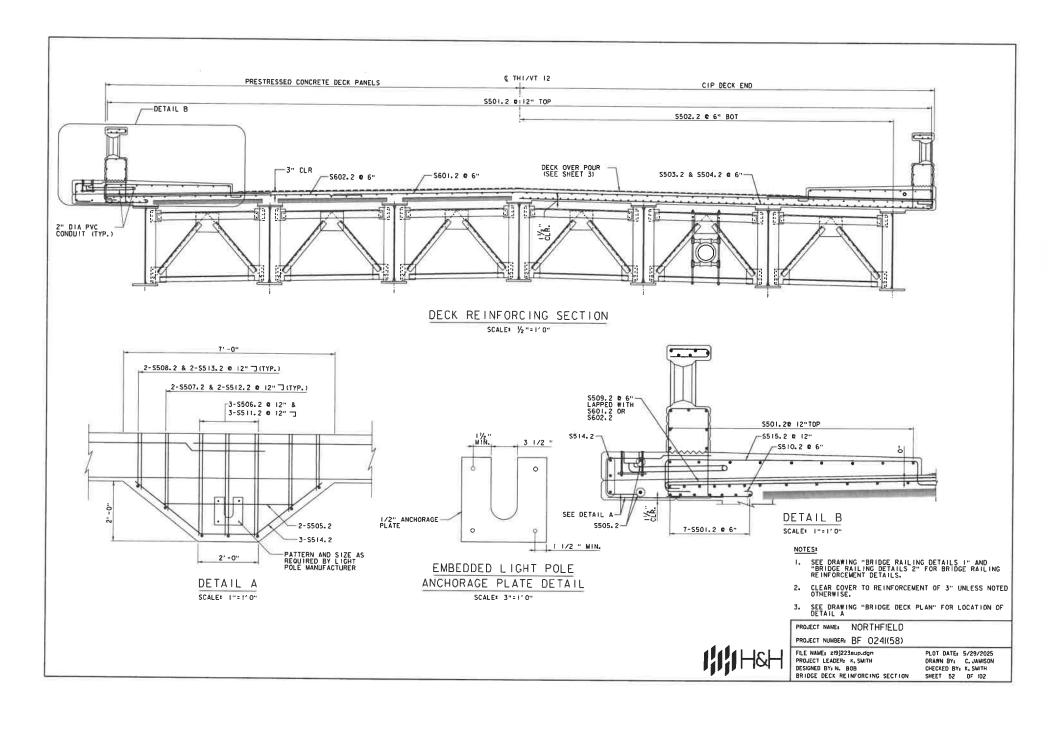

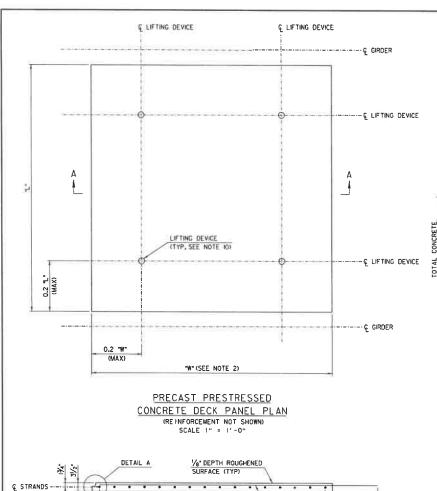

% DIA STRANDS

(SEE TABLE)

SECTION A-A


SCALE I" = 1'-0"

3" (TYP)


*4 BAR @ 6*


I'-6" REBAR PROJECTION

(FOR END PANELS ONLY)

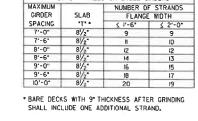

PRECAST PANELS ON STEEL GIRDERS

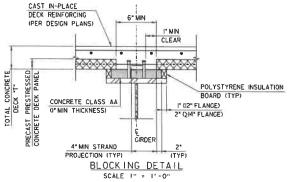

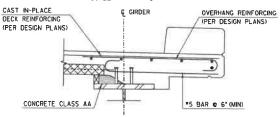

TYPICAL OVERHANG SECTION

SCALE I" = 1'-0"

### LEGEND




CONCRETE CLASS AA WITH HIGH RANGE WATER REDUCING ADMIXTURE


### GENERAL NOTES:

- PRECAST DECK PANELS SHALL CONFORM TO STANDARD SPECIFICATION SECTION 510 - PRESTRESSED CONCRETE. REINFORCING BARS SHALL MEET THE REQUIREMENTS OF SECTION 507 - REINFORCING STEEL.
- 2. THE TYPICAL PANEL WIDTH IS 8'-0". PANEL WIDTHS OF LESS THAN 8'-0" MAY BE USED. PROVIDE STRANDS IN THE RATIO OF THE SMALLER PANEL WIDTH TO 8'-0", MULTIPLIED BY THE NUMBER OF STRANDS SHOWN, ROUNDING UP TO THE NEXT EVEN NUMBER OF STRANDS. THE MINIMUM PANEL WIDTH IS 3'-0".
- THE CONTRACTOR SHALL SUBMIT WORKING DRAWINGS SHOWING THE EXACT LAYOUT OF PANEL TYPES AND SIZES.
- PRESTRESSING STRANDS SHALL BE %" DIAMETER, GRADE 270 7 - WIRE LOW RELAXATION STRANDS CONFORMING TO THE RECUIREMENTS OF AASHTO M203 (ASTM A416). INITIAL TENSION SHALL BE 17.2 KIPS PER STRAND.
- REINFORCING BARS SHALL HAVE THE SAME LEVEL OF CORROSION RESISTANCE AS THE REINFORCING BARS IN THE CAST-IN-PLACE PORTION OF THE DECK.
- 6. CONCRETE FOR PRECAST PRESTRESSED CONCRETE DECK PANELS SHALL HAVE A MINIMUM 2B DAY COMPRESSIVE STRENGTH OF 5,000 PSI AND A MINIMUM RELEASE STRENGTH OF 4,000 PSI.
- DURING ERECTION, PRECAST PRESTRESSED CONCRETE DECK PANELS SHALL ALIGN VERTICALLY TO WITHIN 1/4 INCH.
- POLYSTYRENE INSULATION BOARD SHALL BE CONTINUOUS, HIGH-DENSITY AND SHALL BE CUT IN THE FIELD TO THE REQUIRED THICKNESS.
- DECK PANELS ARE REQUIRED TO BE GROUTED IN PLACE PRIOR TO PLACEMENT OF THE CAST IN-PLACE DECK. TOP OF GROUT BED SHALL BE A MINIMUM OF I" BELOW THE STRAND EXTENSIONS.
- LIFTING DEVICE SELECTION AND DESIGN SHALL BE THE RESPONSIBILITY OF THE FABRICATOR. A MINIMUM OF FOUR DEVICES SHALL BE INSTALLED.
- 11. REGARDLESS OF THE CURING METHOD FOR THE HAUNCH POUR. FULLY SATURATE CONTINUOUSLY, THE TOP AND SIDE SURFACES OF THE PANELS FOR THREE DAYS AFTER THE HAUNCH POUR AND PRIOR TO THE OVER POUR, PROCEDURE OF THE WETTING METHOD SHALL BE DETERMINED BY THE CONTRACTOR AND SUBMITTED FOR APPROVAL TO THE RESIDENT ENGINEER.
- 12. TEMPORARY BRACING BETWEEN PANELS SHALL BE PROVIDED AS REQUIRED TO PREVENT PANEL MOVEMENT TRANSVERSE TO THE GIRDERS. TEMPORARY BRACING DETAILS SHALL BE PROVIDED IN THE PANEL FABRICATION DRAWINGS AND/OR ERECTION PLAN.


PROJECT NAME: NORTHFIELD PROJECT NUMBER: BF 024(58)

FILE NAME: zi9J223sup.dgn PROJECT LEADER: K. SMITH DESIGNED BY: VTRANS BRIDGE DECK DETAILS PLOT DATE: 5/29/2025 DRAWN BY: VTRANS CHECKED BY: VTRANS SHEET 53 OF 102

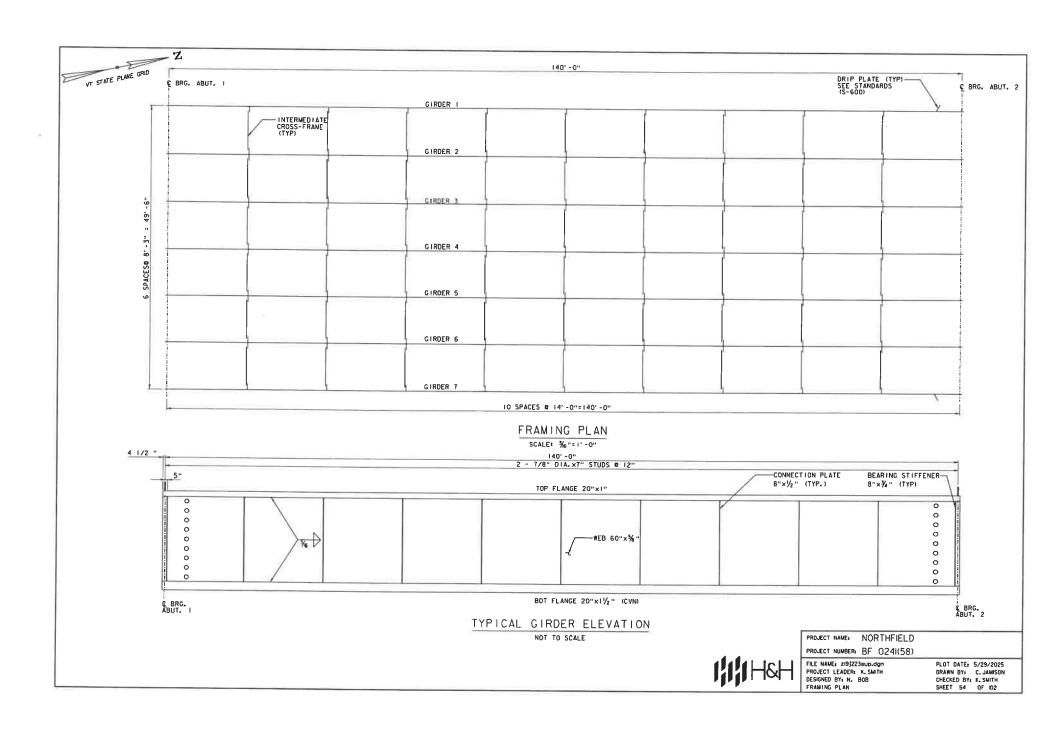

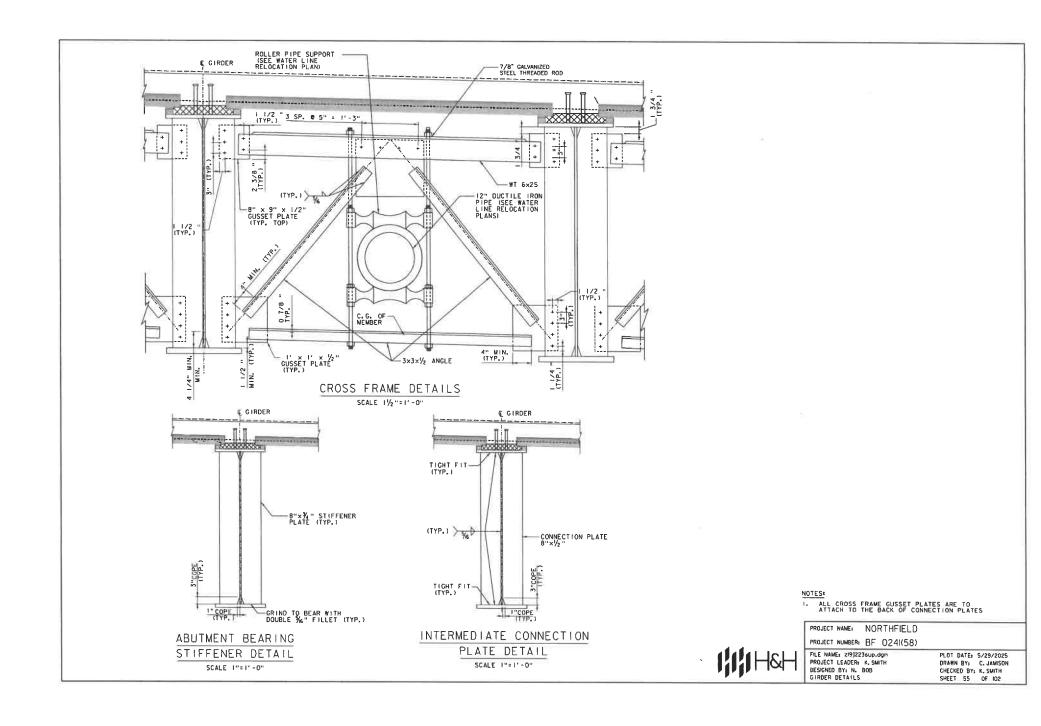



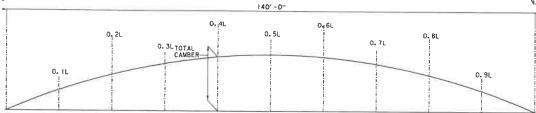

## CAMBER DIAGRAM

NOT TO SCALE


			CA	MBER	TAB	LE						
GIRDER		CL OF BRG ABUT, I	0, IL	0. 2L	0.3L	0. 4L	0. 5L	0. 6L	0.7L	0. 8L	0. 9L	BRG ABUT.
	1. STEEL DL (IN.)	0,00	-0.48	-0.90	-1.23	-1.45	-1.52	-1.45	-1,23	-0.90	-0.48	0.00
	II. CONCRETE DL (IN.)	0.00	-1.39	-2.62	-3.59	-4.21	-4.42	-4.21	-3.59	-2.62	-1.39	0.00
1	III. SUPERIMPOSED DL (IN.)	0.00	-0.44	-O. B3	-1.14	-1.33	-1.40	-1.33	-1.14	-0.83	-0.44	0.00
	TOTAL (IN.)	0.00	-2.30	-4.35	-5.96	-6.98	-7.33	-6.98	-5.96	-4.35	-2.30	0.00
	I. STEEL DL (IN.)	0.00	-0.48	-0.90	- 1. 23	-1.45	-1.52	-1.45	-1.23	-0.90	-0.48	0.00
	II. CONCRETE DL (IN.)	0.00	-1.72	-3.26	-4.46	-5.22	-5.48	-5.22	-4.46	-3.26	-1.72	0.00
2	III. SUPERIMPOSED DL (IN.)	0.00	-0.42	-D. 79	-1.08	-1.27	- 1. 33	-1.27	-1.08	-0.79	-0.42	0.00
	TOTAL (IN.)	0.00	-2.62	-4.95	-6.78	-7.94	-8.33	-7.94	-6.78	-4.95	-2.62	0.00
	1. STEEL DL (IN.)	0.00	-0.48	-0.90	-1.23	-1.45	-1.52	-1.45	-1.23	-0.90	-0.48	0.00
	II. CONCRETE DL (IN.)	0.00	-1.72	-3.26	-4.46	-5, 22	-5.48	-5.22	-4.46	-3.26	-1.72	0.00
3	III. SUPERIMPOSED DL (IN.)	0.00	-0.42	-0.79	-1.08	-1.27	-1.33	-1-27	-1.08	-0.79	-0.42	0.00
	TOTAL (IN.)	0.00	-2.62	-4.95	-6.78	-7.94	-8.33	-7.94	-6.78	-4.95	-2.62	0.00
	I. STEEL DL (IN.)	0.00	-0.48	-0.90	-1.23	-1.45	-1.52	-1.45	-1.23	-0.90	-0.48	0.00
	II. CONCRETE DL (IN.)	0.00	-1.72	-3.26	-4.46	-5.22	-5.48	-5.22	-4.46	-3.26	-1.72	D. 00
4	III. SUPERIMPOSED DL (IN.)	0.00	-0, 42	-0.79	-1.08	-1.27	-1.33	-1.27	-1.08	-0.79	-0.42	0.00
	TOTAL (IN.)	0.00	-2.62	- 4. 95	-6.78	-7.94	-8.33	-7.94	-6.78	-4.95	-2.62	0.00
	I. STEEL DL (IN.)	0.00	-0.48	-0.90	-1.23	-1.45	-1.52	-1.45	-1.23	-0.90	-0.48	0.00
	II. CONCRETE DL (IN.)	0.00	-1.72	-3.26	-4.46	-5.22	-5.48	-5.22	-4.46	-3.26	-1.72	0.00
5	III. SUPERIMPOSED DL (IN.)	0.00	-0.42	-0.79	- I. OB	-1.27	-1.33	-1.27	-1.08	-0.79	-0.42	0.00
	TOTAL (IN.)	0.00	-2,62	-4.95	-6.7B	-7.94	-8.33	-7.94	-6.78	- 4. 95	- 2. 62	0,00
	I. STEEL DL (IN.)	0.00	-0.48	-0.90	-1.23	-1.45	-1.52	-1.45	-1.23	-0.90	-0.48	0.00
1	II. CONCRETE DL (IN.)	0.00	-1.72	-3.26	-4,46	-5.22	-5.48	-5.22	-4.46	-3.26	-1.72	0.00
6	III. SUPERIMPOSED DL (IN.)	0,00	-0.42	-0.79	- 1.08	-1.27	-1.33	-1.27	-1.08	-0.79	-0.42	0.00
	TOTAL (IN.)	0.00	-2,62	-4.95	-6.78	-7.94	-8.33	-7.94	-6.78	-4.95	-2.62	0.00
	I. STEEL DL (IN.)	0.00	-0.48	-0.90	-1.23	-1.45	-1.52	-1.45	-1.23	-0.90	-0.48	0.00
	II. CONCRETE DL (IN.)	0.00	-1,39	-2.62	-3.59	-4.21	-4.42	-4.21	-3.59	-2.62	-1.39	0.00
7	III. SUPERIMPOSED DL (IN.)	0.00	-0.44	-0.83	-1.14	-1.33	- I. 4D	-1,33	-1.14	-0.83	-0.44	0.00
	TOTAL (IN.)	0.00	-2.30	-4.35	-5.96	-6.98	-7, 33	-6, 98	-5, 96	-4.35	-2.30	0,00


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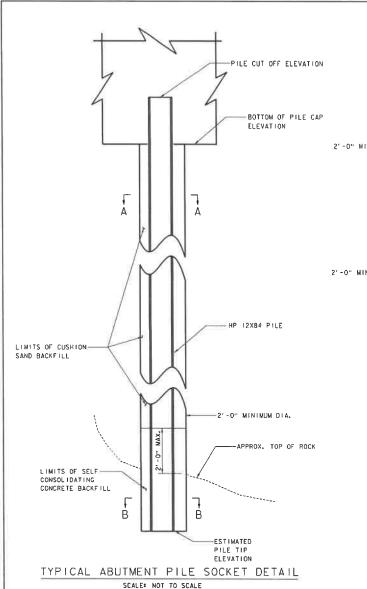
PROJECT NAME: NORTHFIELD
PROJECT NUMBER: BF 0241(58)


FILE NAME: ZI9)2236UD.dgn PROJECT LEADER: K. SMITH DESIGNED BY: N. BOB CAMBER TABLE

PLOT DATE: 5/29/2025 DRAWN BY: C. JAMISON CHECKED BY: K. SMITH SHEET 56 OF 102



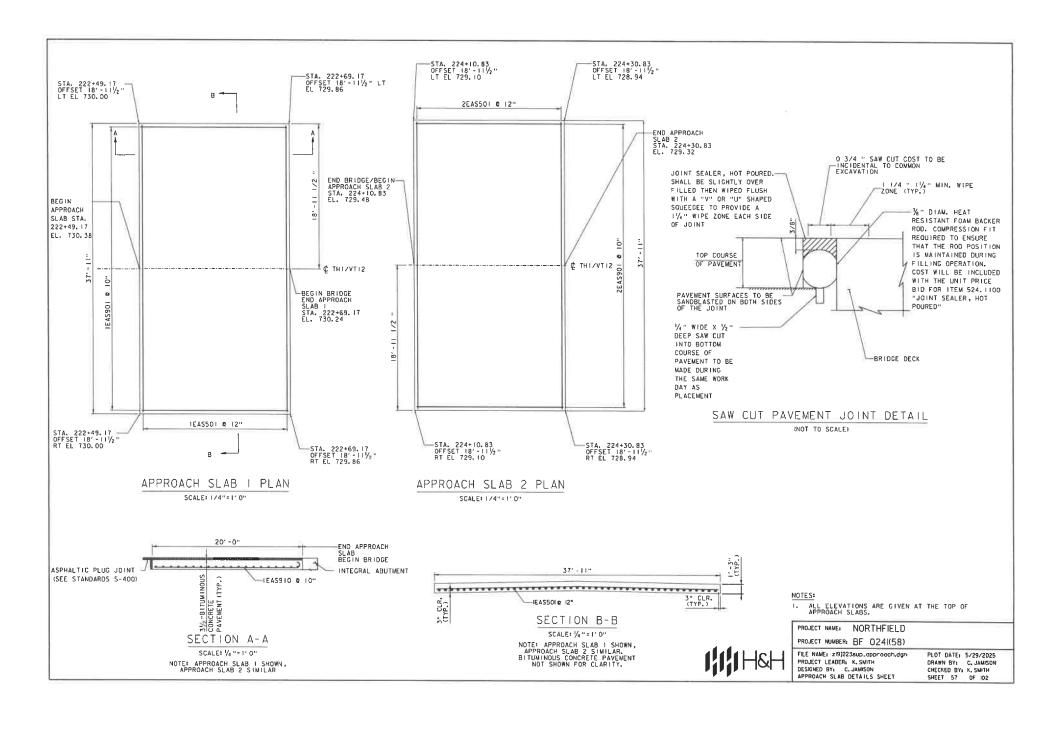

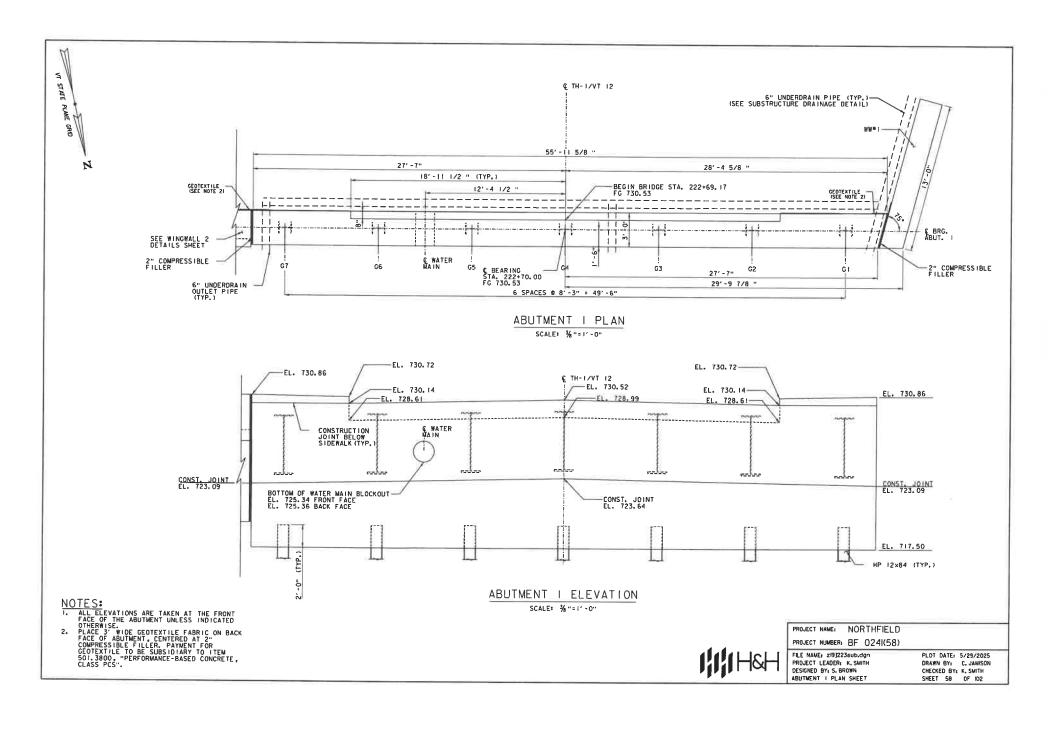

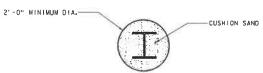

# SECTION A-A



SECTION B-B

### NOTES:

- FOR WINGWALL PILE INFORMATION REFER TO WINGWALL PILE DETAIL SHEET.
- 2. SELF-CONSOLIDATING CONCRETE (SCC) SHALL BE PLACED UNTIL UNCONTAMINATED SCC SURPASSES THE LIMITS OF THE ROCK SOCKET, BUT DOES NOT EXTEND PAST THE LIMITS OF SCC SHOWN ON THE PLANS, THE REMAINDER OF THE DRILLED PILE SOCKET SHALL BE BACKFILLED WITH CUSHION SAND.
- 3. THE CONTRACTOR SHALL IMMEDIATELY NOTIFY THE ENGINEER IF ACTUAL TOP OF ROCK ELEVATIONS ARE OUTSIDE THE RANGES SHOWN IN THE ABUTMENT PILE SUMMARY TABLE.


				ABUTMENT P	ILE SUMMARY TABLE			
UBSTRUCTURE PILE SIZE		MIN. DRILL HOLE DIA. (FT)	ESTIMATE ROCK ELEV	D TOP OF (ATION (FT)	REQUIRED ROCK SOCKET LENGTH (FT)	ESTIMATED ELEVAT	PILE TIP ION (FT)	PILE CUTOFF ELEVATION (FT)
			FROM	ТО		FROM	TO	
ABUTMENT I	HP 12×84	2	698.5	700.3	7	691.5	693.3	719.5
ABUTMENT 2	HP 12×84	2	701.6	706.0	7	694.6	699.0	718.5



PROJECT NAME: NORTHFIELD
PROJECT NUMBER: BF 0241(58)

FILE NAME: z/9/223h_p/le_grouting.dgn PROJECT LEADER: K, SMITH DESIGNED BY: S, BROWN ARIITMENT PILE DETAIL SHEET

PLOT DATE: 5/29/2025 DRAWN BY: C. JAMISON CHECKED BY: K. SMITH SHEET 59 OF 102

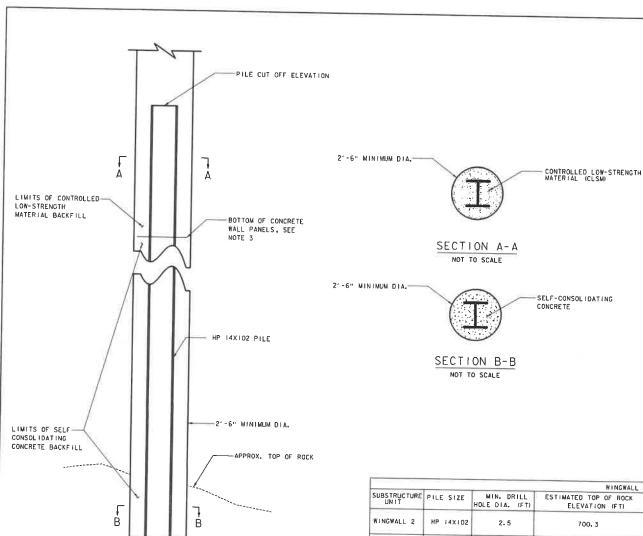

PILE TIP ELEVATION

TYPICAL WINGWALL PILE SOCKET DETAIL

### NOTES:

- FOR ABUTMENT PILE INFORMATION REFER TO ABUTMENT PILE DETAIL SHEET.
- SELF-CONSOLIDATING CONCRETE SHALL BE PLACED TO THE BOTTOM OF THE CONCRETE WALL PANELS. THE REMAINDER OF THE DRILLED PILE SOCKET SHALL BE BACKFILLED WITH CONTROLLED LOW-STRENGTH MATERIAL (CLSM).
- 3. CONCRETE WALL PANELS NOT SHOWN FOR CLARITY.
- 4. THE CONTRACTOR SHALL NOTIFY THE ENGINEER IF ROCK IS NOT ENCOUNTERED 5'-O" BELOW THE ESTIMATED TOP OF ROCK ELEVATION SHOWN IN THE WINGWALL PILE SUMMARY TABLE. ORILLING OPERATIONS SHALL CEASE AND THE ENGINEER SHALL BE NOTIFIED IF ROCK IS NOT ENCOUNTERED UPON REACHING THE MAXIMUM PILE TIP ELEVATION IN SOIL SHOWN IN THE WINGWALL PILE SUMMARY TABLE.

			WINGWALL	PILE SUMMARY TABLE		
SUBSTRUCTURE UNIT		MIN. DRILL HOLE DIA. (FT)	ESTIMATED TOP OF ROCK ELEVATION (FT)	REQUIRED ROCK SOCKET LENGTH (FT)	ESTIMATED PILE TIP ELEVATION IN ROCK (FT)	MAXIMUM PILE TIP ELEVATION IN SOIL (FT)
WINGWALL 2	HP 14X102	2.5	700. 3	7	693.3	690.0
WINGWALL 3	HP 14X102	2,5	701.6	7	694.6	690.0





PROJECT NAME: NORTHFIELD
PROJECT NUMBER: BF 0241(58)

FLE NAME: 2191223h.plie.grouting.dgn
PROJECT LEADER: K. SWITH
DESIGNED BY: S. BROWN
WINGWALL PILE DETAIL SHEET

PLOT DATE: 5/29/2025
DRAWN BY: C. JAMISON
CHECKED BY: K. SWITH
WINGWALL PILE DETAIL SHEET

SHEET 60 0F 102

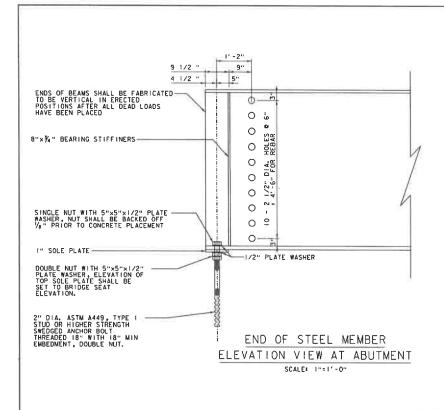

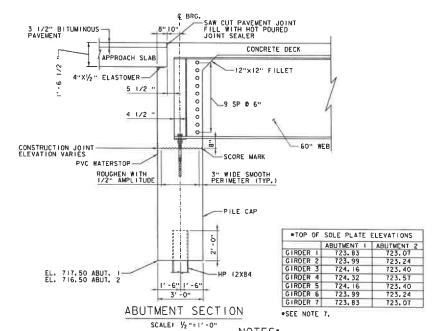

## NOTES:


- PAYMENT FOR THE SOLE PLATES, ANCHOR BOLTS, WASHERS AND NUTS SHALL BE INCIDENTAL TO ITEM 506.550D, STRUCTURAL STELL, PLATE GIRDER.
- ANCHOR BOLTS SHALL BE 2" DIAMETER, TYPE I BOLTS MEETING ASTM F 1554, GR 55. NUTS SHALL MEET ASTM 4563.
- ALL ANCHOR BOLTS SHALL BE SET BY TEMPLATE BEFORE CONCRETE IS PLACED. NO DRILLING WIL BE ALLOWED, ALL ASSOCIATED COSTS SHALL BE INCIDENTAL TO ITEM 501.3700, "PERFORMANCE-BASED CONCRETE, CLASS PCD".
- 4. ALL STEEL IN BEARING DEVICE ASSEMBLY SHALL BE AASHTO M270M/M270 GR 50.
- SUBSTITUTIONS FOR BEARING DEVICE ASSEMBLY COMPONENT MATERIALS AND SIZES SHALL BE DETAILED ON THE FABRICATION DRAWINGS. ALL SUBSTITUTIONS SHALL BE APPROVED BY THE PROJECT MANAGER PRIOR TO FABRICATION AS PER SECTION 506.04.
- 6. THE CONTRACTOR SHALL GREASE THE TOP SURFACE OF THE SOLE PLATES PRIOR TO PLACEMENT OF THE GIRDERS. FOLLOWING GIRDER ERECTION ALL EXCESS GREASE SHALL BE WIPED FROM THE SOLE PLATES.
- THE CONTRACTOR SHALL VERIFY THAT ALL ANCHOR BOLTS ARE INSTALLED PLUMB AND REMAIN PLUMB FOLLOWING GIRDER ERECTION. THE ENGINEER SHALL BE NOTIFIED OF ANY DISCREPANCIES.


PROJECT NAME: NORTHFIELD


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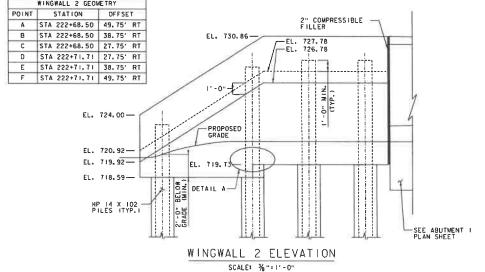
FILE NAME: ZI9J223sub.dgn PRDJECT LEADER: K. SMITH DESIGNED BY: S. BROWN ABUTMENT CONNECTION DETAIL


PLOT DATE: 5/29/2025 DRAWN BY: C. JAMISON CHECKED BY: K. SWITH SHEET 61 OF 102



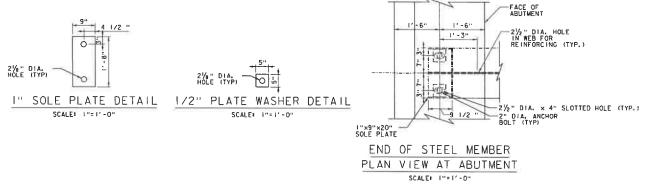

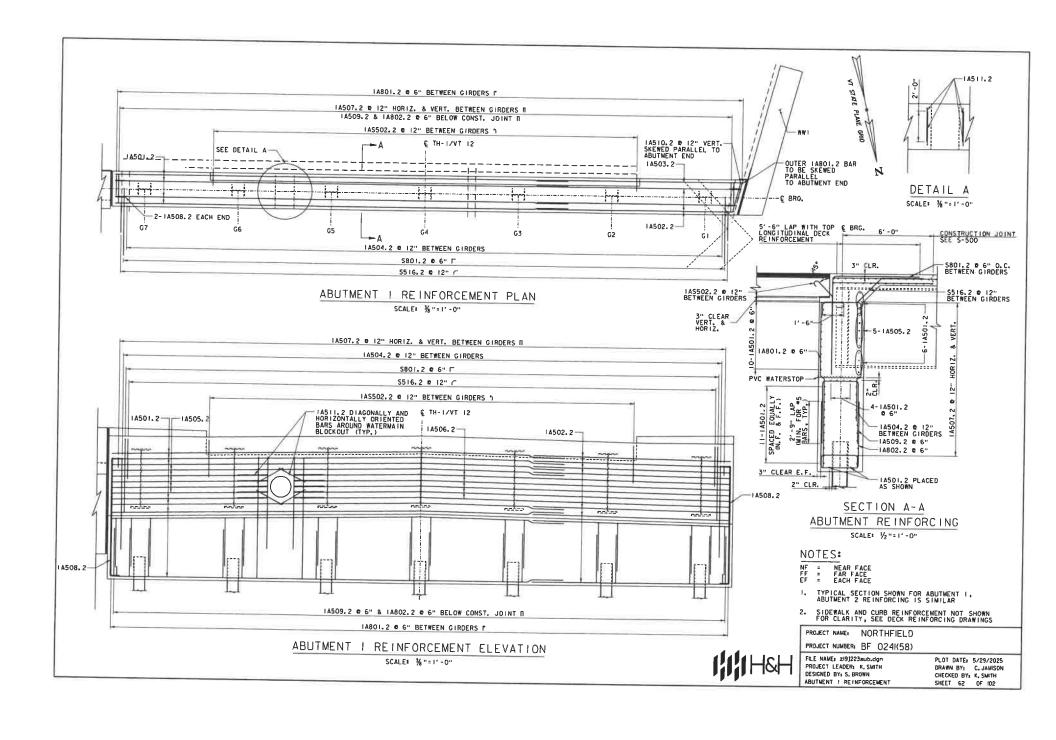

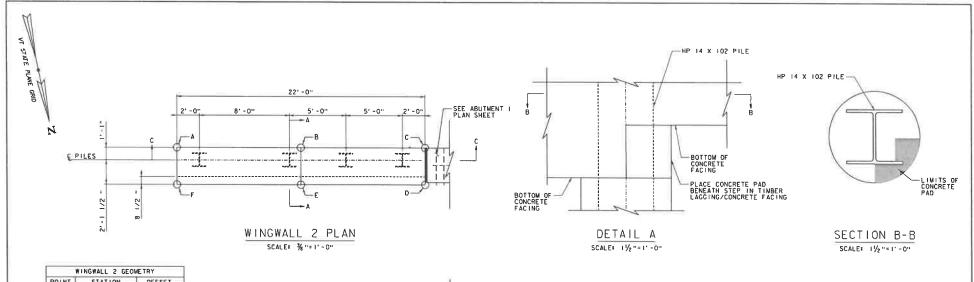

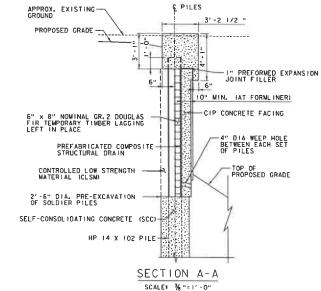


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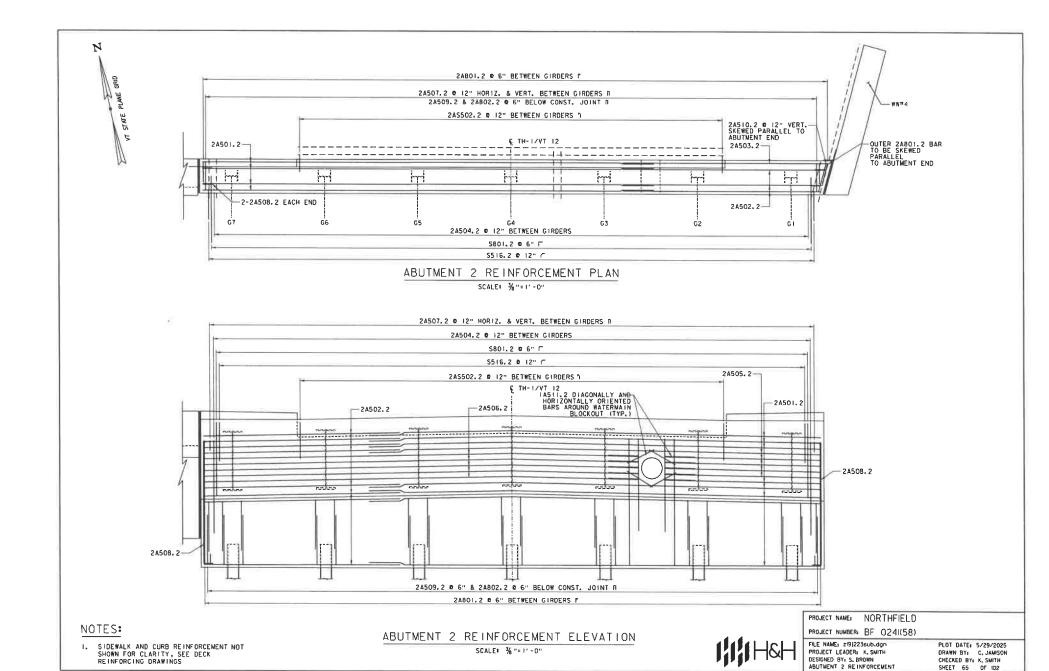
I. SEE "SOLD FER PILE WALL DETAILS 3" SHEET FOR SECTION C-C VIEW PROJECT NAME: NORTHFIELD
PROJECT NUMBER: BF 024(58)

IIIIH&H


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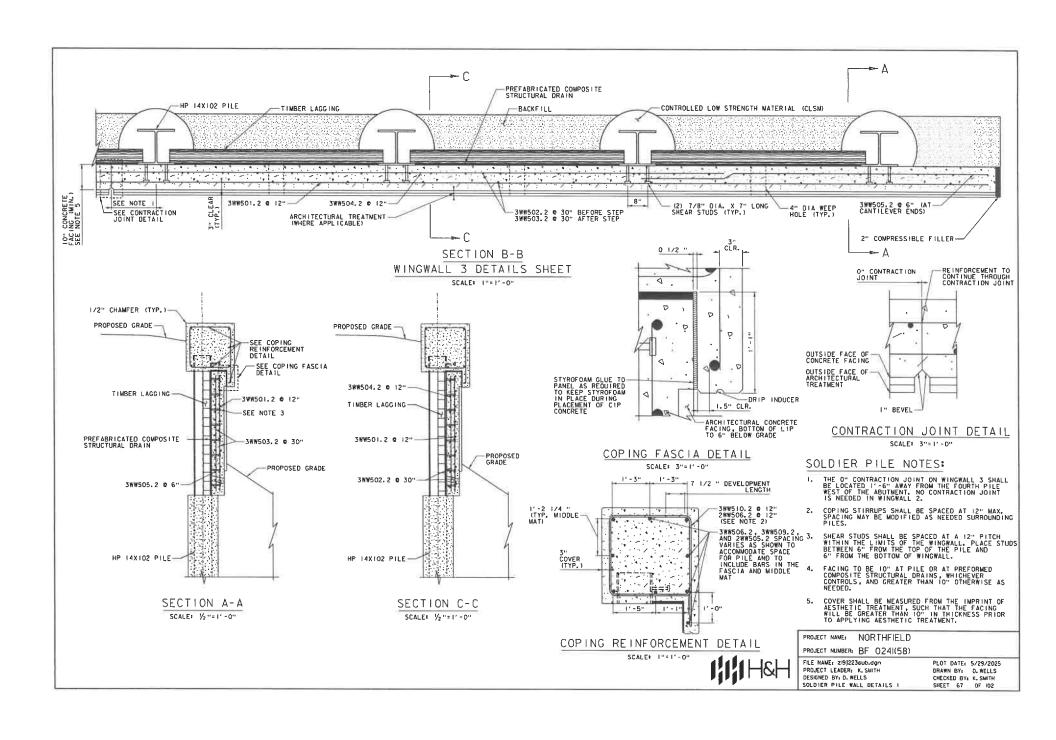
PLOT DATE: 5/29/2025 DRAWN BY: C. JAMISON CHECKED BY: K. SMITH SHEET 63 OF 102




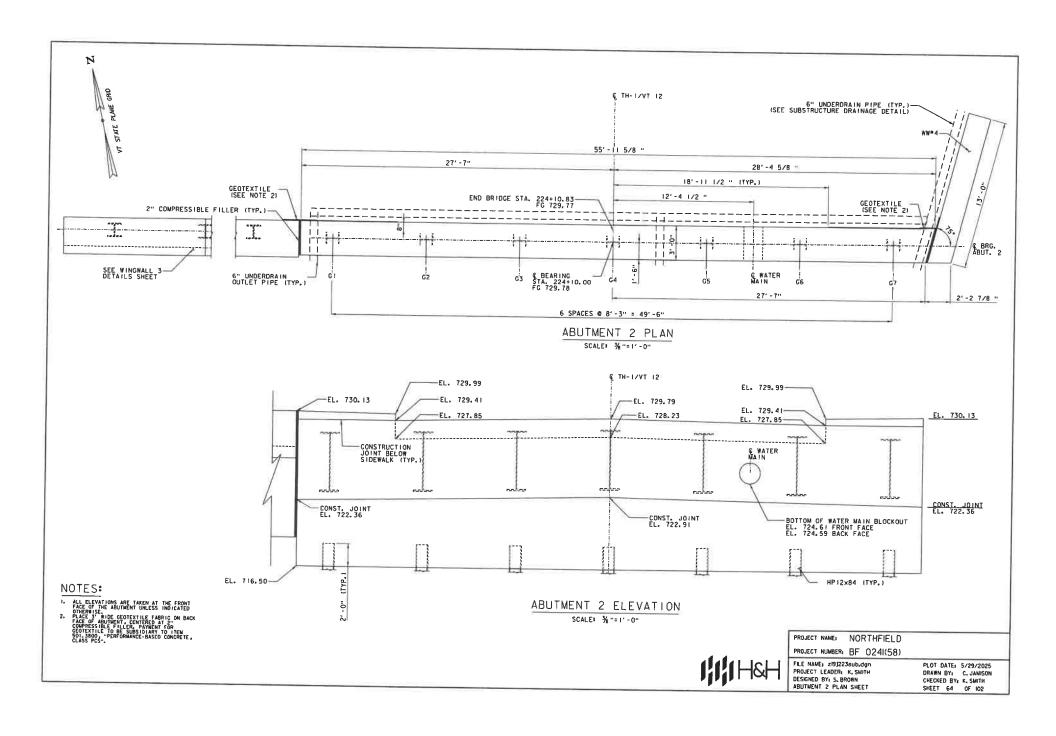



CHECKED BY: K. SMITH SHEET 65 OF 102




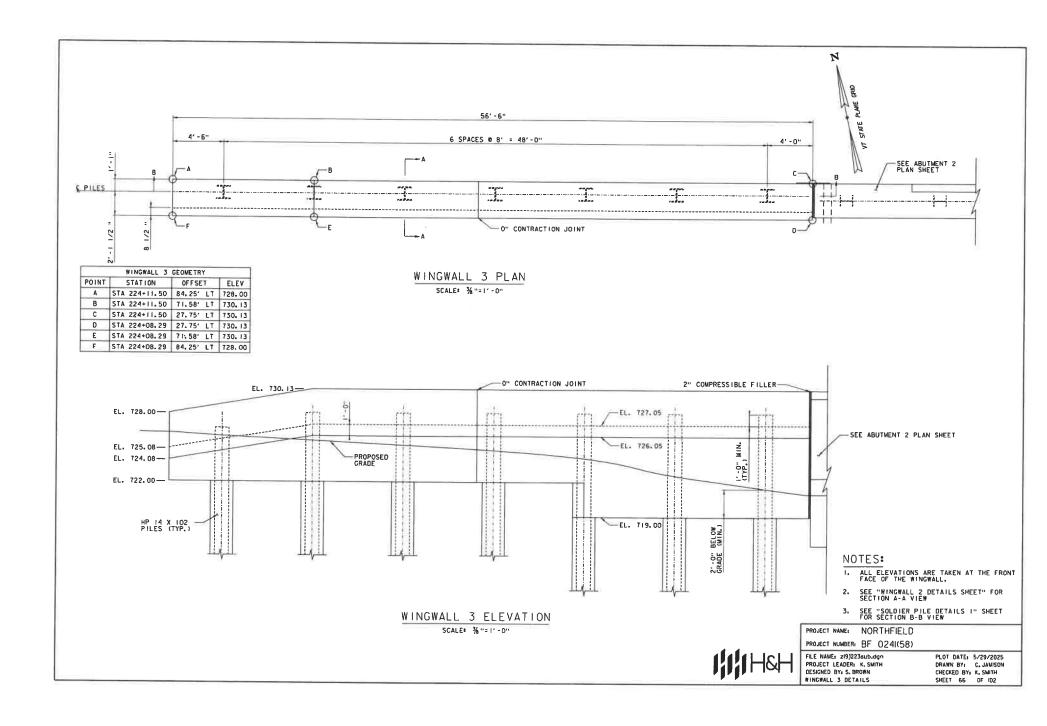


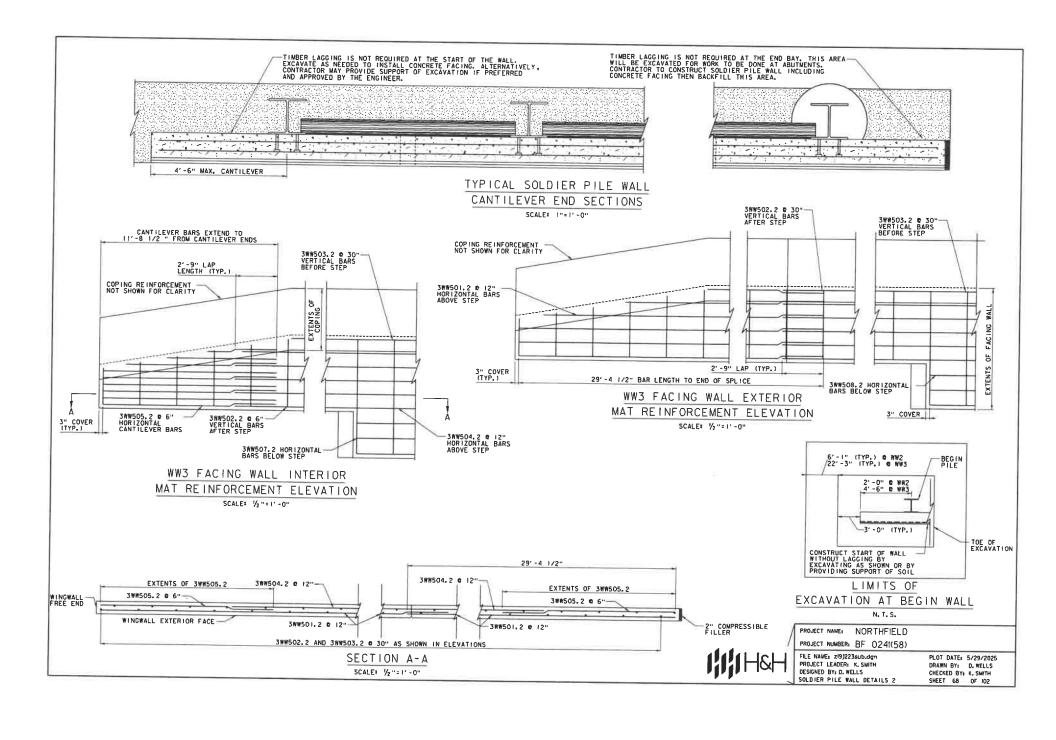


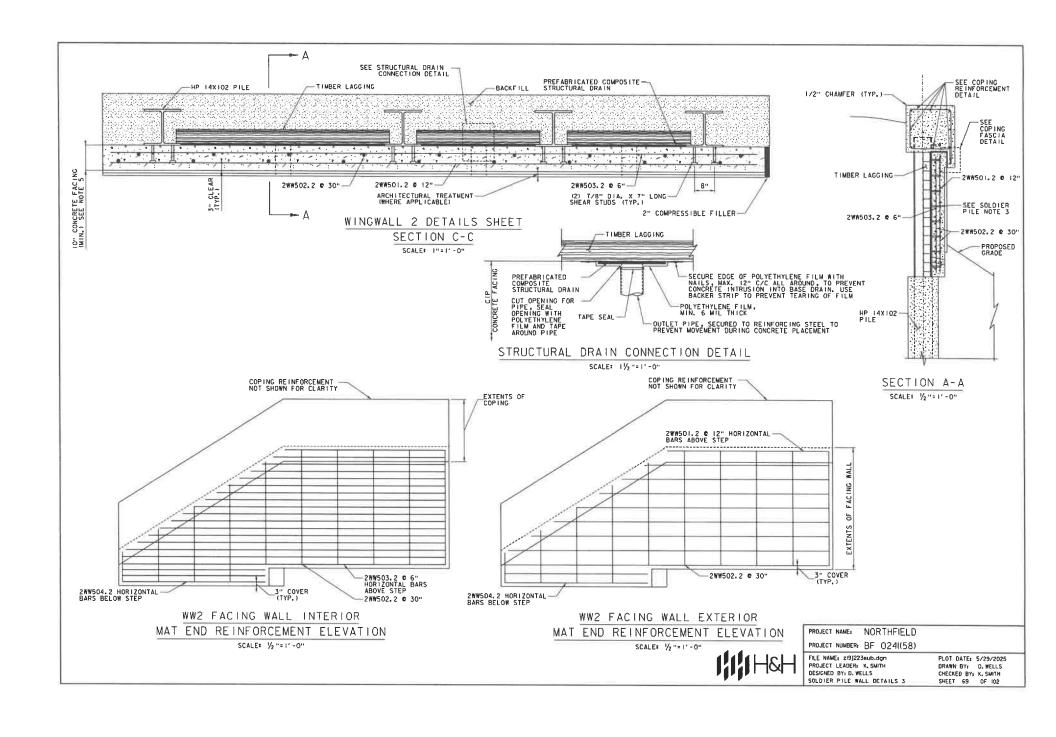


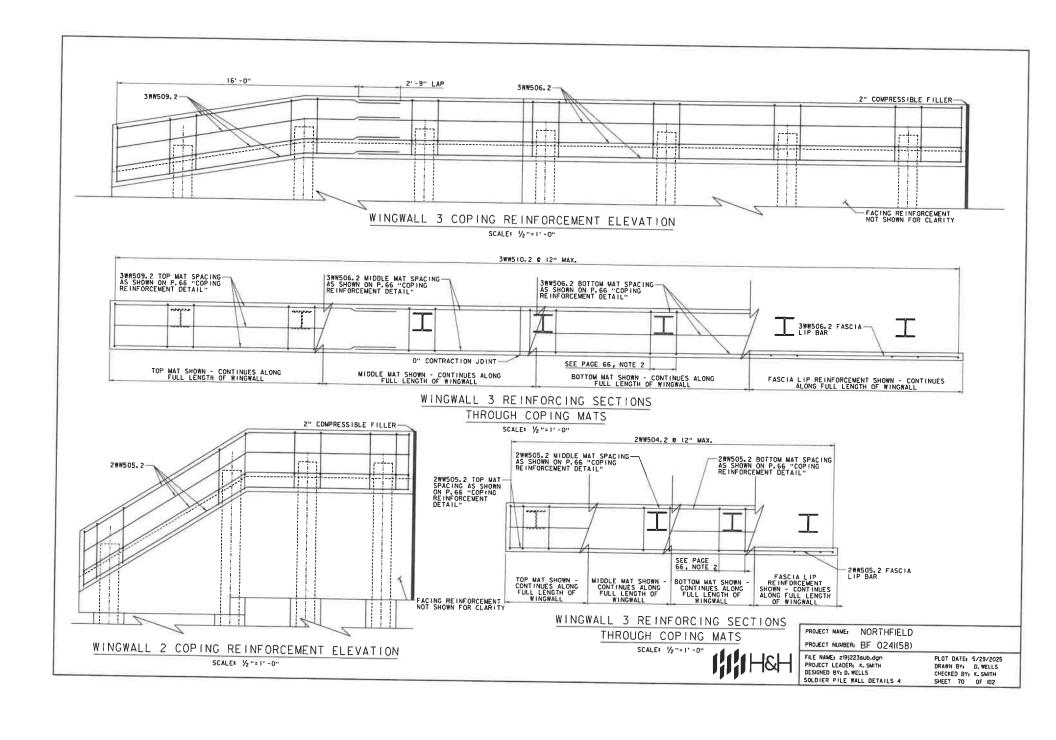


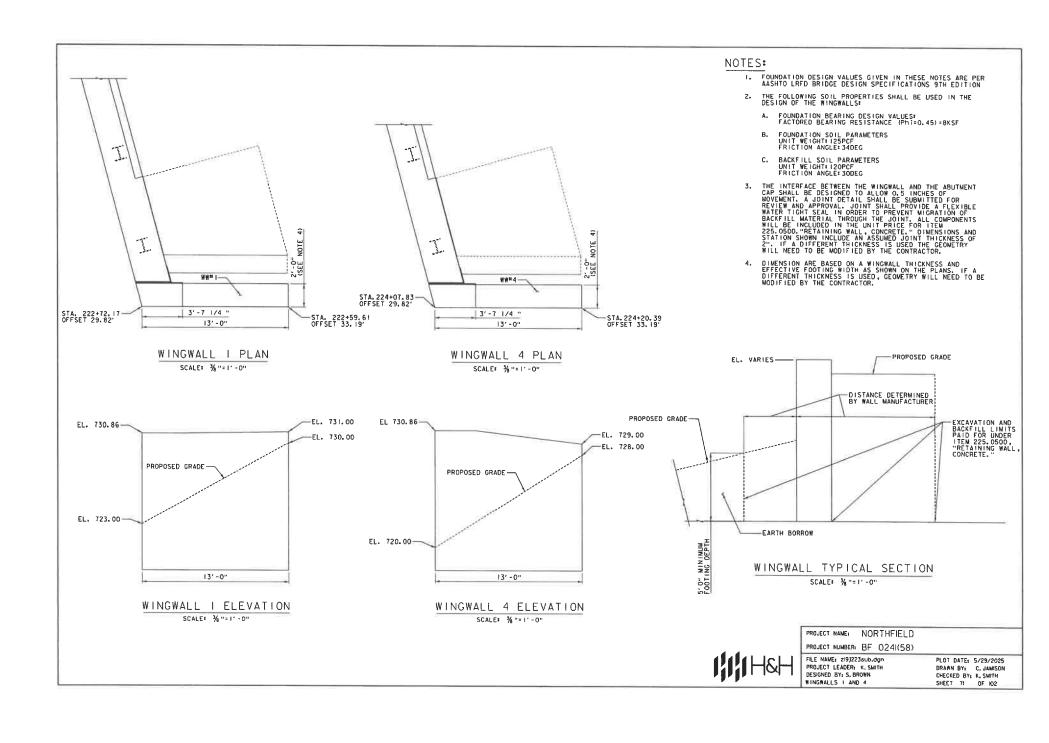

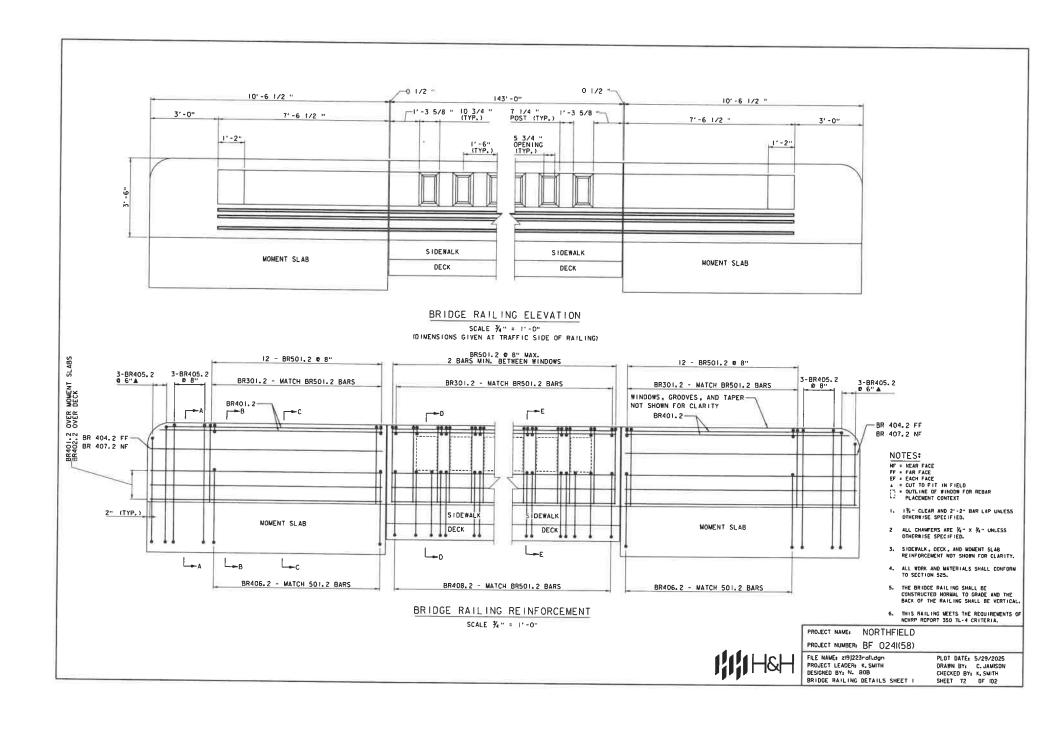


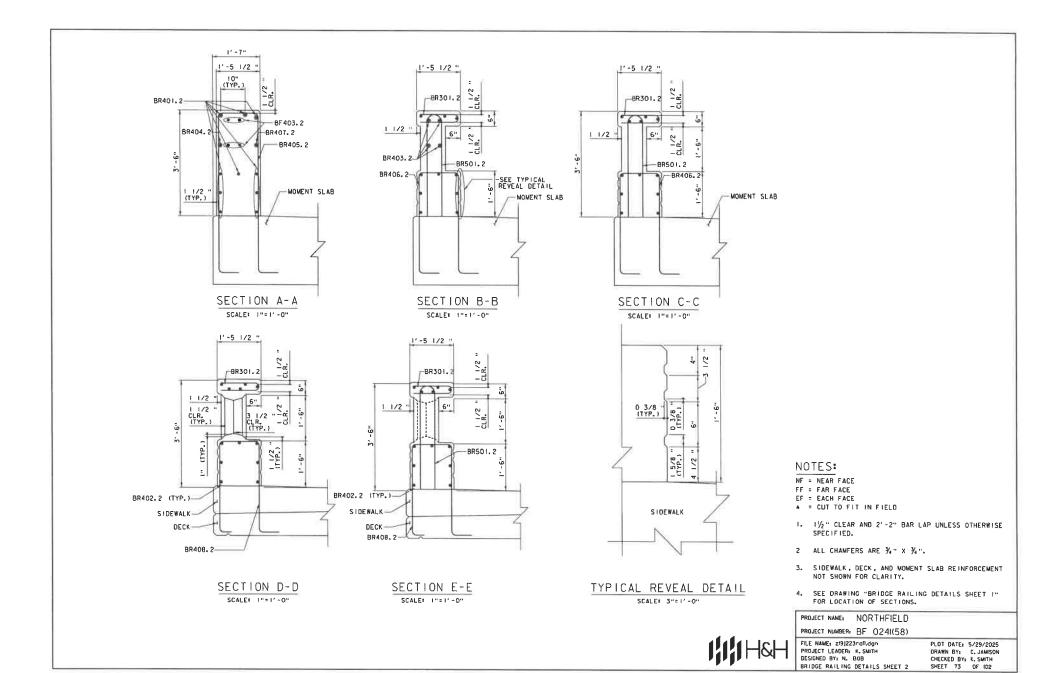

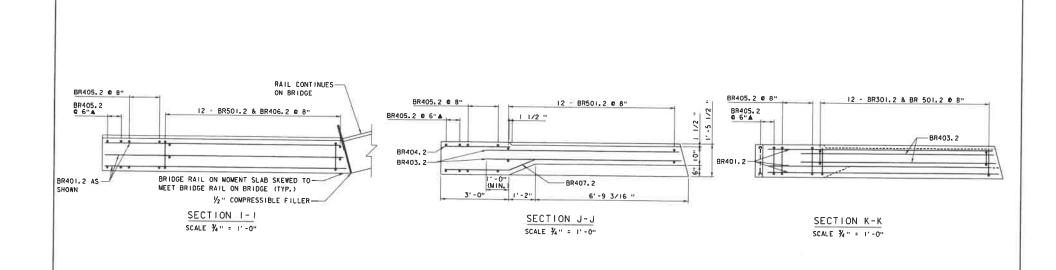


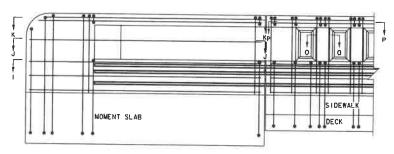

END OF BRIDGE RAILING
ELEVATION ON MOMENT SLAB
SCALE 11-0"

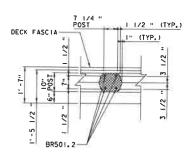

SECTION 0-0

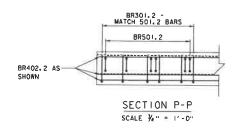




PROJECT NAME: NORTHFIELD
PROJECT NUMBER: BF 0241(58)

FILE NAME: z/9/223rdl.dgn PROJECT LEADER: K, SMITH DESIGNED BY: N. BOB BRIDGE RAILING DETAILS SHEET 3

PLOT DATE: 5/29/2025 DRAWN BY: C. JAMISON CHECKED BY: K. SMITH SHEET 74 OF IO2

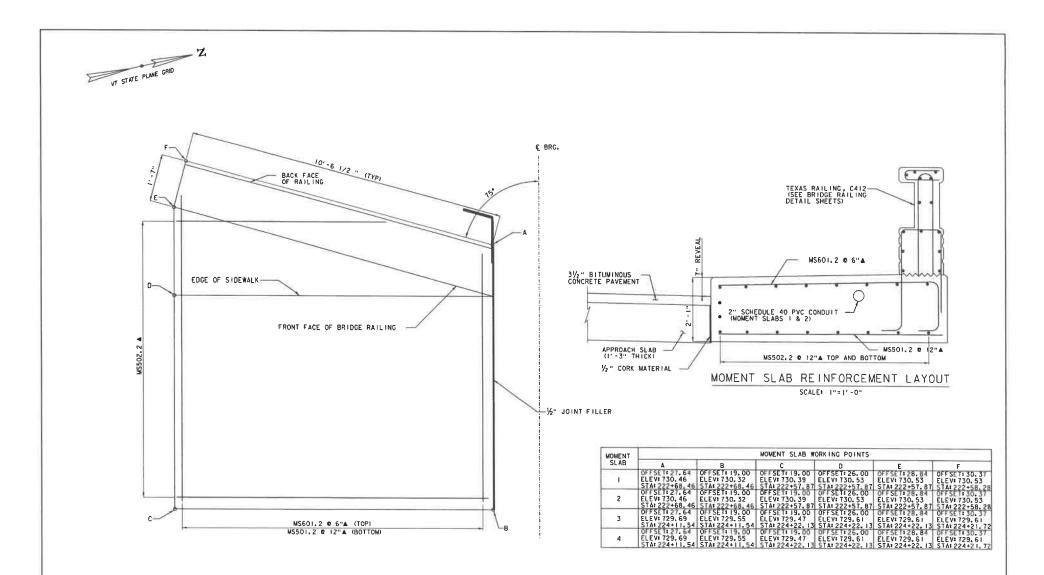

MOMENT SLAB PLAN

# LEGEND:


A DENOTES CUT IN FIELD

PROJECT NAME: NORTHFIELD

PROJECT NUMBER: BF 0241(58)
FILE NAME: zi91223sub.dgn

FILE NAME: z/9/2236ub.dgn PROJECT LEADER: K. SMITH DESIGNED BY: N. BOB MOMENT SLAB DETAILS SHEET PLOT DATE: 5/29/2025
DRAWN BY: C. JAMISON
CHECKED BY: K. SMITH
SHEET 75 OF 102

#### STATE OF VERMONT REINFORCING STEEL SCHEDULE AGENCY OF TRANSPORTATION TIEM EACH SIZE LENGTH MARK TYPE A B C D E F G H TIEM BACH SIZE LENGTH MARK TYPE A B C D E F G H J K R O J K N O ~ NOTES ~ DECK 1. UNLESS OTHERWISE DESIGNATED, ALL BAR REINFORCEMENT FOR CONCRETE IN SIZES UP TO AND INCLUDING NO. 18 44 6 6000 2A20012 STR 22 5 176 2 1 5 18 1 2 1 1 2 1 1 36'-10" 6'-7" 40'-0" 16'-8" \$501.2 STR \$502.2 STR \$503.2 STR SHALL CONFORM TO THE REQUIREMENTS OF THE "SPECIFICATIONS FOR DEFORMED BILLET STEEL BARS FOR CONCRETE REHIFORCEMENT", AASHTO M 31 (ASTM A 615-SI), ALL BARS SHALL BE GRADE 60, UZILESS OTHERWISE DESIGNATED. STR 85042 4-3 3-4 2-6 FOR TYPICAL BEIDING DETAILS, RECOMMENDED PIN DIAMETER TO OF BENDS AND HOOKS, AND OTHER STANDARD PRACTICE, SEE CURRENT CONCRETE REINFORCING STEEL HISTITUTE THANUAL OF STANDARD PRACTICE. 3. BARS WHICH REQUIRE MORE ACCURATE BEHINNIG THAN STANDARD PRACTICES SHOULD HAVE UNITS INDICATED. 4. ALL DIMENSIONS ARE OUT TO OUT OF BAR EXCEPT "A" AND "G" ON STANDARD 180 DEGREE AND 135 DEGREE HOOKS. 5. "If DIMENSION ON 180 DEGREE HOOKS TO BE SHOWN ONLY WHERE NECESSARY TO RESTRICT HOOK SIZE, OTHERWISE 105 8 13'-8' 2A801.2 21 1'-5' 1'-6' 10'-8' 102 8 13'-0' 2A802.2 \$10 5'-2' 2'-6' 5'-2' 1'-9' 1'-9' 2-2' 2-2' 6. "H" DIMENSION ON STIRRUPS TO BE SHOWN ONLY WHEN NECESSARY TO MAINTAIN CLEARANCES. 15117 15117 15117 15117 APPROACH SLAB 1 7. VIHERE SLOPE DIFFERS FROM 45 DEGREES, DINENSIONS "IT AND "K" MUST BE SHOWN 22 5 37-5" IEASS01 STR 54 5 5-7 1ASS02.2 11 0-11" 1-5" 0'-5" 2-9" 8. A DENOTES BARS TO BE CUT IN FIELD. 222 8 12'-5" S801.2 S10 8'-0" 6'-5" 9. * DENOTES DNE EXTRA BAR ADDED FOR TESTING PURPOSES. 0.0 0-11" .... 10. △ DENOTES TWO EXTRA BARS ADDED FOR TESTING PURPOSES APPROACH SLAB 2 # 429 3 2"-F BR301.2 S11 11. E IN SAR MARK PREFIX DENOTES EPOXY COATED REINFORCING STEEL. 1'-2' 4 10'-8" 4 30'-8" 4 8'-9" 4 2'-10" 4 12'-10" 45 9 19'-9" 2EAS901 1 1'-2" 18'-7" # 5 4 2 24 4 12-10° 48 4 8'-10' 4 4-1' 7-7' BR402,2 STR BR403,2 STR MOMENTSLAB 44 5 10-10" MS501.2 STR 0.0 0.6 0.0 1.2 0-6 ▲ 88 6 12'5' MS8012 \$10 0'-8" 1'-8" 10'-1" 429 5 7-3" BR501.2 S11 Ö Ž* WINGWALL 3 স্থা ABUTMENT 1 | 180 | 180 ASTM STANDARD - REINFORCING STEEL CORROSION RESISTANCE LEVEL ~ REINFORCING BARS THE REINFORCING STEEL MARKS IN THIS SCHEDILLE INDICATE THE REQUIREDBAR CORROSION RESISTANCE LEVEL DOPROSOON RESISTANCE LEVEL 1906 BLOTED WITH A 2 FOR LEVEL TWO SUFFIX OR, 3 FOR LEVEL THE SUFFIX IT FOR LEVEL ONE IS TO BE CHITTED. THE BAR MATERIAL TYPE AND BAR STEEL GRADE PROVIDED FOR EACH CORROSION LEVEL WILL BE RECORDED ON THE PLANSET HIS HEET FOR GREAT. ACCOST MANUAL DREVISIONS SCHOOL SECTION SECTIO *3 0.376 0.376 0.11 1.178 2'-6" 4'-3" 4 0.668 0.500 0.20 1,571 *5 1.043 0.625 0.31 1.963 46 1.502 0.750 0.44 2.356 17 2.044 0.875 0.60 2.749 48 2.670 1.000 0.79 3.142 9 3.400 1.128 1.00 3.644 *10 4.303 1.270 1.27 3.990 PROJECT NAME: NORTHFIELD *11 5.313 1.410 1.68 4.430 PROJECT NUMBER: BF 0241(58) *14 7.65 1.693 2.25 5.32 FILE NAME: zi9J223rebar.dgn PLOT DATE: 5/29/2025 18 13.80 2.267 4.00 7.09 PROJECT LEADER: K. SMITH DRAWN BY: C. JAMISON DESIGNED BY CHECKED BY: K. SMITH REINFORCING STEEL SCHEDULE SHEET 76 OF 102

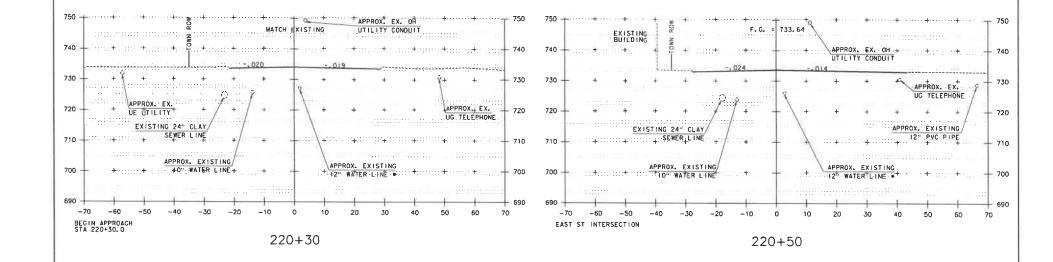

NOTE


 EARTHWORK ASSOCIATED WITH PROPOSED UNDERGROUND UTILITIES INSTALLATION BY OTHERS IS NOT PART OF THE SCOPE OF THIS PROJECT UNLESS OTHERWISE SHOWN.

2. APPROXIMATE LOCATION OF WATER UTILITY BUILT UNDER SEPARATE CONTRACT ASSUMED TO BE IN PLACE AT THE TIME OF THIS PROJECT'S CONSTRUCTION.

STA 220+30 TO STA 220+50


PROJECT NAME: NORTHFIELD
PROJECT NUMBER: BF 0241(58)

FILE NAME: z19J223xs.dgn PROJECT LEADER: K. SMITH DESIGNED BY: K. HO ROADWAY CROSS SECTIONS SHEET I PLOT DATE: 5/29/2025 DRAWN BY: T. MARQUETTE CHECKED BY: C. JENNE SHEET 77 OF 102

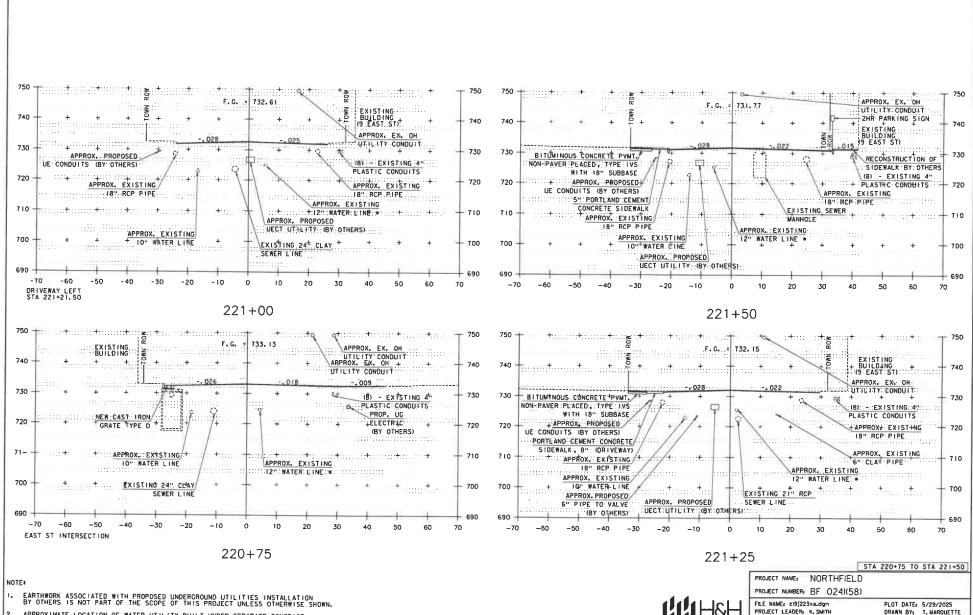


APPROXIMATE LOCATION OF WATER UTILITY BUILT UNDER SEPARATE CONTRACT ASSUMED TO BE IN PLACE AT THE TIME OF THIS PROJECT'S CONSTRUCTION.


DESIGNED BY: K. HO ROADWAY CROSS SECTIONS SHEET 2 DRAWN BY: T. MARQUETTE CHECKED BY: C. JENNE SHEET 78 OF 102

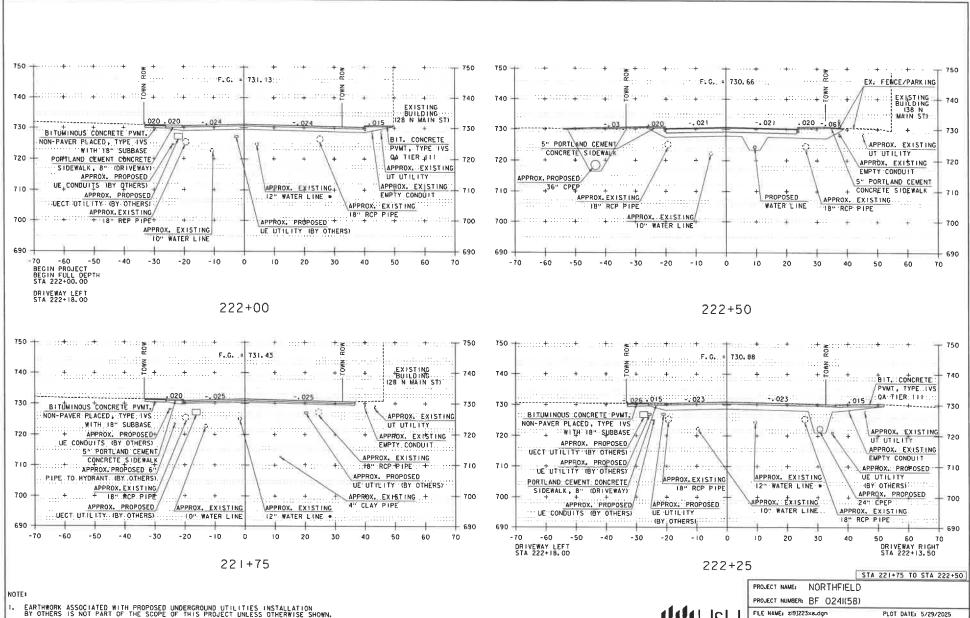



 APPROXIMATE LOCATION OF WATER UTILITY BUILT UNDER SEPARATE CONTRACT ASSUMED TO BE IN PLACE AT THE TIME OF THIS PROJECT'S CONSTRUCTION. HAH


FILE NAME: zi9J223xs.dgn PROJECT LEADER: K. SMITH DESIGNED BY: K. HO ROADWAY CROSS SECTIONS SHEET 3 PLOT DATE: 5/29/2025
DRAWN BY: T. MARQUETTE
CHECKED BY: C. JENNE
SHEET 79 OF 102

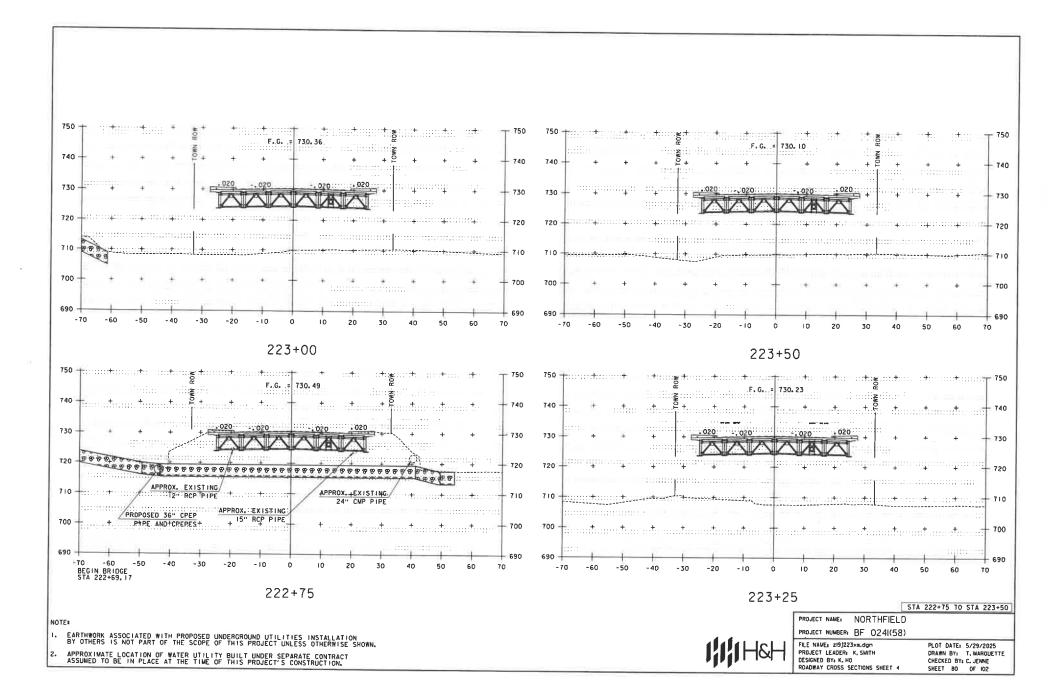


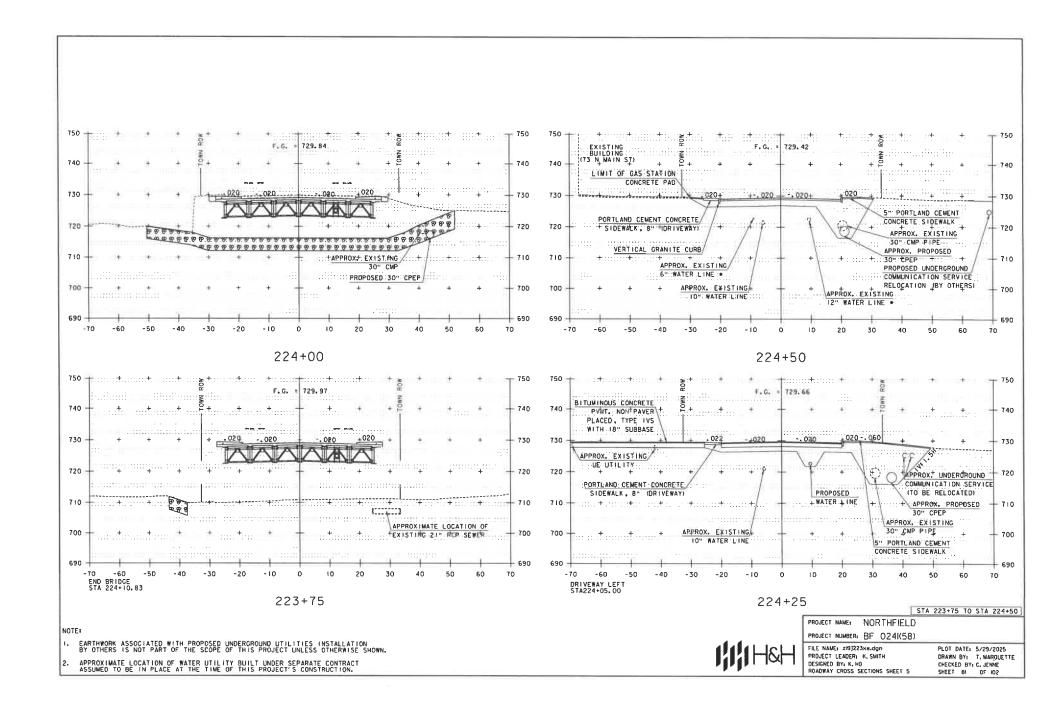

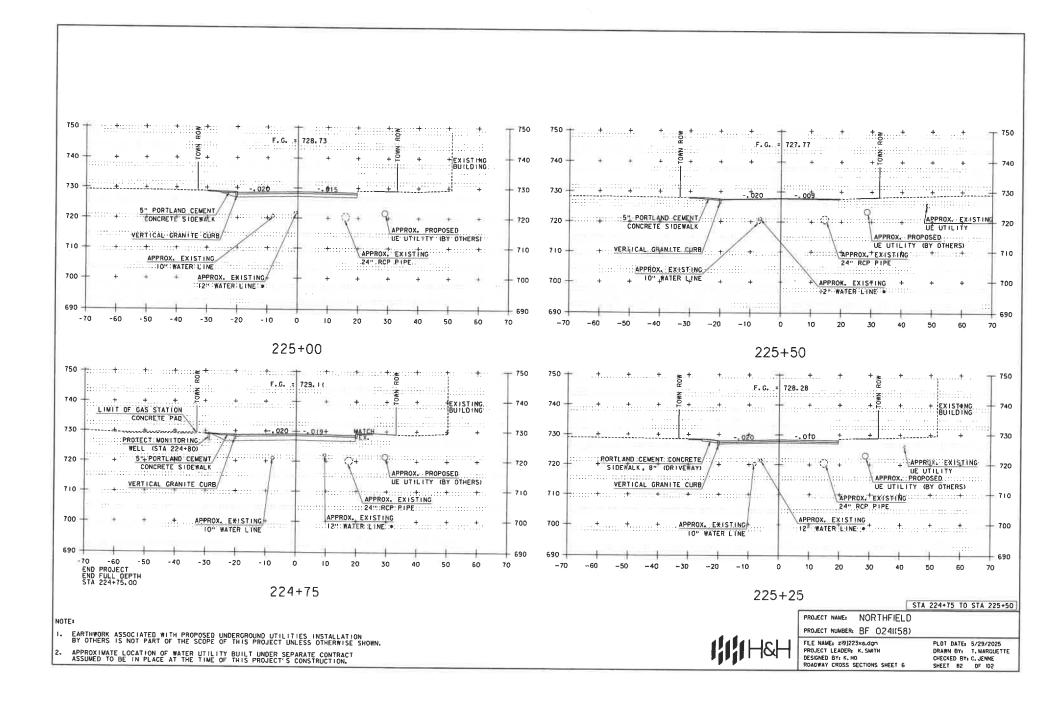

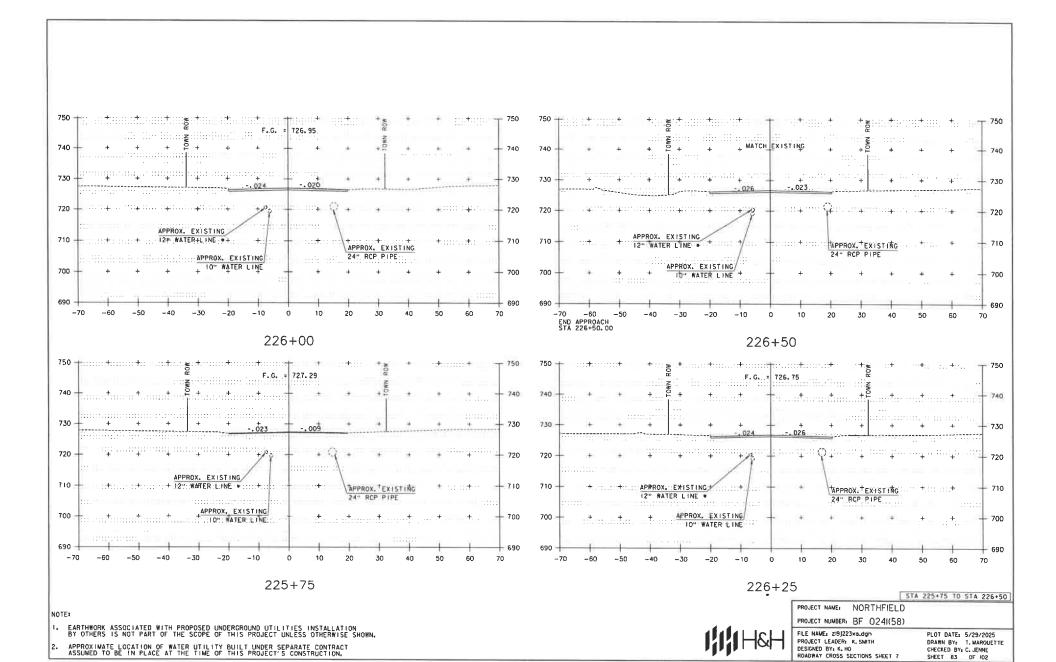

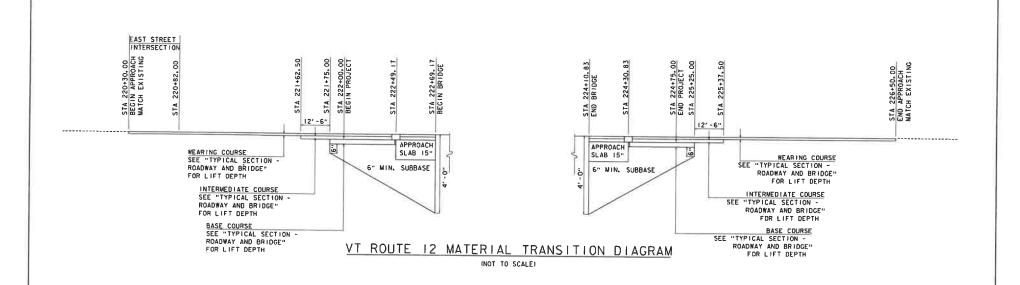

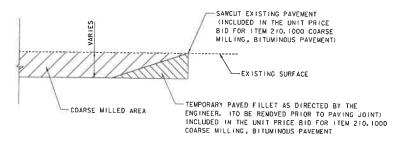

# DETAIL AT VERTICAL COARSE MILLING JOINTS


NOTE: THIS DETAIL SHALL BE USED AT THE LOCATIONS SHOWN ABOVE AS DIRECTED BY THE ENGINEER.



PROJECT NAME: NORTHFIELD PROJECT NUMBER: BF 0241(58)

FILE NAME: zi9J223m+d.dgn PROJECT LEADER: K. SMITH DESIGNED BY: K. HO MATERIAL TRANSITION DIAGRAM

PLOT DATE: 5/29/2025 DRAWN BY: T. MARQUETTE CHECKED BY: C. JENNE SHEET 84 OF 102

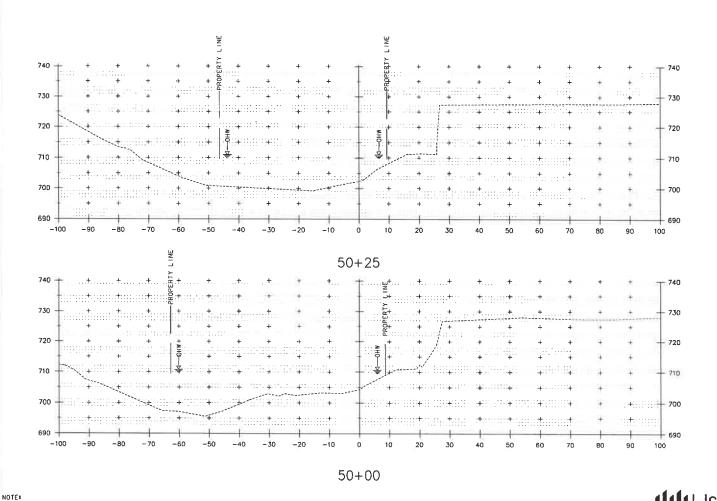


STA 50+00.00 TO STA 50+25.00

PROJECT NAME: NORTHFIELD

PROJECT NUMBER: BF 0241(58)

FILE NAME: zi9j223xs_channel.dgn PROJECT LEADER: K. SMITH DESIGNED BY: K. HO CHANNEL CROSS SECTIONS SHEET I PLOT DATE: 5/29/2025
DRAWN BY: T. MARQUETTE
CHECKED BY: C. JENNE
SHEET 85 OF 102

I. EARTHWORK ASSOCIATED WITH PROPOSED WALLS, BRIDGE AND DRAINAGE ELEMENTS ARE SHOWN SCHEMATICALLY AND FOR REFERENCE PURPOSES ONLY.

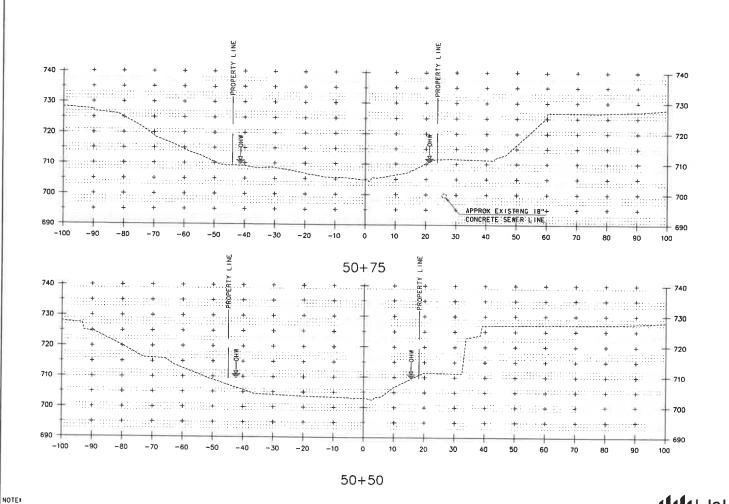

EARTHWORK ASSOCIATED WITH PROPOSED WALLS, BRIDGE AND DRAINAGE ELEMENTS ARE SHOWN SCHEMATICALLY AND FOR REFERENCE PURPOSES ONLY.


STA 50+50.00 TO STA 50+75.00


PROJECT NAME: NORTHFIELD

PROJECT NUMBER: BF 0241(58)

FILE NAME: zi9j223×s_channel.dgn PROJECT LEADER: K, SMITH DESIGNED BY: K, HO CHANNEL CROSS SECTIONS SHEET 2

PLOT DATE: 5/29/2025 DRAWN BY: T. MARQUETTE CHECKED BY: C. JENNE SHEET 86 OF 102

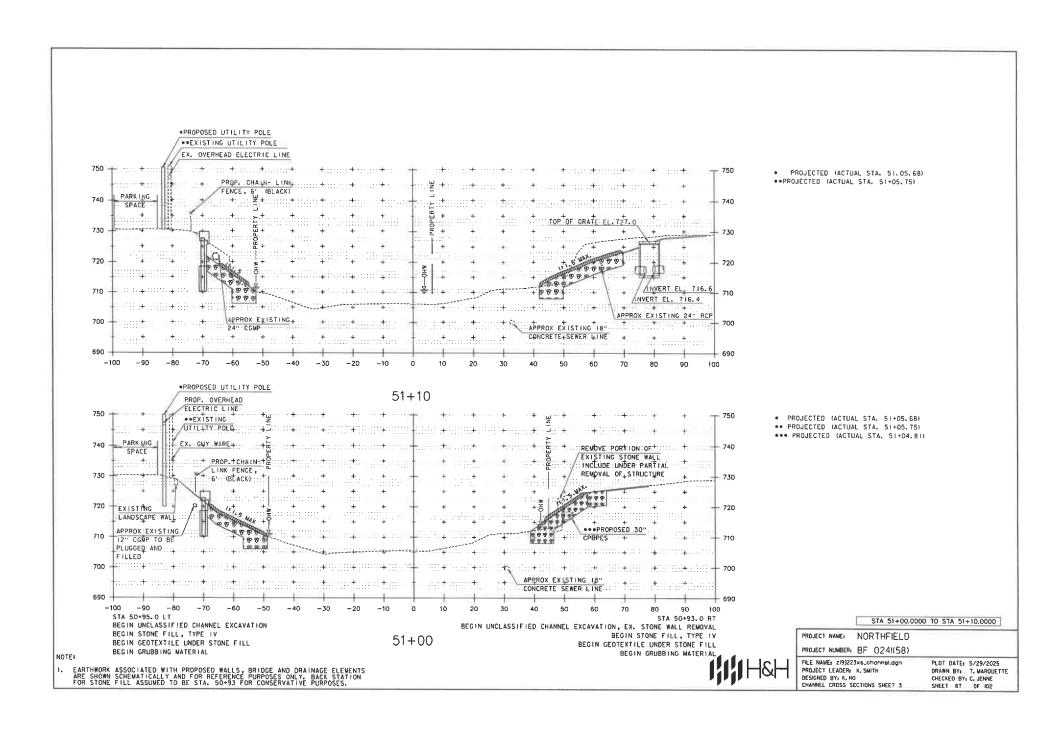

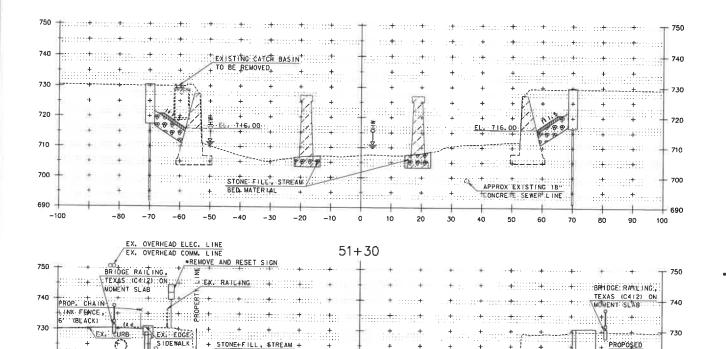

* SEE SIGN AND LINE TABLE SHEET FOR DETAIL

STA 51+20.0000 TO STA 51+30.0000

PROJECT NAME: NORTHFIELD

PROJECT NUMBER: BF 0241(58)

24" - CPEP

- 690

FILE NAME: zi9J223xs_channel.dgn PROJECT LEADER: K. SMITH DESIGNED BY: K. HO CHANNEL CROSS SECTIONS SHEET 4 PLOT DATE: 5/29/2025
DRAWN BY: T. MARQUETTE
CHECKED BY: C. JENNE
SHEET B8 OF 102

51 + 20

-20

+ 8.8+8

CONCRETE SEWER LINE.

STONE FILL, STREAM

APPROX EXISTING 18" + APPROX EXISTING 24 + RCP / + + 700

NOTE:

720

690

-100

APPROX EXISTING

-9D

~80

EARTHWORK ASSOCIATED WITH PROPOSED WALLS, BRIDGE AND DRAINAGE ELEMENTS ARE SHOWN SCHEMATICALLY AND FOR REFERENCE PURPOSES ONLY.


+ + + EXECUNDERGROUND: +

ELECTRIC LINE

(51 DEPTHESHOWN) +

-50

BED MATERIAL

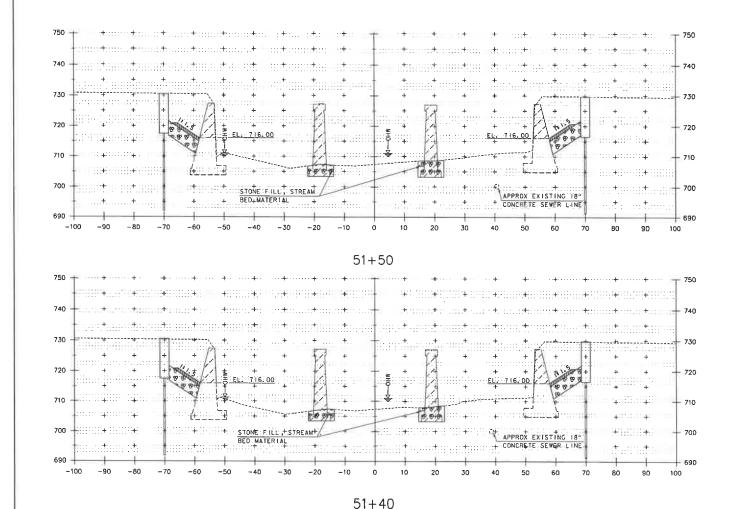

NOTE:


EARTHWORK ASSOCIATED WITH PROPOSED WALLS, BRIDGE AND DRAINAGE ELEMENTS ARE SHOWN SCHEMATICALLY AND FOR REFERENCE PURPOSES ONLY.

STA 51+40.0000 TO STA 51+50.0000

PROJECT NAME: NORTHFIELD

PROJECT NUMBER: BF 0241(58)

FILE NAME: zi9j223xs.channel.dgn PROJECT LEADER: K. SMITH DESIGNED BY: K. HO CHANNEL CROSS SECTIONS SHEET 5 PLOT DATE: 5/29/2025 DRAWN BY: T. MARQUETTE CHECKED BY: C. JENNE SHEET 89 OF 102

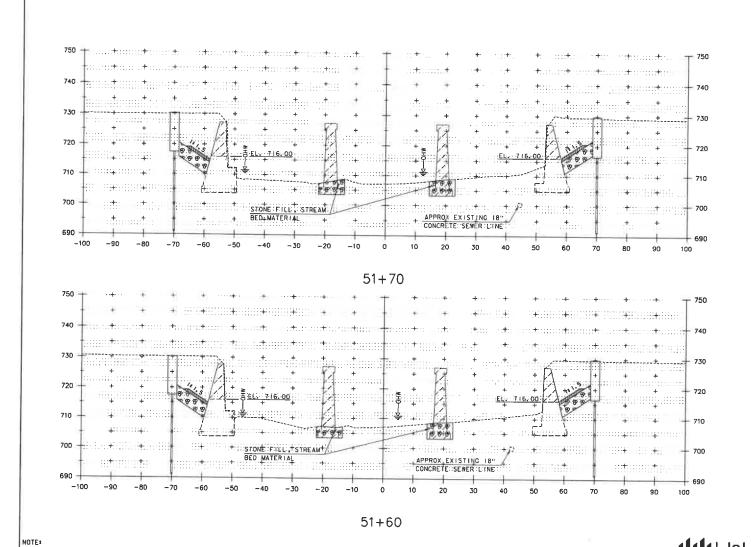


STA 51+60,0000 TO STA 51+70,0000


PROJECT NAME: NORTHFIELD

PROJECT NUMBER: BF 0241(58)


FILE NAME: zi9J223xs_channel.dgn PROJECT LEADER: K. SMITH DESIGNED BY: K. HO CHANNEL CROSS SECTIONS SHEET 6 PLOT DATE: 5/29/2025
DRAWN BY: T. MARQUETTE
CHECKED BY: C. JENNE
SHEET 90 OF 102

I. EARTHWORK ASSOCIATED WITH PROPOSED WALLS, BRIDGE AND DRAINAGE ELEMENTS ARE SHOWN SCHEMATICALLY AND FOR REFERENCE PURPOSES ONLY.

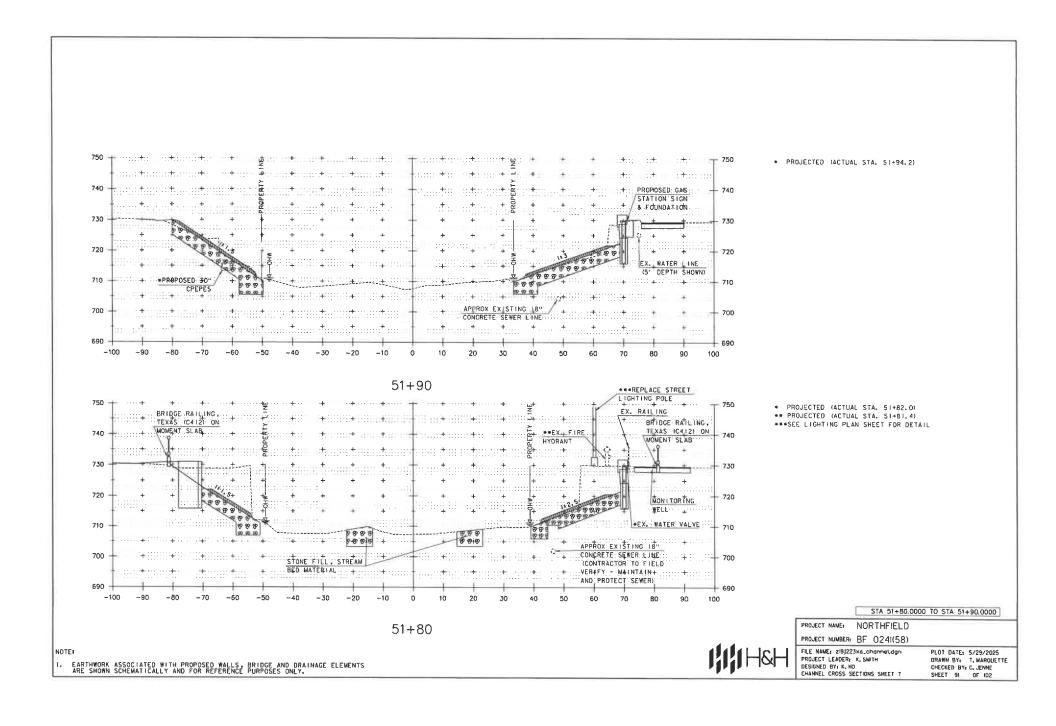

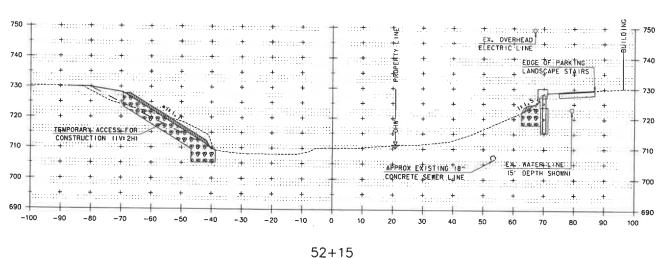

■ 1: 1.5 SLOPE MEASURED NORMAL TO CONTOUR

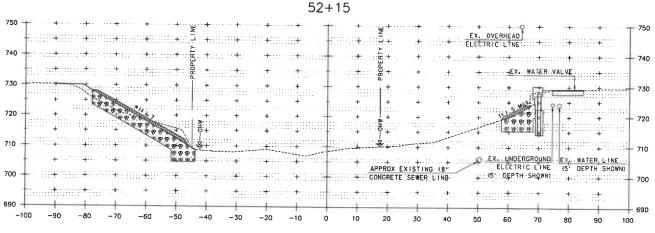

. It 1.5 SLOPE MEASURED NORMAL TO CONTOUR

STA 52+00.00 TO STA 52+15.00

PROJECT NAME: NORTHFIELD


PROJECT NUMBERI BF 0241(58)


FILE NAME: 2193223xs_channel.dgn PROJECT LEADER: K, SMITH DESIGNED BY: K, HO CHANNEL CROSS SECTIONS SHEET B PLOT DATE: 5/29/2025 DRAWN BY: T. MARQUETTE CHECKED BY: C. JENNE SHEET 92 OF IO2

52 + 00

NOTE

I. EARTHWORK ASSOCIATED WITH PROPOSED WALLS, BRIDGE AND DRAINAGE ELEMENTS ARE SHOWN SCHEMATICALLY AND FOR REFERENCE PURPOSES ONLY.

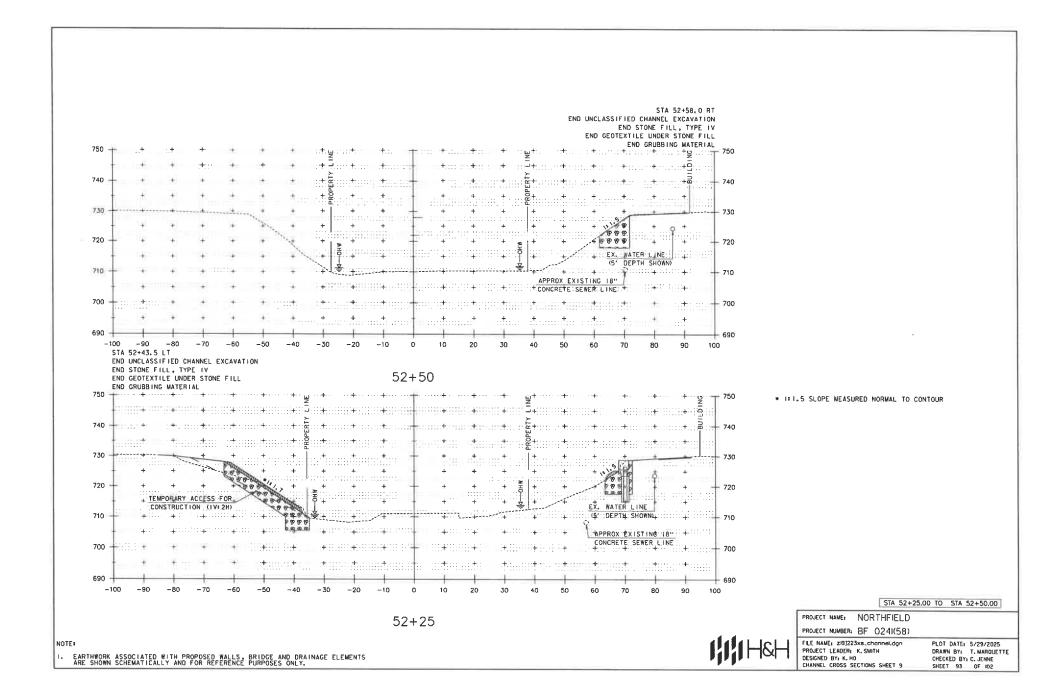

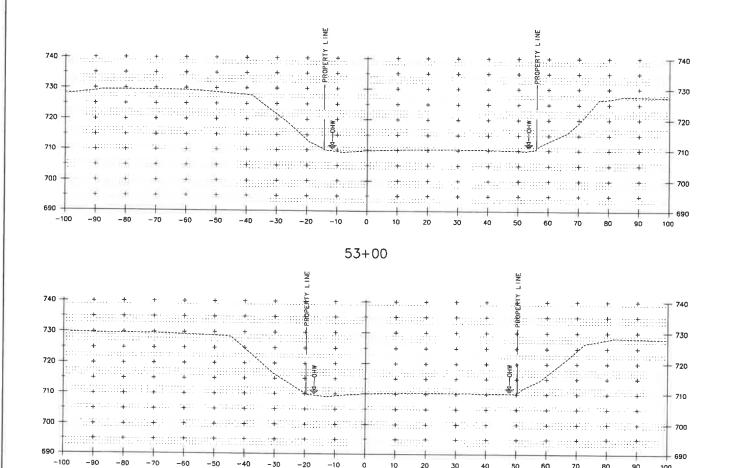

52 + 75

STA 52+75.00 TO STA 53+00.00

PROJECT NAME: NORTHFIELD

PROJECT NUMBER: BF 0241(58)

FILE NAME: 219J223xs_channel.dgn PROJECT LEADER: K. SMITH DESIGNED BY: K. HO CHANNEL CROSS SECTIONS SHEET IO PLOT DATE: 5/29/2025 DRAWN BY: T. MARQUETTE CHECKED BY: C. JENNE SHEET 94 OF 102

NOTE:

. EARTHWORK ASSOCIATED WITH PROPOSED WALLS, BRIDGE AND DRAINAGE ELEMENTS ARE SHOWN SCHEMATICALLY AND FOR REFERENCE PURPOSES ONLY.

# **EPSC PLAN NARRATIVE**

#### 1. PROJECT DESCRIPTION

THIS PROJECT INVOLVES THE REPLACEMENT OF BRIDGE 60 WITH RELATED ROADWAY APPROACH WORK.
BRIDGE 60 OVER DOG RIVER IS LOCATED IN THE TOWN OF NORTHHELD, ON YT ROUTE 12,
APPROXIMATELY 1.1 MILES NORTH OF THE JUNCTION WITH YT ROUTE 12A SOUTH. THE PROJECT
LOCATION BEGINS AT MILE POST 4.197 (STA 2224-00.00) AND ENISS AT MILE POST 4.249 (STA 2224-75.00).

THE NEW STRUCTURE WILL BE APPROXIMATELY 141.66 FEET IN LENGTH WITH 133.34 FEET OF ROADWAY WORK, CONSTRUCTED ON NEW FOOTINGS ALONG THE SAME ALIGNMENT.

NOTE: APEA OF DISTURBANCE INCLUDES LIMITS OF EARTH DISTURBANCE WITHIN THE PROJECT AREA, AS WELL AS WASTE, BORROW AND STAGING AREAS, AND OTHER EARTH DISTURBING ACTIVITIES WITHIN OR DIRECTLY ADJACENT TO THE PROJECT LIMITS AS SHOWN ON THE ATTACHED EPSC PLAN.

IT IS ANTICIPATED THAT CONSTRUCTION WILL LAST ONE CONSTRUCTION SEASON.

#### 2. AMOUNT OF DISTURBANCE & RISK EVALUATION

TOTAL AREA OF DISTURBANCE AS SHOWN ON THE ATTACHED EPSC PLAN IS APPROXIMATELY 0.92 ACRES.

THE MAXIMUM CONCURRENT EARTH DISTURBANCE USED TO SCORE THIS PROJECT IN APPENDIX A RISK ASSESSMENT IS 2 OF ACRES

ANY MODIFICATIONS TO THE PROJECT THAT INCREASE THE RISK TO ENVIRONMENTAL RESOURCES SHALL BE EVALUATED IN ACCORDANCE WITH THE PERMIT REQUIREMENTS. THE CONTRACTOR WILL BE RESPONSIBLE FOR ANY ADDITIONAL PERMITTING.

#### 3. MAJOR COMPONENTS & SEQUENCING

THE CONTRACTOR SHALL SEQUENCE CONSTRUCTION ACTIVITIES TO MINIMIZE THE EXTENT OF DISTURBED SOILS LEFT OPEN TO EROSION AT ANY GIVEN TIME. PROJECT DEMARCATION FENCING WILL BE INSTALLED AT THE PROJECT LIMITS. REOSION PREVENTION AND SEDMENT CONTROLS WILL BE UTILIZED, AS SHOWN IN THE PLANS, THROUGHOUT THE DURATION OF CONSTRUCTION. THE EXISTING SUPERSTRUCTURE AND PORTIONS OF THE EXISTING AUDITARIEST AND PRESS WILL BE REMOVED. ECKANATION AND GRADNING WILL TAKE PLACE AT THE PROPOSED ABUTMENTS. WATER DIVERSION AND DEWATERING WILL BE UTILIZED BY THE CONTRACTOR TO ACCESS THE EXISTING PIERS. DESTING PAVENETH AND ROADWAY MASS WILL BE EXCAVATED AND REPLACED WITH THE PROPOSED ROADWAY AT THE APPROACHES. PROPOSED UTILITIES WILL BE PLACED CONCURRENTLY WITH THE PROPOSED ROADWAY AT THE APPROACHES. PILES AND PLECAPS WILL BE INSTALLED, FOLLOWED BY THE STEEL BEAMS, PECK, AND APPROACH SLABS.
FOLLOWING FINAL GRADING, TURF WILL BE ESTABLISHED ON DISTRUBED AREAS, PROPOSED SIDEWALKS WILL BE INSTALLED, AND PAVENENT WILL BE PLACED. LASTLY, ALL EROSION PREVENTION AND SEDIMENT CONTROL TEXTS WILL BE POWERD.

#### 4. SITE DESCRIPTION

#### 4.1 VEGETATED BUFFERS

MAINTAINING VEGETATED BUFFERS ALONG STREAM BANKS, WETLANDS OR OTHER SENSITIVE AREAS IS A CRUCIAL EROSION AND SEDIMENT CONTROL MEASURE THAT SHOULD BE IMPLEMENTED WHEREVER POSSIBLE.

THIS PROJECT DOES NOT RELY ON VEGETATED BUFFERS AS A MITIGATING RISK FACTOR.

#### 4.2 STREAM CROSSINGS

THIS PROJECT INCLUDES (1) STREAM CROSSINGS, AS DESCRIBED IN SECTION 5.1 BELOW. WORK WITHIN THE WATER IS BEING AUTHORIZED THROUGH THE VANR DEC RIVER MANAGEMENT PROGRAM AND THE US ARMY CORPS OF FROIRFERS.

#### 4.3 WETLANDS

THERE ARE NO WETLANDS OR WETLAND BUFFERS BEING IMPACTED WITHIN THE PROJECT LIMITS.

#### 4.4 TOPOGRAPHY

THE TOPOGRAPHY OF THE PROJECT AREA IS GENERALLY FLAT. THE BRIDGE IS LOCATED IN A DOWNTOWN VILLAGE SETTING, WITH A CROSSWALK LOCATED AT THE NORTH OF THE BRIDGE AND ON-STREET PARKING LOCATED JUST OFF THE SOUTH END OF THE BRIDGE RESILED BETWEEN DRIVEWAYS, COMMERCIAL BUSINESSES WITH PAVED PARKING LOTS ARE LOCATED JALONG THE SOUTHWEST AND NORTHWEST QUADRANTS. THERE IS A COMMERCIAL BUSINESS WITH CORRESPONDING DRIVEWAY LOCATED JUST OUTSIDE OF THE PROJECT LIMITS IN THE NORTHEAST GUADRANT.

#### 4.5 VEGETATION

THE VEGETATION IN THE PROJECT AREA CONSISTS OF INTENTIONALLY PLANTED AND NATURALLY OCCURING DECIDIOUS TREES, SHRUBS, AND HERBAGEOUS GROWNH. THERE IS MOWED GRASS FRONTAGE ALONG THE SOUTHEAST AND NORTHEAST QUADRAMTS, THE IMPACT TO VEGETATION WILL BE LIMITED TO THAT WHICH IS DIRECTLY AFFECTED BY THE PROJECT. UPON COMPLETION, THE DISTURBED VEGETATION SHALL BE RESTABLISHED WITH LIVE STAKES, DECIDIOUS TREES AND SHRUBS, SEED, AND MULCH PER THE LANDSCAPE PLAN.

#### 4.6 SOILS

ALL SOIL DATA CAME FROM THE U.S. DEPARTMENT OF AGRICULTURE NATURAL RESOURCES CONSERVATION SERVICE. SOILS ON THE PROJECT SITE INCLUDE:
MACHIAS FINE SANDY LOAM, 3 TO 8 PERCENT SLOPES, "K FACTOR" = 0.20
COLTON GRAVELLY SANDY LOAM, 3 TO 8 PERCENT SLOPES, "K FACTOR" = 0,17

ADDITIONALLY, THERE ARE CONTAMINATED SOILS AND POTENTIAL HAZARDOUS WASTE WITHIN THE PROJECT LIMITS. PER VIANR HAZARDOUS SITES LIST, HAZARDOUS SITES ARE LOCATED IN THE NORTHHERST AND SOUTHWEST QUADRANTS OF THE PROJECT, AND A HAZARDOUS WASTE GENERATOR IS LOCATED IN THE NORTHEAST QUADRANT. THERE IS ALSO AN UNDERGROUND STORAGE TANK LOCATED IN THE NORTHWEST QUADRANT. IN A BOTTION, THE ENTIRE PROJECT SITE IS LOCATED WITHIN A MAPPED LIRBAN SOILS BACKGROUND AREA. THE DISTURBANCE OF SOILS WITHIN THE PROJECT AND THE METTHOO BY WHICH THEY ARE HANDLED, TRANSPORTED, AND DISPORD OF WILL BE IN COMPLIANCE WITH THE SOIL MANAGEMENT PLANT THAT HAS BEEN PREPARED FOR THIS PROJECT.

NOTE: K-VALUES GENERALLY INDICATE THE FOLLOWING: 0.0-0.23 = LOW EROSION POTENTIAL 0.24-0.36 = MODERATE EROSION POTENTIAL 0.37 AND HIGHER = HIGH EROSION POTENTIAL

# 4.7 OTHER SENSITIVE RESOURCES

WHILE BRIDGE 60 IS NOT A HISTORICALLY SIGNIFICANT STRUCTURE, IT IS LOCATED WITHIN THE VERMONT STATE REGISTER-LISTED DEPOT SQUARE HISTORIC DISTRICT. THERE CONTRIBUTING BUILDINGS TO THE DEPOT SQUARE HISTORIC DISTRICT ARE LOCATED AT THE SOUTHEASTERN CORNER OF THE BRIDGE: 38 NORTH MAIN STREET, AND 9 EAST STREET. THE CONTRACTOR SHALL NOT TEMPORABILLY OF REPRIAMENTLY IMPACT ANY OF THESE PROPERTIES DURING CONSTRUCTION OF THIS PROJECT. IF ANY OF THE AFOREMENTIONED PROPERTIES ARE AFFECTED, SECTION 4(F) REVIEW WILL BE NECESSARY UNDER FHWA REGULATION 23 CFR 774. THE NEW STRUCTURE'S DESIGN, MATERIALS, MASSING, RAULING AND ANY OTHER PERMANENT FEATURES SHALL BE COMPATIBLE WITH THE HISTORIC DISTRICT.

#### 5. DRAINAGE

## 5.1 RECEIVING WATERS

DOG RIVER, A WATER-CURSE REGULATED BY THE US ARMY CORPS OF ENGINEERS, IS A NORTH-FLOWING TRIBUTARY OF THE WINODSKI RIVER, AND IS THE ONLY WATER SOURCE ON THE PROJECT SITE, MINICIPAL WATER SUPPLIES WATER TO RESIDENCES AND BUSINESSES IN THE IMMEDIATE VICINITY OF THE MINICIPAL PLODG RIVER IS PRONE TO A MODERATE TO HIGH DEBRIS LOAD, AND THE STREAM BED CONSISTS OF GRAVEL, COBBLES AND BOULDERS. THE TRIBUTARY AREA AT THE BRIDGE CROSSING IS 96, MILES?

# 5.2 DISCHARGE POINTS

THIS PROJECT HAS THREE DISCRETE DISCHARGE POINTS WHICH CORVEY RUNOFF FROM WITHIN THE CURBED AREAS OF THE ROADWAY INTO THE RECEIVING WATER FROM DRAINGE OUTFALLS. OUTSIDE OF THE CURBED AREAS, ALL WATER FROM THE PROJECT AREA DRAINS TOWARD THE RIVER AND ENTERS THE RECEIVING WATER IN MULTIPLE LOCATIONS IN THE AREAS DIRECTLY ADJACENT TO THE BRIDGE.

# 5.3 CONVEYANCE/FLOW PATH FROM PROJECT TO WATERS

A PORTION OF THE PROJECT IS NOT CURRED AND RUNGEF DRAINS OVERLAND ACROSS ADJACENT VEGETATED SIDE SLOPES BEFORE REACHING THE DOG RIVER. FOR THE REMAINING CURRED SEGMENTS, THERE EXIST A NUMBER OF DROP INLETS THAT COLLECT ROADWAY RUNGEF WHICH DRAIN TO OUTFALLS IN THE SOUTHWEST, NORTHEAST AND SOUTHEAST QUADRANTS VIA 24" DRAINAGE PIPES THAT EXTEND TOWARDS THE DOG RIVES TREAMBANK.

#### 6. EROSION PREVENTION AND SEDIMENT CONTROL MEASURES

THE MEASURES INCLUDED IN THIS PLAN ARE PROVIDED AS A GUIDELINE FOR PREVENTING EROSION AND CONTROLLING SEDIMENT TRANSPORT. IT IS EXPECTED THAT THE CONTRACTOR MAY USE THIS PLAN, WITH ADJUSTMENTS AS NECESSARY, BASED ON THEIR SPECIFIC MEANS AND METHODS OF CONSTRUCTION.

APPLYING THESE MEASURES THROUGHOUT CONSTRUCTION IS CRITICAL TO THEIR SUCCESS IN MINIMIZING SEDIMENT TRANSPORT TO THE RECEIVING WATERS. REFER TO THE DETAILS INCLUDED IN THESE PLANS AND THE DEPARTMENT OF ENVIRONMENTAL CONSERVATION'S VERMONT STANDARDS AND SPECIFICATIONS FOR EROSION PREVENTION AND SEDIMENT CONTROL FOR SPECIFIC GUIDANCE.

## 6.1 IDENTIFY LIMITS OF DISTURBANCE

SITE BOUNDARIES AND AREAS CONSTRUCTION EQUIPMENT CAN ACCESS SHALL BE DELINEATED.

PROJECT DEMARCATION FEMCING (PDF) SHALL BE USED TO PHYSICALLY MARK SITE BOUNDARIES. BARRIER FENCE SHALL BE USED INSTEAD OF PROJECT DEMARCATION FENCE WITHIN 100 FEET OF A WATER RESOURCE (STREAM, BROOK, LAKE, POND, WETLAND, ETC.)

#### 6.2 LIMIT CONCURRENT DISTURBANCE

LIMITING THE AMOUNT OF SOIL EXPOSED AT ONE TIME REDUCES THE POTENTIAL EROSION ON SITE. CONCURRENT EARTH DISTURBANCE CAN BE MINIMIZED THROUGH CONSTRUCTION PHASING BY ONLY OPENING UP EARTH AS NECESSARY AND EMPLOYING STABILIZATION PRACTICES IN INCREMENTAL STAGES AS PHASES CHANGE.

# 6.3 STABILIZE DISTURBED AREAS

#### 6.3.1 ACCESS POINTS/ENTRANCE/EXITS

TRACKING OF SEDMENT ONTO PUBLIC HIGHWAYS SHALL BE MINIMIZED TO REDUCE THE POTENTIAL FOR RUNOFF ENTERING RECEIVING WATERS. INSTALLATION SHALL COINCIDE WITH THE CONTRACTORS PROGRESS SCHEDULE.

STABILIZED CONSTRUCTION ENTRANCES ARE ANTICIPATED ON THIS PROJECT AND SHALL BE LOCATED AS SHOWN ON THIS EPSO FLAN AND ANYWHERE EQUIPMENT WILL BE GOING FROM AREAS OF EXPOSED SOILS TO PAYED SUPRACES.

#### 6.3.2 TEMPORARY MEASURES FOR EXPOSED AREAS DURING CONSTRUCTION

ALL AREAS OF EARTH DISTURBANCE MUST HAVE STABILIZATION IN PLACE WITHIN 14 DAYS OF INITIAL DISTURBANCE. AFTER THIS TIME, DISTURBED AREAS MUST BE STABILIZED IN ADVANCE OF ANY RUNOFF PRODUCING EVENT.

SURFACE ROUGHENING OF EXPOSED SLOPES, SEEDING OF TEMPORARY SLOPES AND STOCKPILES, AND STANDARD MULCHING PRACTICES DESCRIBED IN SPECIFICATION SECTION 653.07 SHALL BE UTILIZED TO TEMPORARILY STABILIZE DITUREDS AREAS.

#### 6.3.3 PERMANENT STABILIZATION AT FINAL GRADE

EXPOSED SOIL MUST BE STABILIZED WITHIN 48 HOURS OF REACHING FINAL GRADE.

SEED, MULCH, FERTILIZER AND LIME SHALL BE USED TO ESTABLISH PERMANENT VEGETATION. FOR SLOPES STEEPER THAN 1:3, ROLLED EROSION CONTROL PRODUCT, TYPE I SHALL BE USED INSTEAD OF MULCH,

CONTRACT ITEM 613.13 - STONE FILL, TYPE IV SHALL BE USED TO ARMOR THE CHANNEL BANK IN THE VICINITY OF BRIDGE ABUTMENTS AND WINGWALL SLOPES.

## 6.4 DIVERT UPLAND RUNOFF

DIVERSIONARY MEASURES SHALL BE USED TO INTERCEPT RUNOFF FROM ABOVE THE CONSTRUCTION AND DIRECT IT AROUND THE DISTURBED AREA SO THAT CLEAN WATER DOES NOT BECOME MUDDIED WHILE TRAVELING OVER THE OPENS SOILS ON THE CONSTRUCTION SITE.

THE PROJECT AREA IS RELATIVELY FLAT; HOWEVER, YT ROUTE 12 SOUTH OF THE PROJECT AREA DRAINS TOWARD THE PROJECT AREA. RUNOFF FROM THESE AREAS MAY NEED TO BE DIVERTED AWAY FROM THE PROJECT AREA. THE CONTRACTOR SHALL REFER TO THE LOW RISK HAMDBOOK FOR GUIDAMY F.

# 6.5 INSTALL SEDIMENT BARRIERS

SEDIMENT BARRIERS SHALL BE UTILIZED TO INTERCEPT RUNOFF AND ALLOW SUSPENDED SEDIMENT TO SETTLE OUT. THEY SHALL BE INSTALLED ON THE DOWNHILL SIDE OF CONSTRUCTION ACTIVITIES, PRIOR TO ANY UP-SLOPE WORK.

IN-WATER SEDIMENT ISOLATION DEVICE SHALL BE ANY MEASURE WHICH EFFECTIVELY SEPARATES SEDIMENTS OR POLLUTANTS FROM WATERS OF THE STATE AS DEFINED IN THE VERMONT WATER QUALITY STANDARDS.

SILT FENCE WILL BE INSTALLED ALONG THE CONTOURS AND AS PROPOSED ON THE EPSC PLAN, WOVEN WIRE REINFORCED SILT FENCE SHALL BE USED INSTEAD OF SILT FENCE WITHIN 100 FEET UPSLOPE OF RECEIVING WATERS.



PROJECT NAME: NORTHFIELD
PROJECT NUMBER: BF 0241(58)

FILE NAME: z/9/223epsc_norrotive.dgn PROJECT LEADER: K. SMITH DESIGNED BY: K. HO EPSC NARRATIVE SHEET I PLOT DATE: 5/29/2025
DRAWN BY: T. MARQUETTE
CHECKED BY: C. JENNE
SHEET 95 OF IO2

## 6.6 SLOW DOWN CHANNELIZED RUNOFF

CHECK STRUCTURES SHALL BE UTILIZED TO REDUCE THE VELOCITY, AND THUS THE EROSIVE POTENTIAL, OF CONCENTRATED FLOW IN CHANNELS.

TERMPORARY STONE CHECK DAMS ARE NOT ANTICIPATED TO BE NEEDED AS DESIGNED SINCE THE STREAMBED WITHIN THE PROJECT AREA IS RELATIVELY PLAT, AND THE CHANNEL'S FLOW VELOCITY DOES NOT WARRANT THER I.SF.

#### 7. CONSTRUCT PERMANENT CONTROLS

PERMANENT STORMWATER TREATMENT DEVICES SHALL BE INSTALLED AS SHOWN ON THE PLANS AND IN ACCORDANCE WITH PERMIT CONDITIONS.

PERMANENT STORMWATER TREATMENT DEVICES ARE NOT ANTICIPATED TO BE NEEDED AS DESIGNED.

#### 8. DEWATERING

DISCHARGE FROM DEWATERING ACTIVITIES THAT FLOWS OFF OF THE CONSTRUCTION SITE MUST NOT CAUSE. OR CONTRIBUTE TO A VIOLATION OF THE YERMONT WATER QUALITY STANDARDS. DEWATERED STORNWATER OR GROUNDWATER MUST BE FILTERED AND ROUTED IN A MANNER THAT DOES NOT RESULT IN YISBLY TURBID DISCHARGES TO WATERS.

DEWATERING OF SURFACE WATER WITHIN THE COFFERDAM IS ANTICIPATED. THE FILTER BAG DETAIL AND PAY ITEM HAVE BEEN INCLUDED AS A POTENTIAL TREATMENT MEASURE FOR THIS PURPOSE, HOWEVER THE SPECIFIC MEANS FOR TREATMENT OF DISCHARGE SHALL BE PROVIDED BY THE CONTRACTOR. ALL COSTS FOR TREATMENT OF DISCHARGE SHALL BE PAID FOR UNDER CONTRACT ITEM 653.45.

#### 9. OFF-SITE AREAS

OFF-SITE WASTE AND BORROW AREAS HAVE NOT BEEN IDENTIFIED FOR THIS PROJECT. IT WILL BE THE CONTRACTORS RESPONSIBILITY TO IDENTIFY AND PERMIT, AS NECESSARY, ANY OFF-SITE AREAS THAT ARE NEEDED IN ACCORDANCE WITH STANDARD SPECIFICATIONS 105.25 - 105.26. ALL EROSION PREVENTION AND SEDIMENT CONTROL MEASURES RECESSARY FOR WASTE, BORROW, AND STADING AREAS OUTSIDE THE PROJECT LIMITS SHALL BE PAID FOR PER 105.29 OF THE STANDARD SPECIFICATIONS FOR CONSTRUCTION.

VEHICLE AND EQUIPMENT STORAGE AREAS OR AREAS ADJACENT TO CONSTRUCTION TRAILERS OR OTHER HIGH TRAFFIC AREAS SMALL BE COVERED WITH GEOTEXTILE FABRIC AND 12" OF GRAVEL. FOLLOWING COMPLETION OF CONSTRUCTION, ALL NON-NATIVE MATERIALS SHALL BE REMOVED FROM THE STAGING AREA. COMPACTED, RUTTED, OR OTHERMISE DISTURBED SOILS SHALL BE TILLED, RAKED, SEEDED AND MULCHED.

ERODIBLE MATERIALS STOCKPILED WITHIN THE MATERIAL STORAGE AREAS SHALL BE ISOLATED WITH SILT FENCE OR OTHER ACCEPTABLE SEDIMENT BARRIER. SOIL STOCKPILED ON THE SITE SHALL BE SEEDED AND ANII CHED.

### 10. WINTER CONSTRUCTION

CONSTRUCTION ACTIVITIES MAY CONTINUE INTO THE WINTER CONSTRUCTION SEASON, DEPENDING ON ACTUAL FIELD AND WEATHER CONDITIONS. IF ACTIVITIES ARE ON-GOING BETWEEN OCTOBER 15 AND APRIL 15, THE CONTRACTOR SHALL FOLLOW REQUIREMENTS FOR WINTER CONSTRUCTION, AS DEFINED IN SPECIFIC PERMIT CONDITIONS AND AS FOLLOWS:

- ENLARGED ACCESS POINTS, STABILIZED TO PROVIDE FOR SNOW STOCKPILING.
- LIMITS OF DISTURBANCE MOVED OR REPLACED TO REFLECT BOUNDARY OF WINTER WORK.
- DEVELOPMENT OF A SNOW MANAGEMENT PLAN THAT INCLUDES:
- ADEQUATE STORAGE AND CONTROL OF MELT-WATER
- STORAGE OF CLEARED SNOW TO BE PLACED DOWN SLOPE OF DISTURBED AREAS AND OUT OF STORAWATER TREATMENT STRUCTURES
- AREAS OF DISTURBANCE WITHIN 100 FT OF A WATERBODY MUST HAVE REINFORCED (WOVEN WIRE)
  SILT FENCE INSTALLED ACROSS THE SLOPE, DOWNGRADIENT OF THE EARTH DISTURBANCE.
  ALTERNATIVELY, REGULAR, NON-WOVEN WIRE SILT FENCE MAY BE USED IF COMBINED WITH EROSION
  CONTROL BERM, EROSION LOG, OR STRAW WATTLE.
- DRAINAGE STRUCTURES MUST BE KEPT OPEN AND FREE OF SNOW AND ICE DAMS.
- SILT FENCE AND OTHER PRACTICES REQUIRING EARTH DISTURBANCE MUST BE INSTALLED AHEAD OF FROZEN GROUND.
- MULCH TO BE APPLIED AT A MINIMUM OF 2 INCHES DEPTH WITH 80-90% COVERAGE.
- AREAS OF DISTURBED SOILS MUST BE STABILIZED PRIOR TO ANY RUNOFF-PRODUCING EVENT, WITH THE FOLLOWING EXCEPTION:
- STABILIZATION IS NOT REQUIRED IF THE WORK IS OCCURRING IN A SELF-CONTAINED EXCAVATION
  WITH NO OUTLET AND A DEPTH OF 2 FT OR GREATER (OPEN UTILITY TRENCHES), PROVIDED THAT
  ANY DEWATERING, IF NECESSARY, IS CONDUCTED AS REQUIRED.
- PRIOR TO STABILIZATION, SNOW OR ICE MUST BE REMOVED TO LESS THAN 1" THICKNESS.
- USE STONE TO STABILIZE AREAS WHERE CONSTRUCTION VEHICLE TRAFFIC IS ANTICIPATED.

#### 11. INSPECTION & MAINTENANCE

INSPECTION AND MONITORING OF THE PROJECT'S EPSC MEASURES SHALL BE CONDUCTED IN ACCORDANCE WITH STANDARD SPECIFICATION 653.04 MONITORING EROSION PREVENTION AND SEDIMENT CONTROL PLAN, ALONG WITH FERRIT SPECIFIC RESPECTION REQUIREMENTS.

THE CONTRACTOR SHALL PROVIDE A COPY OF THEIR INSPECTION FORM AS PART OF THEIR EPSC PLAN,


ALL EPSC MEASURES SHALL BE REGULARLY MAINTAINED AND SHALL BE CHECKED FOR SEDMENT BUILD-UP. SEDIMENT SHALL BE DISPOSED OF AT AN APPROVED SITE WHERE IT WILL NOT BE SUBJECT TO EROSION.





PROJECT NAME: NORTHFIELD PROJECT NUMBER: BF 0241(58)


File NAME: 219)223epsc_narrative.dgn PROJECT LEADER: K. SMITH DESIGNEO BY: K. HO EPSC NARRATIVE SHEET 2

PLOT DATE: 5/29/2025
DRAWN BY: T, MARQUETTE
CHECKED BY: C. JENNE
SHEET 96 OF 102

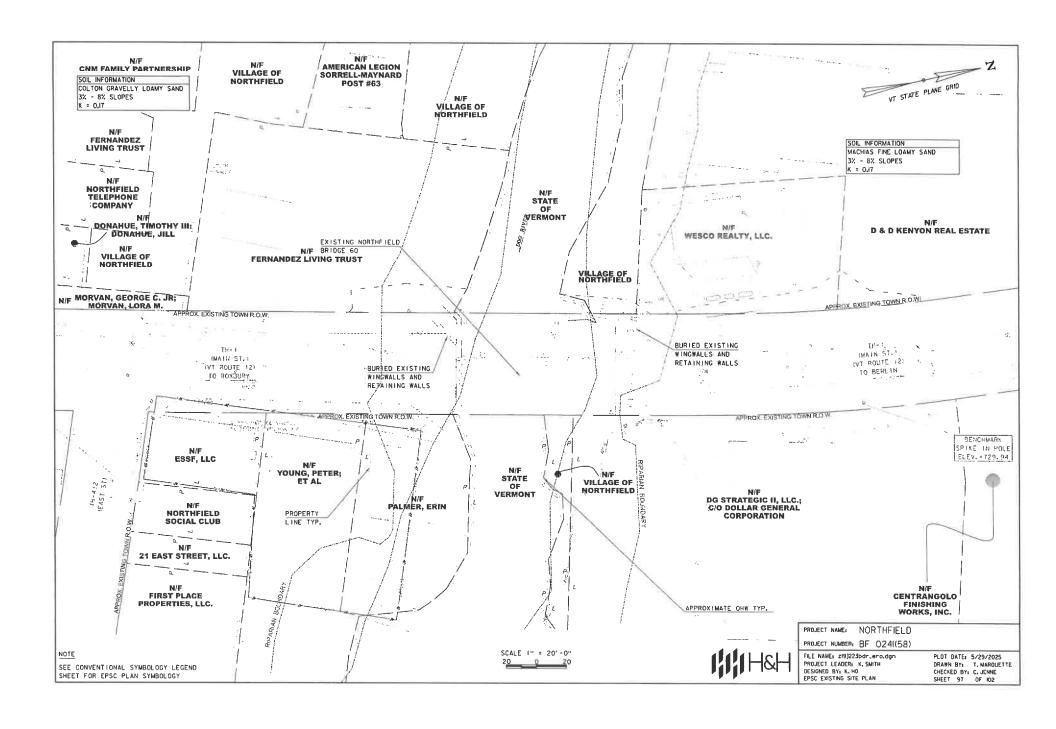

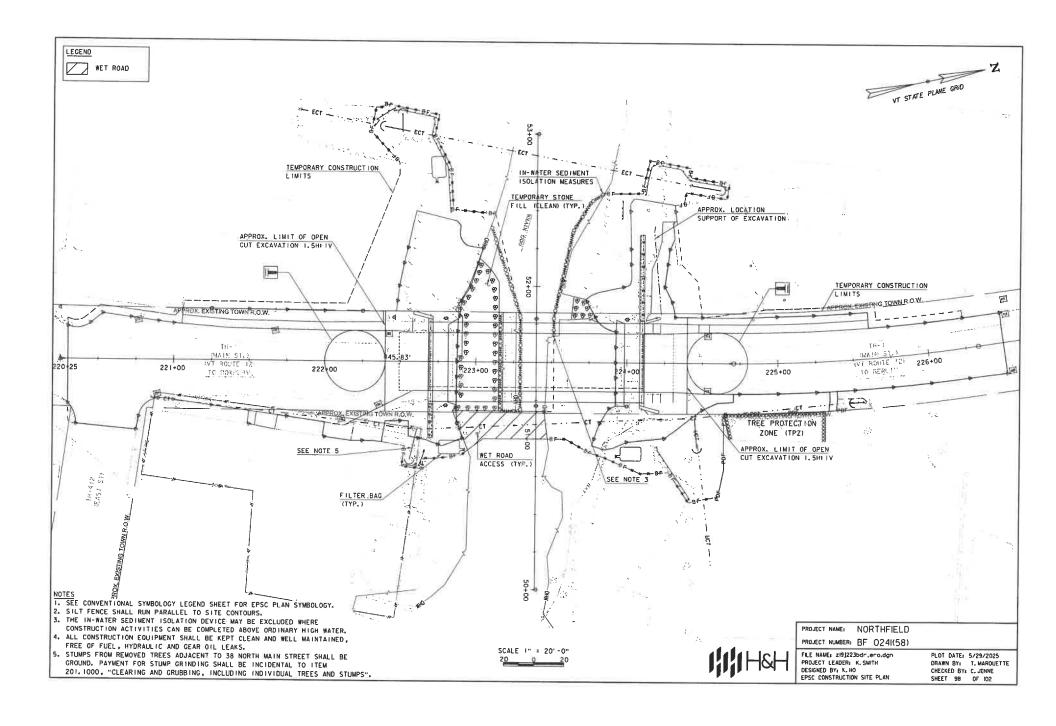

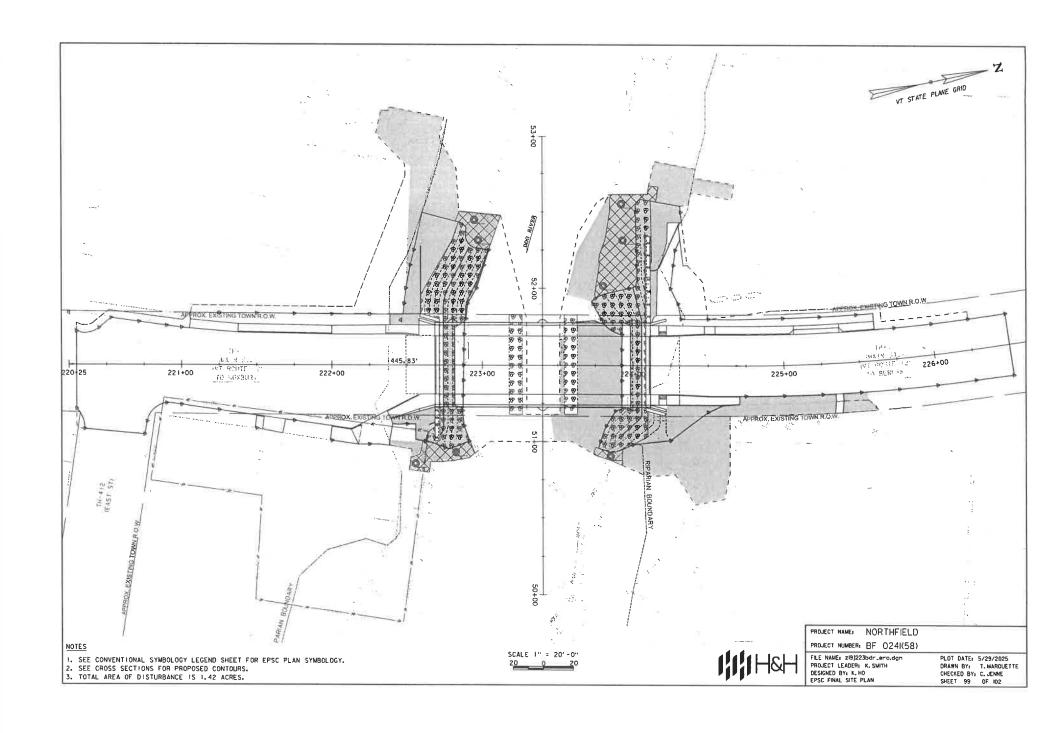

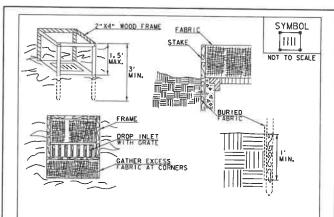

## CONSTRUCTION SPECIFICATIONS

- I.FILTER FABRIC SHALL HAVE AN APPARENT OPENING SIZE OF 40-85. BURLAP MAY BE USED FOR SHORT TERM APPLICATIONS.
- CUT FABRIC FROM A CONTINUOUS ROLL TO ELIMINATE JOINTS. IF JOINTS ARE NEEDED THEY WILL BE OVERLAPPED TO THE NEXT STAKE.
- 3. STAKE MATERIALS WILL BE STANDARD 2"× 4" WOOD OR EQUIVALENT METAL WITH A MINIMUM LENGTH OF 3".
- 1.SPACE STAKES EVENLY AROUND INLET 3' APART AND DRIVE A MINIMUM 18" DEEP, SPANS GREATER THAN 3' MAY BE BRIDGED WITH THE USE OF WIRE MESH BEHIND THE FILTER FABRIC FOR SUPPORT,
- 5. FABRIC SHALL BE EMBEDDED I' MINIMUM BELOW GROUND AND BACKFILLED. IT SHALL BE SECURELY FASTENED TO THE STAKES AND FRAME.
- 6. A 2" × 4" WOOD FRAME SHALL BE COMPLETED AROUND THE CREST OF THE FABRIC FOR OVER FLOW STABILITY.
- 7. MAXIMUM DRAINAGE AREA I ACRE


ADAPTED FROM DETAILS PROVIDED BY NEW YORK STATE DEC ORIGINALLY DEVELOPED BY USDA-NRCS VERMONT DEPARTMENT OF ENVIRONMENTAL CONSERVATION

FILTER FABRIC DROP INLET PROTECTION

REFER TO "THE VERMONT STANDARDS & SPECIFICATIONS FOR EROSION PREVENTION & SEDIMENT CONTROL -2006- "FROM THE VT AGENCY OF NATURAL RESOURCES FOR ADDITIONAL

THIS WORK SHALL BE PERFORMED IN ACCORDANCE WITH SECTION 653 FOR INLET PROTECTION DEVICE, TYPE HPAY

REVISIONS	
MARCH 7, 2008	WHF
JANUARY 13, 2009	WHE

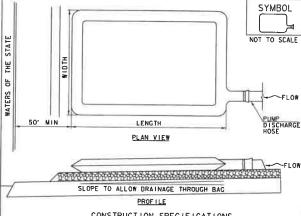

# CONSTRUCTION SPECIFICATIONS

- I. THE PRIMARY PURPOSE OF FILTER BAG IS TO RETAIN SILT, SAND, AND FINES DURING DEWATERING OPERATIONS.
- 2. FILTER BAGS SHALL BE INSTALLED ON A VEGETATED SLOPE GRADED TO ALLOW INCOMING WATER TO FLOW THROUGH THE BAG.
- 3. FILTER BAGS MAY ALSO BE PLACED ON COARSE AGGREGATE, STONE, OR HAYBALES TO INCREASE FILTRATION EFFICIENCY.
- 4. FILTER BAGS SHALL BE LOCATED A MINIMUM OF 50' FROM WATERS OF THE STATE UNLESS OTHERWISE APPROVED BY THE ENGINEER.
- 5. THE NECK OF THE FILTER BAG SHALL BE STRAPPED TIGHTLY TO THE DISCHARGE HOSE.
- 6. A FILTER BAG IS FULL WHEN IT NO LONGER CAN EFFICIENTLY FILTER SEDIMENT OR ALLOW WATER TO PASS AT A REASONABLE RATE.
- 7. FILTER BAG SHALL BE DISPOSED OF AS APPROVED IN THE EPSC PLAN OR AS DIRECTED BY THE ENGINEER.

FILTER BAG

REFER TO "THE VERMONT STANDARDS & SPECIFICATIONS FOR EROSION PREVENTION & SEDIMENT CONTROL -2006- "FROM THE VT AGENCY OF NATURAL RESOURCES FOR ADDITIONAL

THIS WORK SHALL BE PERFORMED IN ACCORDANCE WITH SECTION 653 FOR FILTER BAG (PAY ITEM 653,4500) AND AS SPECIFIED IN THE CONTRACT.

MARCH 24, 2008	WHF
ANUARY 13, 2009	WHE

			VAOT URBAN L	AWN MIX		
	LBS	/AC				
VEIGHT	BROADCAST	HYDROSEED	NAME	LATIN NAME	GERM	PURITY
42.5%	34	68	CREEPING RED FESCUE	FESTUCA RUBRA X RUBRA	85%	98%
20.0%	16	32	PERENNIAL RYE GRASS	LOLIUM PERENNE	90%	95%
32.5%	26	52	KENTUCKY BLUE GRASS	POA PRATENSIS	85%	85%
5.0%	4	8	ANNUAL RYE GRASS	LOCIUM MULTIFLORUM	85%	95%
100%	80	160				

GENERAL	AMENDMEN	T GUIDANCE
FERTILIZER		
		PELLITIZED
500 LBS/AC	2 TONS/AC	1 TONS/AC

## CONSTRUCTION GUIDANCE

- .SEED MIX: THE URBAN AREA MIX SHALL NOT BE USED IN WETLANDS OR ANY WATERS OF THE STATE OF VERMONT,
- 2. SEED MIX: USE ONLY AS INDICATED IN THE PLANS.
- 3. SEED MIX: SHALL NOT HAVE A WEED CONTENT EXCEEDING 0.40% BY WEIGHT AND SHALL BE FREE OF ALL NOXIOUS SEED.
- 4-FERTILIZER AND LINESTONE: SHALL FOLLOW RATES SHOWN ON PLAN OR AS DIRECTED BY THE ENGINEER
- 5. HAY MULCH: TO BE PLACED ON EARTH SLOPES AT THE RATE OF 2 TONS/ACRE, ACHIEVE 90% GROUND COVER OR AS DIRECTED BY THE ENGINEER.
- 6-HYDROSEEDING* ALTHOUGH GUIDANCE IS GIVEN ABOVE THE SITE CONDITIONS AND THE TYPE OF HYDROSEED WILL ULTIMATELY DICTATE THE AMOUNTS AND TYPES OF SOIL AMENDMENTS TO BE APPLIED.
- 7.TURF ESTABLISHMENT: PLACING SEED, FERTILIZER, LINE AND MULCH PRIOR TO SEPTEMBER 15 AND AFTER APRIL 15 CAN BETTER ENSURE A VIGOROUS GROWTH OF GRASS.

ADAPTED FROM VTRANS TECHNICAL LANDSCAPE MANUAL FOR ROADWAYS AND TRANSPORTATION FACILITIES TURF ESTABLISHMENT

THIS WORK SHALL BE PERFORMED IN ACCORDANCE WITH SECTION 651 FOR SEED (PAY ITEM 65(1500)


JANUARY 22, 2015 WHF




PROJECT NAME: NORTHFIELD PROJECT NUMBER: BF 0241(58)

FILE NAME: zi9J223epsc_det.dgr PROJECT LEADERS K. SMITH DESIGNED BY: K. HO FPSC OFTAILS - I

PLOT DATE: 5/29/2025 DRAWN BY: T. MARQUETTE CHECKED BY: C. JENNE SHEET IOO OF 102

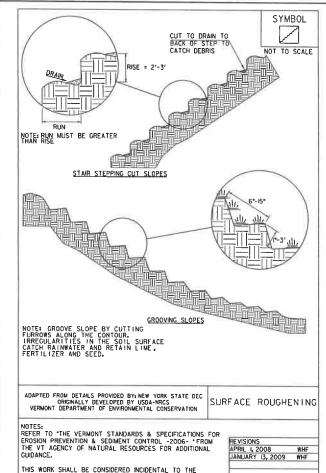

CONTRACT

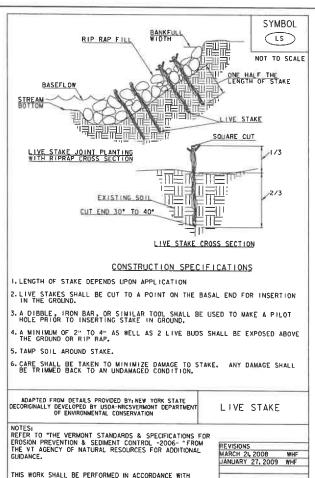


SECTION 656 FOR LIVE STAKE (PAY ITEM 656,1100)

IIIIH&H

PROJECT NAME: NORTHFIELD
PROJECT NUMBER: BF 024I(58)

FILE NAME: z'9J223eDsc_de+.dgn PROJECT LEADER: K.SMITH DESIGNED BY: K.HO EPSC DETAILS - 2

PLOT DATE: 5/29/2025
DRAWN BY: T. MARQUETTE
CHECKED BY: C. JENNE
SHEET IDI OF ID2

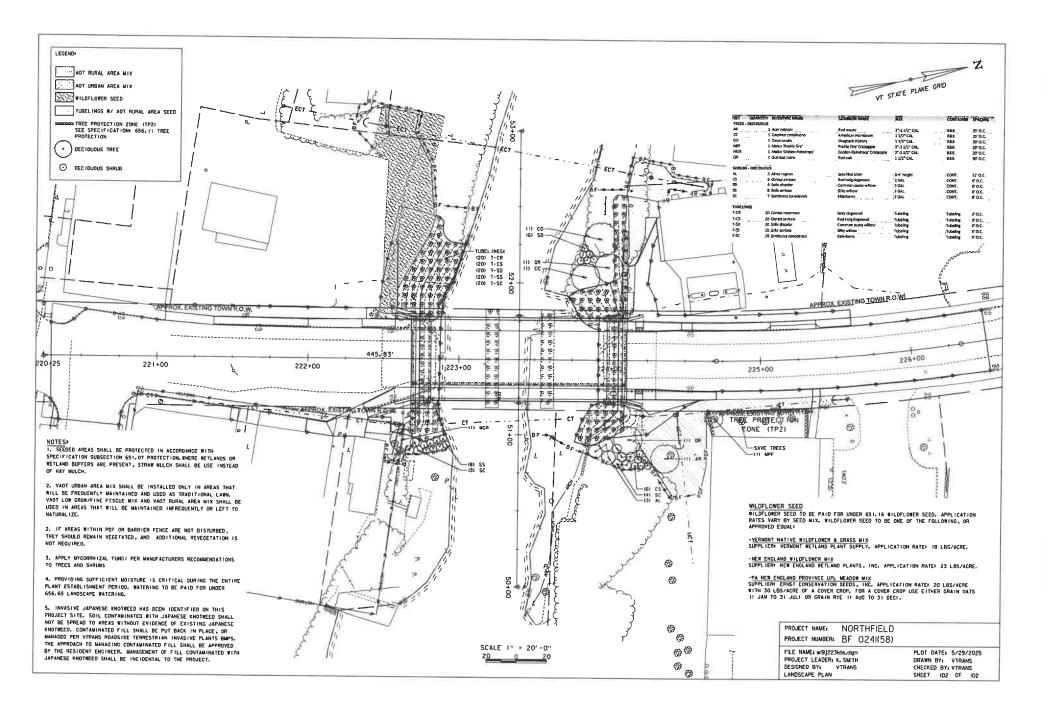

# TOWN OF NORTHFIELD, VERMONT SELECT BOARD REGULAR MEETING Minutes of July 22, 2025

I. ROLL CALL. Chair Charles Morse, Board members K. David Maxwell, Lydia Petty, Merry Shernock (absent), and John Stevens. Also present were Manager Jeff Schulz, Acting Clerk Kenneth McCann, Pierre Gomez (Northfield Police Chief), Ron Tucker (RE Tucker, Inc.), Sherrie Tucker (RE Tucker, Inc.), Anne Donahue (Vermont State Representative), Tim Swartz (Accessibility, Walkability, and Pedestrian Safety [AWPS] Task Force), Dan Anderson (AWPS Task Force), Mary Nadon Scott (AWPS Task Force), DeLane McIlvene (AWPS Task Force), Janan Hamm (AWPS Task Force), Bill Clements (AWPS Task Force), Royal DeLegge (Chair, Planning Commission), Jeremy Whalen (Chair, Town Forest Stewardship Committee), Gerard LaVarnway, Lorna Doney, Don Doyon, Susan Stillinger, Laura Hill-Eubanks, Carolyn Stevens, Pam Ricker, and Elroy C. Hill.

Chair Morse called the meeting to order at 7:00 p.m.

II. SET/ADJUST AGENDA. (7:02 p.m.) Chair Morse said Gary Laroche from the Vermont Agency of Transportation (VTrans) was to address the Select Board members tonight about the Main Street Bridge Replacement Project but had to postpone his presentation for another time. He did email this afternoon and reported that the original cost estimate for this project (\$8,000,000) has now increased to \$11,500,000. The municipality must pay five percent (5%) of this as a local match amount so there will need to be a discussion at the next budget meetings regarding how to pay for this.

# III. PUBLIC PARTICIPATION (SCHEDULED):

- Ron Tucker & Sherrie Tucker, RE Tucker, Inc.: Availability of Tucker Sand Pit for a. Municipal Purchase. (7:03 p.m.) Chair Morse said R.E. Tucker, Inc. has sold road material to the Northfield Highway Department for several years. They have a sand pit located off Vermont Route 12A that they are willing to sell to the municipality with an estimated 100,000 cubic yards of road material. Mr. Tucker said they want to sell the sand pit due to increasing business permitting costs as well as higher shared costs for maintaining a railroad bridge on the property. Mr. Tucker felt the municipality should be able to handle both these costs better due to less stringent permitting rules for municipalities and the possibility of obtaining grant funds for railroad bridge maintenance. It also might be possible to create a public road running through the site to lower the bridge maintenance costs. The Tuckers have an initial sale price of \$600,000 for the sand pit and Mr. Tucker said it should provide a lifetime of sand and gravel for the community. He also noted that it has become more difficult in recent years for Vermont highway departments to obtain acceptable road materials. Board member Stevens asked if the sale price included the railroad bridge. Mr. Tucker confirmed that it did and noted that there is a migrating right-of-way for a property located above the sand pit. The municipality would need to maintain the roadway for the property owner once the Chair Morse said this matter would need to be right-of-way has been established. investigated further by the Select Board members (perhaps by the Highway Subcommittee?) before they can enter into negotiations with the Tuckers regarding the sale price, etc. Mr. Tucker fully understands this and said this was just a preliminary outreach to determine if there is any municipal interest in a possible sale. Chair Morse said the municipality would need to conduct a cost-benefit analysis (CBA) as it probably would need to borrow funds to complete the purchase. Mr. Tucker will provide the Select Board members with all the information they will require to make this decision. There had been earlier negotiations with the Town of Braintree to purchase the sand pit and that documentation will be provided as well. Mr. Tucker hopes that once all the relevant information has been provided, a site visit can be scheduled as part of the negotiation process. Chair Morse then thanked the Tuckers for bringing forward this proposal and said the Select Board members will remain in touch.
- b. Anne Donahue, Vermont State Representative: Habitat for Humanity. (7:27 p.m.)

  Ms. Donahue said she was not here as a state representative tonight but rather as Interim Chair for a Habitat for Humanity committee that is working on a proposal to build a duplex building that would provide two (2) Northfield families with affordable housing. The location would be the vacant lot at the intersection of North Main Street and Dogwood Glen Drive.

  Ms. Donahue said the RFPs for this project have already been distributed and there will be a community meeting held this fall in order to fully describe the project. Her committee will be holding a meeting tomorrow night where they will finalize the flyer for this community meeting. Ms. Donahue added that Northfield Economic Development Director (EDD) Town Davis has attended several of their past meetings and has been of great assistance.

Board member Maxwell asked if there are eligibility criteria for the new homeowners. Ms. Donahue said the committee would determine eligibility and a major factor is whether the new homeowners would be able to make their mortgage payments. In addition, one of the families must be headed by a veteran. Board member Petty thanked Ms. Donahue and the other Habitat for Humanity committee members for working on this project.

- Tim Swartz, Accessibility, Walkability, and Pedestrian Safety Task Force: C. Pedestrian Safety Improvements (Warning Signs, Roadside Trimming, etc.). (7:36 p.m.) Mr. Swartz said he and the other AWPS Task Force members have been on the lookout for locations in the community that present pedestrian safety hazards. They have identified a few locations including near the new flashing crosswalk sign in Northfield Falls. Mr. Swartz felt drivers travelling southward towards the crosswalk don't see the new crosswalk sign until it is too late because of the sharp curve north of the crosswalk. Therefore, it would be very helpful to have a warning sign installed further north of the crosswalk approach. In addition, there are some areas where roadside bushes, shrubs, and tree branches need to be trimmed in order to create greater visibility for pedestrian crossings, road signs, etc. Mr. Swartz will provide a full list of these locations to Manager Schulz and the Select Board members. Manager Schulz said he has contacted VTrans about the need to make the Northfield Falls crosswalk more visible and also is working with them to improve road drainage in the area. He noted, however, that working with VTrans usually includes some delay before the requested work is actually completed. Bill Clements also is concerned about pedestrian safety when detours are put in place for the Main Street Bridge Replacement project scheduled for next year. He had hoped to ask Mr. Laroche about this as he has concerns about the diversion of traffic mostly along Water Street while the bridge is closed. This is a heavy traffic area and he had hoped to see some significant pedestrian safety measures installed that might include temporary traffic lights, etc. Mr. Clements said the AWPS Task Force members will be watching for any developments regarding pedestrian safety as the bridge replacement project develops. Chair Morse noted that an early decision was to bar heavy tractor trailers from the traffic detours along Wall Street, Water Street, etc. He does agree that more needs to be done to ensure pedestrian safety during this project. Manager Schulz said VTrans has submitted its final project plans and these do include improved pedestrian safety measures that include barricades, etc. Chair Morse feels there will need to be a full discussion with VTrans representatives about this matter. He then thanked Mr. Swartz and the other AWPS Task Force members for bringing their concerns to the attention of the Select Board members.
- Royal DeLegge, Planning Commission Chair: Town Forest Zoning Issues. (7:55 d. p.m.) Mr. DeLegge said that the Planning Commission (PC) members worked last year on updating the local zoning regulations to make them fully compliant with new state laws and more user-friendly. Since then, the PC members have been working on additional upgrades that included addressing public concerns that the current zoning regulations do not provide sufficient protection from future development for the Town Forest. The PC members have looked at several options such as further revising the zoning regulations, establishing conservation easements for some or all of the Town Forest, etc. They recently have focused on defining a "Forest Reserve Overlay District." The purpose of a this district "is to produce wood products, maintain wildlife habitat, protect water supplies, and provide forest recreation and conservation education. Within the Forest Reserve Overlay District, permitted uses include sustainable commercial forestry and related uses, and all other land development is prohibited." Mr. DeLegge said he and the other PC members wanted to learn how the Select Board members would feel about this course of action before proceeding further. Board member Petty thanked the PC members for working on this as she feels (along with many Northfield residents) that protection of the Town Forest is a very important concern. She asked if Cheney Field would be included in this district. Mr. DeLegge said they only have a preliminary map of the area to be included in this district. The boundaries of the district can be changed very easily if requested. This is what makes a Forest Reserve Overlay District very different from an easement, which is very difficult to adjust once it has been adopted. Board member Maxwell also thanked Mr. DeLegge and the PC members for the work they have done on this to date. He added that his chief concern regarding Town Forest protection is to make sure that the water supply on Cheney Field is not impeded by any new land use restrictions. Mr. DeLegge said there would be no problem in excluding Cheney Field from the new district. Chair Morse asked if there has been any PC discussion of establishing an overall easement for the Town Forest. Mr. DeLegge said that possibility has not been a part of their recent conversations.

Chair Morse said he has heard some public views expressed by Northfield Farmers Market patrons stating support for establishing easements for the Town Forest that would ban any future development forever. He then added that the Northfield Conservation Commission (NCC) will be meeting tomorrow night and one agenda item focuses on the future of Cheney Field. Chair Morse then thanked Mr. DeLegge for the valuable information provided tonight.

# IV. APPROVAL OF MINUTES

- a. July 8, 2025 (Regular Meeting). (8:07 p.m.) Motion by Board member Maxwell, seconded by Board member Stevens, to approve the minutes. Chair Morse requested a minor wording revision. Motion passed 3-0-1, with Board member Petty abstaining.
- **b. July 11, 2025 (Special Meeting). (8:09 p.m.)** Motion by Board member Stevens, seconded by Board member Maxwell, to approve the minutes. **Motion passed 4-0-0.**
- c. July 15, 2025 (Special Meeting). (8:10 p.m.) Motion by Board member Stevens, seconded by Board member Petty, to approve the minutes. Motion passed 3-0-1, with Board member Maxwell abstaining.

# V. APPROVAL OF BILLS

- a. Approval of Warrant #02-26. (8:12 p.m.) Prior to the motion for warrant approval, Chair Morse asked that the invoice submitted by Queen City P.I. be removed from the warrant. This would reduce the warrant amount by \$11,889.80. There was no objection. Motion by Board member Maxwell, seconded by Board member Stevens, to approve Warrant #02-26 in the amount of \$635,448.91. Board member Stevens noted that the allocation for the Brown Public Library was incorrect. It should be \$11,000 and not \$9,334. Manager Schulz said this would be corrected on the next warrant. Motion passed 4-0-0.
- b. Receipt of Biweekly Payroll through July 6, 2025. (8:20 p.m.) Motion by Board member Stevens, seconded by Board member Maxwell, to receive the biweekly payroll in the amount of \$117,300.71. Motion passed 4-0-0.

# VI. SELECT BOARD

- **a. Board of Listers Appointment. (8:21 p.m.)** Motion by Board member Stevens, seconded by Board member Petty, to appoint Alexandria Najduch to fill the vacancy on the Board of Listers. **Motion passed 4-0-0.**
- b. Ethics Training Requirements for Municipal Officers. (8:22 p.m.) Chair Morse said there is a new state requirement that certain municipal officers and board members must complete online ethics training. The deadline for completing the initial training course is September 25, 2025 and he felt those persons affected by this requirement should be contacted by letter to inform them of this. Board member Petty noted that there is a limited number of town officials and board members affected by this requirement. The Vermont League of Cities & Towns (VLCT) website has a good list of the municipal officials that fall under this requirement.

# VII. TOWN MANAGER'S REPORT

- a. Main Street Water Line and Cheney Farm Tank Replacement Projects. (8:26 p.m.)

  Manager Schulz said the water line project is progressing well and remains on schedule. The work on Prospect Street will be starting soon and he will post notices on local social media so residents are kept aware of the work schedule. The old reservoir tanks on Cheney Farm have been removed from the site and the new water tank will be installed in coming weeks.
- **b. Vine Street Sidewalk Project. (8:26 p.m.)** Manager Schulz said this project also remains on schedule for completion by August 1, 2025.
- c. Property Tax Sale. (8:26 p.m.) Manager Schulz said there are now about fifteen (15) properties that have accumulated at least two (2) years of delinquent taxes. That makes them subject to tax sale. Manager Schulz will be working with the property owners to see if full or partial payments can be made to keep them out of the tax sale. The tax sale is now scheduled for the end of September 2025.
- d. Street Sign Replacement (8:26 p.m.) Manager Schulz said a good number of street signs have been damaged or stolen recently. The missing signs will be replaced as soon as possible. Board member Maxwell said there are traffic sign locks that discourage, if not fully prevent, these type of thefts.

e. New Accounting Department Bookkeeper. (8:27 p.m.) Manager Schulz announced that Kristin Paya has been hired to replace retired bookkeeper Deb O'Grady. Ms. Paya will start work on Monday, August 4, 2025.

# VIII. BOARD MEMBERS' COMMENTS, CONCERNS, QUESTIONS

- **a. Main Street Repaving. (8:29 p.m.)** Board member Maxwell asked how much of Main Street will be repaved after the water line project has been completed. Manager Schulz said the area south of the Main Street Bridge to South Street will be fully repaved. Other areas will be patched and the whole street is scheduled for full repaving in about five (5) years.
- **Improved Public Notification.** (8:34 p.m.) Board member Petty believes there needs to be better communication with the public regarding the water line project as to when residents' water source is switched over to a temporary line, etc. Manager Schulz said there have been a few occasions when the contractor didn't inform him before making these switchovers. Board member Petty would like additional social media postings about the project so there are no future surprises.
- vLCT Compensation Study. (8:36 p.m.) Board member Petty asked if Northfield participates in the annual VLCT compensation study. Manager Schulz said it does and free copies of the completed study are provided to participating municipalities.
- d. Central Vermont Select Board Member Meeting. (8:38 p.m.) Board member Petty attended the meeting of Central Vermont Select Board members hosted by VLCT and the Central Vermont Regional Planning Commission (CVRPC). There was much information provided and she is glad that Northfield doesn't have the same financial problems as those communities that have suffered significant summer storm damage in recent years.
- e. Vermont Youth Conservation Corps (VYCC). (8:39 p.m.) Board member Petty noted the VYCC members have done considerable trail work in the Town Forest recently. Town Forest Stewardship Committee (TFSC) Chair Jeremy Whalen said some work still needs to be done on the Garvey Hill trails located near the public schools.
- f. Clark Road Public Health Problems. (8:40 p.m.) Board member Stevens asked about the current status of this public health concern. Manager Schulz said the municipality went to the environmental court and the people living in a structure without a septic hookup were required to vacate the property. The structure still remains unoccupied. The property owner was fined \$10,000 for allowing the situation to deteriorate. The funds have not yet been collected so the municipality might have to return to the environmental court for relief.
- g. Crosswalk Painting. (8:46 p.m.) Board member Stevens asked when the crosswalk painting would begin. Manager Schulz said the new contractor said it would start next week. He had hired a different contractor in early spring to get the job done sooner but that contractor subsequently went out of business. There will be some crosswalks in the water line project area that will not be repainted at this time.
- h. Vine Street Pedestrian Bridge. (8:48 p.m.) Board member Stevens asked about the planned repairs for this footbridge. Manager Schulz said Daniels Construction will be providing an inspection and repair quotes in the next few weeks.
- i. Slaughterhouse Road Covered Bridge. (8:49 p.m.) Chair Morse has heard complaints from residents living on Slaughterhouse Road above the bridge that the maximum weight limit currently listed for the bridge (6,000 lbs.) is too low. Some want to move hay loads across the bridge that would be in excess of the current weight limit. VTrans will be reevaluating the bridge soon and that should eliminate any confusion.
- IX. PUBLIC PARTICIPATION (UNSCHEDULED). There was none.
- X. ADJOURNMENT. Motion by Board member Stevens, seconded by Board member Maxwell, to adjourn. Motion passed 4-0-0.

The Board adjourned at 8:50 p.m.

Respectfully submitted,

Kenneth L. McCann

Kenneth L. McCann, Acting Clerk

A video recording of this meeting is available at: https://youtu.be/LBWHuLDDCbI

These minutes are subject to approval at the next Select Board regular meeting.

# **TOWN OF NORTHFIELD**

THE UNDERSIGNED HEREBY AUTHORIZE THE EXPENDITURES LISTED HEREIN, ACCORDING TO THE LAWS OF THE STATE OF VERMONT.

DISBURSEMENT DATE:

08/15/25

WARRANT 03-26, 03-26A-F

N	ORTHFIELD TOWN SEI	LECT BOARD	
K. DAVID MAXWELL			
CHARLIE MORSE, Chair			
LYDIA PETTY			
MERRY SHERNOCK, Vice Chair			
JOHN B. STEVENS			
JEFFREY SCHULZ, Manager			
TOWN GENERAL	96,594.00	ELECTRIC FUND	269,529.31
MUNICIPAL PLANNING GRANT		WATER FUND	9,571.47
FLOOD BUYOUT GRANT		SEWER FUND	41,561.58
COMMON FUND			
COMMUNITY DEVELOPMENT FUND			
ARPA FUND			
TOWN CIP	99,583.91		
AMBULANCE DONATION FUND			
FIRE DONATION FUND	-		
RECREATION COMMITTEE FUND			
POOL DONATION FUND			
CONSERVATION FUND	<del>111</del> 0		
POLICE DONATION FUND			
ENERGY COMMITTEE DONATION FUND			
AGENCY FUND			9
SUBTOTAL	\$196,177.91	SUBTOTAL	\$320,662.36

\$516,840.27

**GRAND TOTAL** 

._aw

∠025 11:17 | TOWN OF NORTHFIELD

INVOICE LIST BY GL ACCOUNT

YEAR/PERIOD: 2025/1 TO 2026/2 WARRANT CHECK DESCRIPTION ACCOUNT/VENDOR DOCUMENT VOUCHER PO YEAR/PR TYP S 10000 TOWN GEN - BALANCE SHEET 10000 01340 UNUSED POSTAGE INVENTORY 6/25/25 POSTAGE 040191 NEOPOST-NEOFUNDS 0 2025 12 INV A 1,500.00 03-26 FULL DESC: 6/25/25 POSTAGE INVOICE: 0 2026 2 INV A 1,500.00 03-26 JUL 25,2025POSTAGE 040191 NEOPOST-NEOFUNDS 86527 FULL DESC: JUL 25,2025POSTAGE INVOICE: ...... 3,000.00 ACCOUNT TOTAL 3,000.00 10000 02015 PARK DEPOSIT PAYABLE 7/19 PK DEPOSIT REF 0 2026 2 INV A 75.00 03-26 011028 ALLEN, ANGELA 86440 FULL DESC: 7/19 PK DEPOSIT REFUND-PICNIC INVOICE: ACCOUNT TOTAL 75.00 ORG 10000 TOTAL 3,075.00 TOWN MANAGER 10130 10130 07010 TELEPHONE 86581 2026 2 INV A 25.67 03-26 6/17-7/16 CELL PHON 010495 VERIZON WIRELESS 0 FULL DESC: 6/17-7/16 CELL PHONE INVOICE: 6118698477 0 2026 2 INV A 8/4-PHONE 802485541 67.27 03-26 86571 042768 TDS TELECOM FULL DESC: 8/4-PHONE 8024855411 INVOICE: ACCOUNT TOTAL 92.94 10130 07020 POSTAGE 0 2026 2 INV A 88.29 03-26 JUL 25 POSTAGE 042896 NFLD TOWN GEN FUND 86511 INVOICE: FULL DESC: JUL 25 POSTAGE 88.29 ACCOUNT TOTAL 10130 07050 OFFICE SUPPLIES 59.33 03-26 6 CASES 8.5X11 COPY 2026 2 INV A 035892 MAGEE OFFICE PLUS 86471 0 INVOICE: FULL DESC: 6 CASES 8.5X11 COPY PAPER 14.17 03-26 AUG25 INTERNET MUN 055824 TRANS-VIDEO 86575 2026 2 INV A FULL DESC: AUG25 INTERNET MUN BLD INVOICE: ACCOUNT TOTAL 73.50 254.73 ORG 10130 TOTAL TOWN CLERK/TREASURER 10140 MAINTENANCE CONTRACTS 10140 06220 7/25-8/24 PRINTER C 054400 SYMQUEST GROUP INC. 86568 25.25 03-26 0 2026 2 INV A FULL DESC: 7/25-8/24 PRINTER CONTRACT INVOICE: 2018290

ACCOUNT TOTAL

25.25

08/07/2025 11:17 | TOWN OF NORTHFIELD

INVOICE LIST BY GL ACCOUNT

YEAR/PERIOD: 2025/1 TO 2026/2 ACCOUNT/VENDOR DOCUMENT VOUCHER PO YEAR/PR TYP S WARRANT CHECK DESCRIPTION TELEPHONE 0 2026 2 INV A 69.91 03-26 042768 TDS TELECOM 86571 8/4-PHONE 802485541

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10140 07010 INVOICE: FULL DESC: 8/4-PHONE 8024855411 ACCOUNT TOTAL 69.91 10140 07020 POSTAGE 042896 NFLD TOWN GEN FUND 86511 0 2026 2 INV A 1,357.98 03-26 JUL 25 POSTAGE INVOICE: FULL DESC: JUL 25 POSTAGE ACCOUNT TOTAL 1,357.98 10140 07050 OFFICE SUPPLIES 2026 2 INV A 035892 MAGEE OFFICE PLUS 86471 0 52.50 03-26 6 CASES 8.5X11 COPY INVOICE: FULL DESC: 6 CASES 8.5X11 COPY PAPER 055824 TRANS-VIDEO 86575 0 2026 2 INV A 25.07 03-26 AUG25 INTERNET MUN INVOICE: FULL DESC: AUG25 INTERNET MUN BLD ACCOUNT TOTAL 77.57 10140 07070 DUES/MEETINGS/SUBSCRIPTIONS 057880 VMCTA 86585 2026 2 INV A 45.00 03-26 MEMBERSHIP DUES-J D 0 INVOICE: FULL DESC: MEMBERSHIP DUES-J DONEY ACCOUNT TOTAL 45.00 ORG 10140 TOTAL 1,575.71 10230 ACCOUNTING 10230 06010 PROFESSIONAL SERVICES 013521 LAURIE A BAROFFIO 86466 2026 2 INV A 2,700.00 03-26 ACCTING/CONSULTING INVOICE: 103 FULL DESC: ACCTING/CONSULTING 7/28-8/03 013521 LAURIE A BAROFFIO 0 2026 2 INV A ACCTING/CONSULTING 86467 7.830.00 03-26 INVOICE: 102 FULL DESC: ACCTING/CONSULTING 7/14-7/27 _____ 10,530.00 ACCOUNT TOTAL 10,530.00 MAINTENANCE CONTRACTS 10230 06220 054400 SYMQUEST GROUP INC. 86568 n 2026 2 INV A 57.22 03-26 7/25-8/24 PRINTER C FULL DESC: 7/25-8/24 PRINTER CONTRACT INVOICE: 2018290 ACCOUNT TOTAL 57.22 TELEPHONE 10230 07010 8/4-PHONE 802485541 042768 TDS TELECOM 86571 0 2026 2 INV A 103.35 03-26 INVOICE: FULL DESC: 8/4-PHONE 8024855411

103.35 ACCOUNT TOTAL

INVOICE: 6118698477

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INVOICE LIST BY GL ACCOUNT

YEAR/PERIOD: 2025/1 TO 2026/2 DOCUMENT VOUCHER PO YEAR/PR TYP S ACCOUNT/VENDOR WARRANT CHECK DESCRIPTION ______ POSTAGE 10230 07020 0 2026 2 INV A 106.41 03-26 JUL 25 POSTAGE 042896 NFLD TOWN GEN FUND 86511 FULL DESC: JUL 25 POSTAGE INVOICE: ACCOUNT TOTAL 106.41 10230 07050 OFFICE SUPPLIES 6 CASES 8.5X11 COPY 52.50 03-26 035892 MAGEE OFFICE PLUS 86471 0 2026 2 INV A FULL DESC: 6 CASES 8.5X11 COPY PAPER INVOICE: 2026 2 INV A 24.00 03-26 7/24 SHREDDING PICK 052902 SECURSHRED 86538 INVOICE: 497619 FULL DESC: 7/24 SHREDDING PICKUP SRVC 2026 2 INV A 37.12 03-26 AUG25 INTERNET MUN 055824 TRANS-VIDEO 86575 0 FULL DESC: AUG25 INTERNET MUN BLD INVOICE: ACCOUNT TOTAL 113.62 ORG 10230 TOTAL 10,910.60 10260 LISTERS 10260 MAINTENANCE CONTRACTS 8.42 03-26 0 2026 2 INV A 7/25-8/24 PRINTER C 054400 SYMQUEST GROUP INC. 86568 FULL DESC: 7/25-8/24 PRINTER CONTRACT INVOICE: 2018290 ACCOUNT TOTAL 8.42 TELEPHONE 10260 07010 0 2026 2 INV A 69.21 03-26 8/4-PHONE 802485541 86571 042768 TDS TELECOM FULL DESC: 8/4-PHONE 8024855411 INVOICE: 69.21 ACCOUNT TOTAL POSTAGE 10260 07020 0 2026 2 INV A 1.43 03-26 JUL 25 POSTAGE 042896 NFLD TOWN GEN FUND 86511 FULL DESC: JUL 25 POSTAGE INVOICE: ACCOUNT TOTAL 1.43 OFFICE SUPPLIES 07050 25.07 03-26 AUG25 INTERNET MUN 2026 2 INV A 86575 0 055824 TRANS-VIDEO FULL DESC: AUG25 INTERNET MUN BLD INVOICE: ACCOUNT TOTAL 25.07 ORG 10260 TOTAL 104.13 FIRE DEPARTMENT 10320 TELEPHONE 10320 07010 20.22 03-26 6/17-7/16 CELL PHON 0 2026 2 INV A 010495 VERIZON WIRELESS 86581

FULL DESC: 6/17-7/16 CELL PHONE

INVOICE LIST BY GL ACCOUNT

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YEAR/PERIOD: 2025/1 TO 2026/2 ACCOUNT/VENDOR DOCUMENT VOUCHER PO YEAR/PR TYP S WARRANT CHECK DESCRIPTION 042768 TDS TELECOM 86571 0 2026 2 INV A 38.12 03-26 8/4-PHONE 802485541 INVOICE: FULL DESC: 8/4-PHONE 8024855411 ACCOUNT TOTAL 58.34 10320 08013 ELECTRIC-SOLAR 2026 2 INV A BULLRUN SOLAR-JULY 052905 SENIOR RENEWABLES, L 86539 101.87 03-26 INVOICE: 190 FULL DESC: BULLRUN SOLAR-JULY ACCOUNT TOTAL 101.87 10320 08030 WATER 043552 NORTHFIELD 86513 0 2026 2 INV A 28.03 03-26 7/18-FIRE STATION INVOICE: FULL DESC: 7/18-FIRE STATION ACCOUNT TOTAL 28.03 10320 08050 SEWER 043552 NORTHFIELD 2026 2 INV A 86513 0 29.02 03-26 7/18-FIRE STATION INVOICE: FULL DESC: 7/18-FIRE STATION ACCOUNT TOTAL 29.02 10320 08070 GASOLINE/DIESEL 86377 028560 GILLESPIE FUELS 0 2025 12 INV A 57.82 03-26 21.9 GALS DIESEL 6/ INVOICE: FULL DESC: 21.9 GALS DIESEL 6/5 FD 028560 GILLESPIE FUELS 86378 0 2025 12 INV A 41.45 03-26 15.7 GALS DIESEL 6/ INVOICE: FULL DESC: 15.7 GALS DIESEL 6/9 FD -----99.27 ACCOUNT TOTAL 99.27 ORG 10320 TOTAL 316.53 10330 POLICE DEPARTMENT 06090 10330 JANITORIAL SERVICES 053855 SPOTLESS CLEANING 86563 0 2026 2 INV A 200.00 03-26 6/29-7/5 CLEANING S INVOICE: FULL DESC: 6/29-7/5 CLEANING SRVCS 053855 SPOTLESS CLEANING 86564 0 2026 2 INV A 200.00 03-26 7/6-7/12 CLEANING S INVOICE: FULL DESC: 7/6-7/12 CLEANING SRVCS 053855 SPOTLESS CLEANING 86565 0 2026 2 INV A 200.00 03-26 7/13-7/19 CLEANING FULL DESC: 7/13-7/19 CLEANING SRVCS INVOICE: 7/20-7/26 CLEANING 053855 SPOTLESS CLEANING 86566 0 2026 2 INV A 200.00 03-26 INVOICE: FULL DESC: 7/20-7/26 CLEANING SRVCS -----800.00

ACCOUNT TOTAL

800.00

MAINTENANCE CONTRACTS 10330 06220

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INVOICE LIST BY GL ACCOUNT

YEAR/PERIOD: 2025/1 TO 2 ACCOUNT/VENDOR	DOCUMENT		PO YEAR/PR TYP S			DESCRIPTION
016370 CANON SOLUTIONS AMER INVOICE: 6012714486		FULL DESC:	0 2025 12 INV A 4/26-7/25 COPIER-PD	97.17	03-26	4/26-7/25 COPIER-PD
054400 SYMQUEST GROUP INC. INVOICE: 2011948		FIII.I. DESC.	0 2025 12 INV A JUNE25 SERVER LICENSE PD	1,566.00	03-26	JUNE25 SERVER LICEN
054400 SYMQUEST GROUP INC. INVOICE: 2011947			0 2026 2 INV A OFFICE 365-PD 5/25-5/26	2,160.00	03-26	OFFICE 365-PD 5/25-
			-	3,726.00		
			ACCOUNT TOTAL	3,823.17		
10330 06391			STATE OF VT RECORDS	MGMNT		
055824 TRANS-VIDEO INVOICE:	86576		0 2026 2 INV A AUG25 INTERNET PD	237.98	03-26	AUG25 INTERNET PD
			ACCOUNT TOTAL	237.98		
10330 07010			TELEPHONE			
010495 VERIZON WIRELESS INVOICE: 6118698477	86581	FULL DESC:	0 2026 2 INV A 6/17-7/16 CELL PHONE	321.86	03-26	6/17-7/16 CELL PHON
028854 GOMEZ, PIERRE INVOICE:	86462	FULL DESC:	0 2026 2 INV A AUG 25 CELL PHONE	75.00	03-26	AUG 25 CELL PHONE
042768 TDS TELECOM INVOICE:	86571	FULL DESC:	0 2026 2 INV A 8/4-PHONE 8024855411	378.63	03-26	8/4-PHONE 802485541
			ACCOUNT TOTAL	775.49		
10330 07020			POSTAGE			
042896 NFLD TOWN GEN FUND INVOICE:	86511	FULL DESC:	0 2026 2 INV A JUL 25 POSTAGE	19.41	03-26	JUL 25 POSTAGE
			ACCOUNT TOTAL	19.41		
10330 08013 052905 SENIOR RENEWABLES, L INVOICE: 190	86539	FULL DESC:	BLECTRIC-SOLAR  0 2026 2 INV A  BULLRUN SOLAR-JULY	283.07	03-26	BULLRUN SOLAR-JULY
			ACCOUNT TOTAL	283.07		
10330 08030 043552 NORTHFIELD INVOICE:	86514	FULL DESC:	WATER 0 2026 2 INV A 7/18-PD	28.03	03-26	7/18-PD
			ACCOUNT TOTAL	28.03		
10330 08050 043552 NORTHFIELD INVOICE:	86514	FULL DESC:	SEWER 0 2026 2 INV A 7/18-PD	29.02	03-26	7/18-PD

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ACCOUNT/VENDOR	DOCUMENT	VOUCHER VOUCHER	•	WARRANT	CHECK DESCRIPTION
			ACCOUNT TOTAL	29.02	
10330 08070			GASOLINE		
042896 NFLD TOWN GEN FUND	86399		0 2025 12 INV A	501.79 03-26	JUNE 25 GAS/DIESEL
INVOICE:		FULL DESC:	JUNE 25 GAS/DIESEL		
042896 NFLD TOWN GEN FUND	86400		0 2025 12 INV A	588.66 03-26	MAY 25 GAS/DIESEL
INVOICE:		FULL DESC:	MAY 25 GAS/DIESEL		
042896 NFLD TOWN GEN FUND	86401		0 2025 12 INV A	581.66 03-26	APRIL25 GAS/DIESEL
INVOICE:		FULL DESC:	APRIL25 GAS/DIESEL		
				1,672.11	
053596 SO. VILLAGE	86540		0 2026 2 INV A	29.89 03-26	9.644 GALS GASOLINE
INVOICE: 2981		FULL DESC:	9.644 GALS GASOLINE 7/1PD		
053596 SO. VILLAGE	86541		0 2026 2 INV A	37.07 03-26	11.587 GALS GAS 7/2
INVOICE: 4946		FULL DESC:	11.587 GALS GAS 7/2PD		
053596 SO. VILLAGE	86542		0 2026 2 INV A	35.22 03-26	11.009 GALS GAS 7/3
INVOICE: 5143		FULL DESC:	11.009 GALS GAS 7/3PD		
053596 SO. VILLAGE	86543		0 2026 2 INV A	30.91 03-26	9.662 GALS GAS 7/3
INVOICE: 5192		FULL DESC:	9.662 GALS GAS 7/3		
053596 SO. VILLAGE	86544		0 2026 2 INV A	35.04 03-26	10.952 GALS GAS 7/8
INVOICE: 6897		FULL DESC:	10.952 GALS GAS 7/8PD		
053596 SO. VILLAGE	86546		0 2026 2 INV A	24.82 03-26	7.758 GALS GASOLINE
INVOICE: 9455		FULL DESC:	7.758 GALS GASOLINE 7/12PD		
053596 SO. VILLAGE	86548		0 2026 2 INV A	35.05 03-26	10.955 GALS GAS 7/1
INVOICE: 637		FULL DESC:	10.955 GALS GAS 7/14 PD		
053596 SO. VILLAGE	86550		0 2026 2 INV A	31.37 03-26	9.805 GALS GAS 7/17
INVOICE: 2844		FULL DESC:	9.805 GALS GAS 7/17 PD		
053596 SO. VILLAGE	86551		0 2026 2 INV A	40.05 03-26	12.519 GALS GAS 7/1
INVOICE: 2678	06550	FULL DESC:	12.519 GALS GAS 7/17		10 110 0110 5/00 55
053596 SO. VILLAGE	86553	THE PROOF	0 2026 2 INV A	40.63 03-26	13.112 GALS 7/22 PD
INVOICE: 5794	06554	FULL DESC:	13.112 GALS 7/22 PD	20 45 02 05	10 406 0310 030 040
053596 SO. VILLAGE	86554	TITT DDGG	0 2026 2 INV A	38.45 03-26	12.406 GALS GAS 7/2
INVOICE: 6418 053596 SO. VILLAGE	86556	FULL DESC:	12.406 GALS GAS 7/23PD 0 2026 2 INV A	10 76 03 06	2 472 CNIC CNC 7/05
INVOICE: 8170	80000	BILL DECC.	0 2026 2 INV A 3.473 GALS GAS 7/25	10.76 03-26	3.473 GALS GAS 7/25
053596 SO. VILLAGE	86557	FULL DESC:	0 2026 2 INV A	30.37 03-26	9.801 GALS GAS 7/25
INVOICE: 8173	60557	FIII.I. DESC.	9.801 GALS GAS 7/25 PD	30.37 03-20	9.001 GALLO GALO 1/23
053596 SO. VILLAGE	86558	roun Dasc:	0 2026 2 INV A	27.57 03-26	8.897 GALS GAS 7/26
INVOICE: 8567	00330	FILL DESC.	8.897 GALS GAS 7/26 PD	27.37 03 20	0.057 GALD GAD 1720
053596 SO. VILLAGE	86560	robb base.	0 2026 2 INV A	24.20 03-26	7.810 GALS GAS 7/30
INVOICE: 8371	80300	FILL DESC:	7.810 GALS GAS 7/30 PD	24.20 03 20	7.010 GALD GAD 7750
053596 SO. VILLAGE	86562	TODE DESC.	0 2026 2 INV A	26.09 03-26	8.155 GALS GAS 7/31
INVOICE: 1958	00302	FULL DESC:	8.155 GALS GAS 7/31PD	20.03 03 20	0.1100 01110 01110 01110 01110
1300					
				497.49	
			ACCOUNT TOTAL	2,169.60	
				_,,	
10330 08160			VEHICLE MAINTENANCE		
037470 MCGEE FORD	86389		0 2025 12 INV A	336.47 03-26	19 EXPLORER-WHEEL B
INVOICE: 5021000		FULL DESC:	19 EXPLORER-WHEEL BEARING		

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INVOICE LIST BY GL ACCOUNT

YEAR/PERIOD: 2025/1 TO 2026/2 WARRANT CHECK DESCRIPTION ACCOUNT/VENDOR DOCUMENT VOUCHER PO YEAR/PR TYP S 052611 SANEL NAPA 2025 12 INV A 40.02 03-26 19FORD EXP-OIL&FILT 86413 0 INVOICE: 531520 FULL DESC: 19FORD EXP-OIL&FILTER ACCOUNT TOTAL 376.49 10330 08300 DEPARTMENT SUPPLIES 042767 TDS LEASING INC 86570 0 2026 2 INV A 7/25-10/25 WATER CO 105.00 03-26 INVOICE: 1091199 FULL DESC: 7/25-10/25 WATER COOLER RENT PD 052902 SECURSHRED 86537 2026 2 INV A 24.00 03-26 PD-SHREDDING PICKUP FULL DESC: PD-SHREDDING PICKUP 7/24 INVOICE: 497631 ACCOUNT TOTAL 129.00 BUILDING MAINT/SUPPLIES 10330 08380 2025 12 INV A 86384 0 27.83 03-26 TRASH LINERS 035892 MAGEE OFFICE PLUS FULL DESC: TRASH LINERS INVOICE: 035892 MAGEE OFFICE PLUS 86385 0 2025 12 CRM A -27.83 03-26 RETURN LINERS-PD INVOICE: FULL DESC: RETURN LINERS-PD ______ -00 ACCOUNT TOTAL .00 ORG 10330 TOTAL 8,671.26 AMBULANCE DEPARTMENT 10340 MAINTENANCE CONTRACTS 06220 10340 86469 2026 2 INV A 46.00 03-26 7/19 COPIER CONTRAC 0 034875 LEAF INVOICE: 18729456 FULL DESC: 7/19 COPIER CONTRACT AMB/HWY ACCOUNT TOTAL 46.00 10340 07010 TELEPHONE 2025 12 INV A 82.46 03-26 3/4 MOBILE-AMB 2872 012544 AT & T 86357 0 FULL DESC: 3/4 MOBILE-AMB 287293977820 INVOICE: 0 2025 12 INV A 82.46 03-26 7/4-MOBILE-AMB28729 012544 AT & T 86358 FULL DESC: 7/4-MOBILE-AMB287293977820 INVOICE: -----164.92 0 2026 2 INV A 50.00 03-26 AUG25 CELL PHONE 037459 MCCUSKER, MEGGAN INVOICE: FULL DESC: AUG25 CELL PHONE 8/4-PHONE 802485541 042768 TDS TELECOM 86571 0 2026 2 INV A 103.78 03-26 FULL DESC: 8/4-PHONE 8024855411 INVOICE: 50.02 03-26 AUG25 INTERNET AMB/ 2026 2 INV A 055824 TRANS-VIDEO 86577 0 INVOICE: FULL DESC: AUG25 INTERNET AMB/HWY

ACCOUNT TOTAL

368.72

065810 ZOLL MEDICAL CORP 86592

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YEAR/PERIOD: 2025/1 TO : ACCOUNT/VENDOR	2026/2 DOCUMENT	VOUCHE	R PO YEAR/PR TYP S	WAR	RANT CHECK	DESCRIPTION
10340 07020 042896 NFLD TOWN GEN FUND INVOICE:	86511	FULL DESC:	POSTAGE 0 2026 2 INV A JUL 25 POSTAGE	.74 03-	26	JUL 25 POSTAGE
			ACCOUNT TOTAL	.74		
10340 07050			OFFICE SUPPLIES			
035892 MAGEE OFFICE PLUS INVOICE:	86471	FULL DESC:	0 2026 2 INV A 6 CASES 8.5X11 COPY PAPER	26.25 03-	26	6 CASES 8.5X11 COPY
055824 TRANS-VIDEO INVOICE:	86575	FULL DESC:	0 2026 2 INV A AUG25 INTERNET MUN BLD	.51 03-	26	AUG25 INTERNET MUN
055824 TRANS-VIDEO INVOICE:	86577	FULL DESC:	0 2026 2 INV A AUG25 INTERNET AMB/HWY	39.95 03-	26	AUG25 INTERNET AMB/
				40.46		
			ACCOUNT TOTAL	66.71		
10340 08010			ELECTRICITY			
041616 NFLD ELEC DEPT INVOICE:	86492	FULL DESC:	0 2026 2 INV A 7/18-AMB DEPT	35.11 03-	26	7/18-AMB DEPT
			ACCOUNT TOTAL	35.11		
10340 08070			GASOLINE/DIESEL			
042896 NFLD TOWN GEN FUND INVOICE:	86399	FILL DESC.	0 2025 12 INV A JUNE 25 GAS/DIESEL	699.21 03-2	26	JUNE 25 GAS/DIESEL
042896 NFLD TOWN GEN FUND	86400		0 2025 12 INV A	503.46 03-2	26	MAY 25 GAS/DIESEL
INVOICE: 042896 NFLD TOWN GEN FUND	86401	FULL DESC:	MAY 25 GAS/DIESEL 0 2025 12 INV A	823.64 03-2	26	APRIL25 GAS/DIESEL
INVOICE:	00101	FULL DESC:	APRIL25 GAS/DIESEL	023.04 03 2		AFRIDES GAB/DIESED
				2,026.31		
063377 WEX BANK INVOICE: 71948	86589	FULL DESC:	0 2026 2 INV A 7/4-AMB 10.2 GAL DIESEL	41.01 03-2	26	7/4-AMB 10.2 GAL DI
			ACCOUNT TOTAL	2,067.32		
10340 08150 010461 HAUN WELDING SUPPLIY INVOICE: 514269		FULL DESC:	MEDICAL SUPPLIES 0 2025 12 INV A JUNE CYLINDER RENT	32.88 03-2	26	JUNE CYLINDER RENT
014864 BOUND TREE INVOICE: 85835331	86443	FULL DESC:	0 2026 2 INV A STAT PADZ, ELECTRODES, SLINGS, ETC	1,773.52 03-2	26	STAT PADZ, ELECTRODE
017936 CVH INVOICE:	86368	FULL DESC:	0 2025 12 INV A JAN25-PHARMACY	411.78 03-2	26	JAN25-PHARMACY

0 2026 2 INV A

750.00 03-26

PEDIATRIC SENSORS

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INVOICE LIST BY GL ACCOUNT

YEAR/PERIOD: 2025/1 TO 2026/2 ACCOUNT/VENDOR DOCUMENT VOUCHER PO YEAR/PR TYP S WARRANT CHECK DESCRIPTION ______ FULL DESC: PEDIATRIC SENSORS INVOICE: 4240934 065810 ZOLL MEDICAL CORP 86593 770.00 03-26 NEONATE SENSORS 0 2026 2 INV A INVOICE: 4237868 FULL DESC: NEONATE SENSORS 1.520.00 ACCOUNT TOTAL 3.738.18 10340 08160 VEHICLE MAINTENANCE 037470 MCGEE FORD RESTOCK FEE-WATER P 86390 0 2025 12 INV A 52.80 03-26 INVOICE: 6020586 FULL DESC: RESTOCK FEE-WATER PUMP 17AMB 88.06 03-26 MICRO VBELT-AMB 046265 O'REILLY AUTO PARTS 86402 0 2025 12 INV A FULL DESC: MICRO VBELT-AMB 046265 O'REILLY AUTO PARTS 86403 0 2025 12 CRM A -88.06 03-26 RETURN MICRO VBELT-FULL DESC: RETURN MICRO VBELT-AMB INVOICE: 22AMBA2-TUBING-EXHA 86412 0 2025 12 INV A 64.60 03-26 052611 SANEL NAPA FULL DESC: 22AMBA2-TUBING-EXHAUST PIPE INVOICE: 531431 51.96 03-26 DEF-AMBULANCE 0 2026 2 INV A 052611 SANEL NAPA 86530 FULL DESC: DEF-AMBULANCE INVOICE: 531827 116.56 ACCOUNT TOTAL 169.36 DEPARTMENT SUPPLIES 10340 08300 CAR WASH/WAX-AMB 2025 12 INV A 129.48 03-26 021684 BUSINESS CREDIT CARD 86596 FULL DESC: CAR WASH/WAX-AMB INVOICE: ACCOUNT TOTAL 129.48 ORG 10340 TOTAL 6,621,62 HIGHWAY DEPT 10420 HRA 10420 05152 125.71 03-26 2026 1 DIR P 3368 JULY 8,2025 HRA CLA 86313 0 039617 MVP-HRA FULL DESC: JULY 8,2025 HRA CLAIMS CARD INVOICE: ACCOUNT TOTAL 125.71 MAINTENANCE CONTRACTS 10420 06220 7/19 COPIER CONTRAC 86469 0 2026 2 INV A 46.00 03-26 034875 LEAF INVOICE: 18729456 FULL DESC: 7/19 COPIER CONTRACT AMB/HWY ACCOUNT TOTAL 46.00 TELEPHONE 10420 07010 40.44 03-26 6/17-7/16 CELL PHON 0 2026 2 INV A 010495 VERIZON WIRELESS 86581 FULL DESC: 6/17-7/16 CELL PHONE INVOICE: 6118698477

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ACCOUNT/VENDOR	DOCUMENT	VOUCHE			WARRANT CHECK	DESCRIPTION
042768 TDS TELECOM INVOICE:	86571	FULL DESC:	0 2026 2 INV A 8/4-PHONE 8024855411	42.24	03-26	8/4-PHONE 802485541
055824 TRANS-VIDEO	86577	FULL DESC:	0 2026 2 INV A AUG25 INTERNET AMB/HWY	50.01	03-26	AUG25 INTERNET AMB/
			ACCOUNT TOTAL	132.69		
10420 07050			OFFICE SUPPLIES			
035892 MAGEE OFFICE PLUS INVOICE:	86471	FULL DESC:	0 2026 2 INV A 6 CASES 8.5X11 COPY PAPER	26.25	03-26	6 CASES 8.5X11 COPY
			ACCOUNT TOTAL	26.25		
10420 07250			SCHOOL/TRAINING			
046265 O'REILLY AUTO PARTS INVOICE:	86406	FULL DESC:	0 2025 12 INV A P MARTIN-AIR BRAKES CLASS	275.00	03-26	P MARTIN-AIR BRAKES
			ACCOUNT TOTAL	275.00		
10420 08010			ELECTRICITY			
041616 NFLD ELEC DEPT	86493		0 2026 2 INV A	16.09	03-26	7/18-TUCKERS PIT ON
INVOICE: 041616 NFLD ELEC DEPT	86494	FULL DESC:	7/18-TUCKERS PIT ON 12A 0 2026 2 INV A	16.09	02.26	2/10 FP110 GP15 GV5
INVOICE:	00454	FULL DESC:	7/18-FALLS-SALT SHED	16.09	03-26	7/18-FALLS-SALT SHE
				32.18		
			ACCOUNT TOTAL	32.18		
10420 08070			GASOLINE/DIESEL			
028560 GILLESPIE FUELS	86372	DIR. 1. DDGG	0 2025 12 INV A	1,183.07	03-26	443.1 GALS DIESEL-6
INVOICE: 028560 GILLESPIE FUELS	86373	FULL DESC:	443.1 GALS DIESEL-6/3 .0 2025 12 INV A	864.01	03-26	323.6 GALS DIESEL 6
INVOICE:		FULL DESC:	323.6 GALS DIESEL 6/10			
028560 GILLESPIE FUELS INVOICE:	86374	בוווו הפכר.	0 2025 12 INV A 371.6 GALS DIESEL 6/17	992.17	03-26	371.6 GALS DIESEL 6
028560 GILLESPIE FUELS	86375	ronn base.	0 2025 12 INV A	1,140.00	03-26	398.6 GALS DIESEL 6
INVOICE:		FULL DESC:	398.6 GALS DIESEL 6/24			
				4,179.25		
042896 NFLD TOWN GEN FUND	86399		0 2025 12 INV A	3,091.54	03-26	JUNE 25 GAS/DIESEL
INVOICE: 042896 NFLD TOWN GEN FUND	86400	FULL DESC:	JUNE 25 GAS/DIESEL 0 2025 12 INV A	3,131.67	03-26	MAY 25 GAS/DIESEL
INVOICE:	30400	FULL DESC:	MAY 25 GAS/DIESEL	3,131.07		20 0:20/012020
042896 NFLD TOWN GEN FUND INVOICE:	86401		0 2025 12 INV A APRIL25 GAS/DIESEL	3,591.11	03-26	APRIL25 GAS/DIESEL

9,814.32

INVOICE LIST BY GL ACCOUNT

YEAR/PERIOD: 2025/1 TO 2026/2 WARRANT CHECK DESCRIPTION ACCOUNT/VENDOR DOCUMENT VOUCHER PO YEAR/PR TYP S _____ 26.472 GALS GASOLIN 0 2026 2 INV A 82.04 03-26 053596 SO. VILLAGE 86559 FULL DESC: 26.472 GALS GASOLINE-7/30-25CHEVY INVOICE: 8361 ACCOUNT TOTAL 14,075.61 10420 08160 VEHICLE/EOUIPMENT MAINTENANCE 020368 CODY CHEVROLET 86360 2025 12 INV A 49.77 03-26 20 CHEVY6500-HOSE INVOICE: FULL DESC: 20 CHEVY6500-HOSE 0 2025 12 CRM A -49.77 03-26 RETURN HOSES-20 CHE 020368 CODY CHEVROLET 86361 INVOICE: FULL DESC: RETURN HOSES-20 CHEVY6500 50.08 03-26 PIPE 020368 CODY CHEVROLET 86362 0 2025 12 INV A FULL DESC: PIPE INVOICE: RETURN PIPE 0 2025 12 CRM A -8.58 03-26 020368 CODY CHEVROLET 86363 FULL DESC: RETURN PIPE INVOICE: 45.26 03-26 20CHEVY6500-HOSE 0 2025 12 INV A 020368 CODY CHEVROLET 86364 FULL DESC: 20CHEVY6500-HOSE INVOICE: 20 CHEVY6500-RETURN 0 2025 12 CRM A -45.26 03-26 020368 CODY CHEVROLET 86365 INVOICE: FULL DESC: 20 CHEVY6500-RETURN HOSE 20CHEVY6500-LOCKS n 2025 12 INV A 19.08 03-26 020368 CODY CHEVROLET 86366 INVOICE: FULL DESC: 20CHEVY6500-LOCKS 60.58 029195 GOSS DODGE CHRYSLER 86594 2026 2 INV A 559.46 03-26 DODGE SALT-FUEL FIL INVOICE: 749104744 FULL DESC: DODGE SALT-FUEL FILTER 2025 12 INV A 91.70 03-26 TRAILER-SUSPENSION 035360 LUCKY'S TRAILER SALE 86388 0 FULL DESC: TRAILER-SUSPENSION ARM INVOICE: DODGE SALT-UBOLT, R 2025 12 INV A 187.56 03-26 037776 LOWELL MCLEODS 86381 0 FULL DESC: DODGE SALT-UBOLT, REPAIR LEAF INVOICE: 22.47 03-26 14WSTAR-BOLT W/HARD 037776 LOWELL MCLEODS 0 2025 12 INV A FULL DESC: 14WSTAR-BOLT W/HARDWARE INVOICE: 037776 LOWELL MCLEODS 86383 0 2025 12 INV A 1,594.32 03-26 20WSTAR-FRONT SPRIN INVOICE: FULL DESC: 20WSTAR-FRONT SPRING REPAIR 1,804.35 CABIN FILTERS 0 2025 12 INV A 47.03 03-26 046265 O'REILLY AUTO PARTS 86404 FULL DESC: CABIN FILTERS RETURN CABIN FILTER 0 2025 12 CRM A -47.03 03-26 046265 O'REILLY AUTO PARTS 86405 FULL DESC: RETURN CABIN FILTERS INVOICE: RDSIDE MOWER-CONNEC 2026 2 INV A 96.99 03-26 052611 SANEL NAPA 86535 0 FULL DESC: RDSIDE MOWER-CONNECTOR INVOICE: 532571 20GRADER-SERVICE CA 729.24 03-26 056866 UNITED CONSTRUCTION 86421 0 2025 12 INV A FULL DESC: 20GRADER-SERVICE CALL-MILEAGE/TIME INVOICE: 11126975 064800 WOOD'S CRW CORP. 86591 2026 2 INV A 268.28 03-26 VOLVO EXCAVATOR-PIP

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YEAR/PERIOD: 2025/1 TO 2026/2

041616 NFLD ELEC DEPT

041616 NFLD ELEC DEPT

INVOICE:

INVOICE:

86495

86496

INVOICE LIST BY GL ACCOUNT

ACCOUNT/VENDOR DOCUMENT VOUCHER PO YEAR/PR TYP S

-----INVOICE: FULL DESC: VOLVO EXCAVATOR-PIPE ACCOUNT TOTAL 3,610.60 10420 08300 DEPARTMENT SUPPLIES 033562 KIMBALL MIDWEST 86464 2026 2 INV A 559.94 03-26 DEODORIZER, SCREWS, F INVOICE: 103543756 FULL DESC: DEODORIZER, SCREWS, FITTINGS, ETC 052611 SANEL NAPA 86532 2026 2 INV A 21.98 03-26 DISPOSABLE GLOVES INVOICE: 532438 FULL DESC: DISPOSABLE GLOVES ACCOUNT TOTAL 581.92 ORG 10420 TOTAL 18,905.96 10430 CEMETERY 06030 10430 TREE REMOVAL 013085 BW MASONRY/ LANDSCAP 86448 0 2026 2 INV A 400.00 03-26 7/22-RD SIDE TREE W FULL DESC: 7/22-RD SIDE TREE WORK INVOICE: ACCOUNT TOTAL 400.00 CEMETERY CARE CONTRACT 013085 BW MASONRY/ LANDSCAP 86451 0 2026 2 INV A 8,595.00 03-26 AUG 25 CONTRACT INVOICE: FULL DESC: AUG 25 CONTRACT ACCOUNT TOTAL 8,595.00 10430 06344 SEXTON 013085 BW MASONRY/ LANDSCAP 86446 0 2026 2 INV A 900.00 03-26 7/19-2 BURIALS-MT H INVOICE: FULL DESC: 7/19-2 BURIALS-MT HOPE 013085 BW MASONRY/ LANDSCAP 86447 0 2026 2 INV A 400.00 03-26 7/23-BURIAL MT HOPE INVOICE: FULL DESC: 7/23-BURIAL MT HOPE 013085 BW MASONRY/ LANDSCAP 86449 0 2026 2 INV A 400.00 03-26 7/23-BURIAL FALLS C INVOICE: FULL DESC: 7/23-BURIAL FALLS CEMETERY 013085 BW MASONRY/ LANDSCAP 86450 0 2026 2 INV A 450.00 03-26 7/19-BURIAL MT HOPE INVOICE: FULL DESC: 7/19-BURIAL MT HOPE ------2,150.00 ACCOUNT TOTAL 2,150.00 10430 08010 ELECTRICITY

2026 2 INV A

ACCOUNT TOTAL

0 2026 2 INV A

10.15 03-26

10.15 03-26

20.30

20.30

7/18-CEMETERIES-ELM

7/18-CEMETERIES-MT

n

FULL DESC: 7/18-CEMETERIES-ELMWOOD

FULL DESC: 7/18-CEMETERIES-MT HOPE

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WARRANT CHECK DESCRIPTION

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INVOICE LIST BY GL ACCOUNT

YEAR/PERIOD: 2025/1 TO 2026/2 WARRANT CHECK DESCRIPTION ACCOUNT/VENDOR DOCUMENT VOUCHER PO YEAR/PR TYP S -----WATER 10430 08030 40.80 03-26 7/18-MT HOPE CEMETE 043552 NORTHFIELD 86515 0 2026 2 INV A FULL DESC: 7/18-MT HOPE CEMETERY INVOICE: ACCOUNT TOTAL 40.80 ORG 10430 TOTAL 11,206.10 TOWN GARAGE 10440 TRASH DISPOSAL 10440 06060 11936 AUG25 RECYCLI 33.85 03-26 0 2026 2 INV A 010062 MYERS CONTAINER, CORP 86474 FULL DESC: 11936 AUG25 RECYCLING INVOICE: 109.29 03-26 0 2026 2 INV A 36736 AUG25 DUMPSTE 010062 MYERS CONTAINER, CORP 86475 INVOICE: FULL DESC: 36736 AUG25 DUMPSTER 7/1-WATER COOLER DI 0 2026 2 INV A 15.00 03-26 010062 MYERS CONTAINER, CORP 86476 FULL DESC: 7/1-WATER COOLER DISPOSAL-AMB INVOICE: 11732 AUG25 DUMPSTE 170.69 03-26 010062 MYERS CONTAINER, CORP 86477 0 2026 2 INV A FULL DESC: 11732 AUG25 DUMPSTER INVOICE: 328.83 ACCOUNT TOTAL 328.83 TELEPHONE 10440 07010 67.55 03-26 8/4-PHONE 802485541 0 2026 2 INV A 86571 042768 TDS TELECOM FULL DESC: 8/4-PHONE 8024855411 INVOICE: 67.55 ACCOUNT TOTAL ELECTRICITY 10440 08010 7/18-RADIO SHACK 2026 2 INV A 27.53 03-26 041616 NFLD ELEC DEPT 86497 FULL DESC: 7/18-RADIO SHACK INVOICE: 27.53 ACCOUNT TOTAL ELECTRIC-SOLAR 08013 10440 518.83 03-26 BULLRUN SOLAR-JULY 2026 2 INV A 052905 SENIOR RENEWABLES, L 86539 FULL DESC: BULLRUN SOLAR-JULY INVOICE: 190 ACCOUNT TOTAL 518.83 HEATING FUEL 10440 08020 8.2 GALS PROPANE-RE 0 2025 12 INV A 12.95 03-26 86379 028560 GILLESPIE FUELS FULL DESC: 8.2 GALS PROPANE-READ HWY 6/26 INVOICE: 12.95 ACCOUNT TOTAL 10440 08030 7/18-MUN GARAGE 93.91 03-26 0 2026 2 INV A 043552 NORTHFIELD 86516 FULL DESC: 7/18-MUN GARAGE INVOICE:

ACCOUNT TOTAL

93.91

INVOICE LIST BY GL ACCOUNT

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YEAR/PERIOD:	2025/1	TO	2026/2	
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ACCOUNT/VENDOR	DOCUMENT	VOUCHE	•	TYP S		WARRANT	CHECK	DESCRIPTION
10440 08050			SEWER					
043552 NORTHFIELD	86516		0 2026 2	A VMI	117.52	03-26		7/18-MUN GARAGE
INVOICE:	F	FULL DESC:	7/18-MUN GARAGE					
			ACCOUNT TO	FAL	117.52			
			ORG 10440 TO	ΓAL	1,167.12			
10445		LIBRARY/	HISTORICAL SOCIETY I	BLD				
10445 06090			JANITORIAL SER	RVICES				
053855 SPOTLESS CLEANING	86563		0 2026 2 3	INV A	200.00	03-26		6/29-7/5 CLEANING S
INVOICE:	F	ULL DESC:	6/29-7/5 CLEANING S	SRVCS				
053855 SPOTLESS CLEANING	86564		0 2026 2 1	INV A	200.00	03-26		7/6-7/12 CLEANING S
INVOICE:		ULL DESC:	7/6-7/12 CLEANING S					
053855 SPOTLESS CLEANING	86565		0 2026 2 1		200.00	03-26		7/13-7/19 CLEANING
INVOICE:		ULL DESC:	7/13-7/19 CLEANING					
053855 SPOTLESS CLEANING INVOICE:	86566		0 2026 2 1		200.00	03-26		7/20-7/26 CLEANING
INVOICE:	F.	OLL DESC:	7/20-7/26 CLEANING					
					800.00			
			ACCOUNT TOT	AL	800.00			
10445 08010			ELECTRICITY					
041616 NFLD ELEC DEPT	86498		0 2026 2 I	מ נואר	104.87	03-26		7/18-LIBRARY
INVOICE:		ULL DESC:	7/18-LIBRARY	in a	104.07	03-26		// 16-LIBRARI
			·,					
			ACCOUNT TOT	AL	104.87			
10445 08013			ELECTRIC-SOLAR					
052905 SENIOR RENEWABLES,	L 86539		0 2026 2 I	NV A	559.84	03-26		BULLRUN SOLAR-JULY
INVOICE: 190	F	JLL DESC:	BULLRUN SOLAR-JULY					
			ACCOUNT TOT.	AL	559.84			
10445 08030			MARIN					
	86517		WATER	NT7 3	22.16			= /4.0 . = ======
		III DECC.	0 2026 2 II 7/18-LIBRARY	NV A	33.16 (	03-26		7/18-LIBRARY
INVOICE:	F	DESC:	// 10-DIBRARI					
			ACCOUNT TOTA	ΔΤ.	33.16			
			11000011 1011		33.10			
10445 08050			SEWER					
043552 NORTHFIELD	86517		0 2026 2 II	NV A	38.85 (	3-26		7/18-LIBRARY
INVOICE:	FU	JLL DESC:	7/18-LIBRARY					
			ACCOUNT TOTA	AL	38.85			
			ORG 10445 TOTA	AL	1,536.72			

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YEAR/PERIOD: 2025/1 TO 2026/2

INVOICE LIST BY GL ACCOUNT

YEAR/PERIOD: 2025/1 TO 2 ACCOUNT/VENDOR	DOCUMENT	VOUCHER	PO YEAR/PR TYP S		WARRANT CHECK	DESCRIPTION
10447		MUNICIPA	L BUILDING			
10447 06060			TRASH DISPOSAL			
010062 MYERS CONTAINER, CORP	86474		0 2026 2 INV A	33.86	03-26	11936 AUG25 RECYCLI
INVOICE:		FULL DESC:	11936 AUG25 RECYCLING			
010062 MYERS CONTAINER, CORP	86475		0 2026 2 INV A	109.29	03-26	36736 AUG25 DUMPSTE
INVOICE:		FULL DESC:	36736 AUG25 DUMPSTER	170 60	22.26	11720 11701 DIMPORE
010062 MYERS CONTAINER, CORP	86477	BUTT DEGG	0 2026 2 INV A	170.69	03-26	11732 AUG25 DUMPSTE
INVOICE:		FULL DESC:	11732 AUG25 DUMPSTER			
				313.84		
				515.01		
			ACCOUNT TOTAL	313.84		
10447 06090			JANITORIAL SERVICES			
053855 SPOTLESS CLEANING	86563		0 2026 2 INV A	200.00	03-26	6/29-7/5 CLEANING S
INVOICE:		FULL DESC:	6/29-7/5 CLEANING SRVCS			
053855 SPOTLESS CLEANING	86564		0 2026 2 INV A	200.00	03-26	7/6-7/12 CLEANING S
INVOICE:		FULL DESC:	7/6-7/12 CLEANING SRVCS			- / /
053855 SPOTLESS CLEANING	86565		0 2026 2 INV A	200.00	03-26	7/13-7/19 CLEANING
INVOICE:		FULL DESC:	7/13-7/19 CLEANING SRVCS	200 00	03.06	7/20 7/26 GIEANING
053855 SPOTLESS CLEANING	86566		0 2026 2 INV A	200.00	03-26	7/20-7/26 CLEANING
INVOICE:		FULL DESC:	7/20-7/26 CLEANING SRVCS			
				800.00		
			ACCOUNT TOTAL	800.00		
10447 08010			ELECTRICITY			
041616 NFLD ELEC DEPT	86499		0 2026 2 INV A	16.09	03-26	7/18-KENT ST GARAGE
INVOICE:		FULL DESC:	7/18-KENT ST GARAGE(OLD TDS)			
			ACCOUNT TOTAL	16.09		
			ACCOUNT TOTAL	16.09		
10447 08013			ELECTRIC-SOLAR			
052905 SENIOR RENEWABLES, L	86539		0 2026 2 INV A	403.40	03-26	BULLRUN SOLAR-JULY
INVOICE: 190	00333	FULL DESC:	BULLRUN SOLAR-JULY			
1110101. 130		10000				
			ACCOUNT TOTAL	403.40		
10447 08020			HEATING FUEL			
028560 GILLESPIE FUELS	86376		0 2025 12 INV A	82.80	03-26	40.0 GALS PROPANE 6
INVOICE:		FULL DESC:	40.0 GALS PROPANE 6/13 MUN BLD G	ENERATOR		
			ACCOUNT TOTAL	82.80		
10445			WATER			
10447 08030	06510		0 2026 2 INV A	38.29	03-26	7/18-MUN BUILDING
	86518	PIII.I. DPCC.	7/18-MUN BUILDING	50.25		., 20 1.011 20122110
INVOICE:		FORD DESC:	., 10 FOR DOIDDING			
			ACCOUNT TOTAL	38.29		
				,,		

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YEAR/PERIOD: 2025/1 TO ACCOUNT/VENDOR	2026/2 DOCUMENT	VOUCHE:	R PO YEAR/PR			WARRANT	CHECK	DESCRIPTION
10447 08050 043552 NORTHFIELD INVOICE:	86518	FULL DESC:	SEWER 0 2026 2 7/18-MUN BUILDING	2 INV A 3	48.68	03-26		7/18-MUN BUILDING
			ACCOUNT 1	TOTAL	48.68			
10447 08380			BUILDING MAJ	INT/SUPPLIES				
014906 BRADY PLUS INVOICE: 1034530	86444	FULL DESC:	0 2026 2 PAPER TOWELS-MUN	BLD	160.44	03-26		PAPER TOWELS-MUN BL
035892 MAGEE OFFICE PLUS INVOICE:	86470	FULL DESC:	0 2026 2 12 BOXES COFFEE	2 INV A	192.48	03-26		12 BOXES COFFEE
			ACCOUNT 1	TOTAL	352.92			
			ORG 10447 T	TOTAL	2,056.02			
10510		HUMAN SI	ERVICES					
10510 06150			SENIOR CENTE	ER				
042512 NFLD SENIOR CTR. INVOICE:	86509	FULL DESC:	0 2026 2 AUG 25 ALLOCATION		2,083.00	03-26		AUG 25 ALLOCATION
			ACCOUNT T	COTAL	2,083.00			
			ORG 10510 T	TOTAL	2,083.00			
10520		GROUNDS	PARKS/FACILITIES					
10520 08010			ELECTRICITY					
041616 NFLD ELEC DEPT	86500		0 2026 2		36.83	03-26		7/18-FALLS PARK FIE
INVOICE:		FULL DESC:	7/18-FALLS PARK F					
041616 NFLD ELEC DEPT	86501		0 2026 2		16.23	03-26		7/18-MEMORIAL PARK(
INVOICE: 041616 NFLD ELEC DEPT	86502	FULL DESC:	7/18-MEMORIAL PAR 0 2026 2		18.09	02.00		7/18-WELCOME SIGN I
INVOICE:	805,02	FULL DESC:	7/18-WELCOME SIGN			03-26		//18-WELCOME SIGN I
					71.15			
			ACCOUNT T	OTAL	71.15			
10520 08030			WATER					
043552 NORTHFIELD	86519		0 2026 2	INV A	25.31	03-26		7/18-MEM PK BATHROO
INVOICE:		FULL DESC:	7/18-MEM PK BATHR	OOMŠ				
043552 NORTHFIELD	86520		0 2026 2	INV A	187.06	03-26		7/18-FALLS FIELD
INVOICE:		FULL DESC:	7/18-FALLS FIELD					
043552 NORTHFIELD	86521		0 2026 2		585.05	03-26		7/18-FOUNTAIN ON CO
INVOICE:	06500	FULL DESC:	7/18-FOUNTAIN ON 0 2026 2		40.00	02.26		7/10 00000000000000000000000000000000000
043552 NORTHFIELD INVOICE:	86522	FULL DESC:	0 2026 2 7/18-COMMUNITY GA		42.90	V3-20		7/18-COMMUNITY GARD
					840.32			

ACCOUNT TOTAL

840.32

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INVOICE LIST BY GL ACCOUNT

YEAR/PERIOD: 2025/1 TO 2026/2 YEAR/PR TYP S ACCOUNT/VENDOR DOCUMENT VOUCHER PO WARRANT CHECK DESCRIPTION _____ SEWER 10520 08050 86519 0 2026 2 INV A 23.81 03-26 7/18-MEM PK BATHROO 043552 NORTHFIELD FULL DESC: 7/18-MEM PK BATHROOMS INVOICE: ACCOUNT TOTAL 23.81 10520 08070 GASOLINE/DIESEL JUNE 25 GAS/DIESEL 042896 NFLD TOWN GEN FUND 86399 0 2025 12 INV A 193.25 03-26 FULL DESC: JUNE 25 GAS/DIESEL INVOICE: 042896 NFLD TOWN GEN FUND 86400 0 2025 12 INV A 137.02 03-26 MAY 25 GAS/DIESEL FULL DESC: MAY 25 GAS/DIESEL 042896 NFLD TOWN GEN FUND 86401 0 2025 12 INV A 13.72 03-26 APRIL25 GAS/DIESEL INVOICE: FULL DESC: APRIL25 GAS/DIESEL ACCOUNT TOTAL 343.99 10520 08570 FACILITY SUPPLIES/MAINTENANCE 2025 12 INV A 7.99 03-26 COPPER FITTING-DRIN 010128 ACE HARDWARE 86339 INVOICE: FULL DESC: COPPER FITTING-DRINKING FOUNTAIN-COMMON 0 2025 12 INV A 12.99 03-26 010128 ACE HARDWARE 86340 VALVE-DRINKING FOUN FULL DESC: VALVE-DRINKING FOUNTAIN COMMON INVOICE: 16.99 03-26 0 2025 12 INV A STLTCONE-DRINKING F 010128 ACE HARDWARE 86341 FULL DESC: SILICONE-DRINKING FOUNTAIN COMMON INVOICE: 86342 0 2025 12 INV A 1.50 03-26 3/8 INSERTS-DRINKIN 010128 ACE HARDWARE FULL DESC: 3/8 INSERTS-DRINKING FOUNTAIN-COMMON INVOICE: 010128 ACE HARDWARE 86343 0 2025 12 INV A 2.50 03-26 3/8 O RINGS-DRINKIN TNVOTOR. FULL DESC: 3/8 O RINGS-DRINKING FOUNTAIN COMMON 41.97 86574 2026 2 INV A 54.95 03-26 AUG25 WIFI PK CAMER 055824 TRANS-VIDEO FULL DESC: AUG25 WIFI PK CAMERAS INVOICE:

> ACCOUNT TOTAL 234.92

138.00 03-26

7/17-8/13 PORTALET

MAY/JUN25 FLOWERS-G

7/11-SUNFLOWERS-GAR

GARDEN SUPPLIES 10520 08575

064100 WIND RIVER ENVIRON 86590

INVOICE:

86420 2025 12 INV A 449.76 03-26 056208 TROMBLY'S GREEN FULL DESC: MAY/JUN25 FLOWERS-GARDEN INVOICE: 893587 36.80 03-26 056208 TROMBLY'S GREEN 86579 2026 2 INV A

0

FULL DESC: 7/11-SUNFLOWERS-GARDEN INVOICE:

486.56

486.56

ORG 10520 TOTAL 2,000.75

ACCOUNT TOTAL

2026 2 INV A

FULL DESC: 7/17-8/13 PORTALET RENT-TRANSFER STATION

10550

08570

014906 BRADY PLUS

INVOICE: 10372302

86445

YEAR/PERIOD: 2025/1 TO 2026/2 ACCOUNT/VENDOR DOCUMENT VOUCHER PO YEAR/PR TYP S WARRANT CHECK DESCRIPTION 10530 RECREATION COMMITTEE 10530 07020 042896 NFLD TOWN GEN FUND 86511 0 2026 2 INV A 1.43 03-26 JUL 25 POSTAGE FULL DESC: JUL 25 POSTAGE ACCOUNT TOTAL 1.43 ORG 10530 TOTAL 1.43 10550 POOL 10550 08010 ELECTRICITY 041616 NFLD ELEC DEPT 86503 0 2026 2 INV A 71.83 03-26 7/18-MUNICIPAL POOL INVOICE: FULL DESC: 7/18-MUNICIPAL POOL ACCOUNT TOTAL 71.83 10550 08013 ELECTRIC-SOLAR 052905 SENIOR RENEWABLES, L 86539 0 2026 2 INV A 469.32 03-26 BULLRUN SOLAR-TULY INVOICE: 190 FULL DESC: BULLRUN SOLAR-JULY ACCOUNT TOTAL 469.32 10550 08030 WATER 043552 NORTHFIELD 86523 2026 2 INV A 2,981.90 03-26 7/18-MEM PK POOL INVOICE: FULL DESC: 7/18-MEM PK POOL 043552 NORTHFIELD 86524 0 2026 2 INV A 85.85 03-26 7/18-POOL BATHHOUSE INVOICE: FULL DESC: 7/18-POOL BATHHOUSE 3,067.75 ACCOUNT TOTAL 3,067.75 10550 08050 SEWER 2026 2 INV A 043552 NORTHFIELD 86523 0 3,419.77 03-26 7/18-MEM PK POOL INVOICE: FULL DESC: 7/18-MEM PK POOL 043552 NORTHFIELD 86524 0 2026 2 INV A 68.36 03-26 7/18-POOL BATHHOUSE INVOICE: FULL DESC: 7/18-POOL BATHHOUSE -----3,488.13 ACCOUNT TOTAL 3,488.13 10550 08100 CHEMICALS 011024 ALLEN ENGIN 86441 2026 2 INV A 792.50 03-26 200GALS LIQ CHLORIN INVOICE: FULL DESC: 200GALS LIQ CHLORINE-7/15 POOL ACCOUNT TOTAL 792 50

FACILITY SUPPLIES/MAINTENANCE

2026 2 INV A

FULL DESC: PAPER TOWELS/BATH TISSUE-POOL

140.73 03-26

PAPER TOWELS/BATH T

INVOICE:

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INVOICE LIST BY GL ACCOUNT

YEAR/PERIOD: 2025/1 TO 2026/2 ACCOUNT/VENDOR DOCUMENT VOUCHER PO YEAR/PR TYP S WARRANT CHECK DESCRIPTION 71.89 03-26 HANDICAP PARKING SI 021684 BUSINESS CREDIT CARD 86457 2026 2 INV A 0 FULL DESC: HANDICAP PARKING SIGNS-POOL INVOICE: 7/14-POOL-DRAIN ISS 028560 GILLESPIE FUELS 86461 0 2026 2 INV A 292.50 03-26 INVOICE: FULL DESC: 7/14-POOL-DRAIN ISSUE FLOATS & ROPES-POOL 2026 2 INV A 539.79 03-26 050448 RECREONICS INC 86528 0 INVOICE: FULL DESC: FLOATS & ROPES-POOL 1,044.91 ACCOUNT TOTAL ORG 10550 TOTAL 8,934.44 MANAGEMENT SUPPORT 10610 06010 PROFESSIONAL SERVICES 10610 0 2025 12 INV A 5/29-6/30 PI SERVIC 10.969.80 03-26 049389 QUEEN CITY P.I., LLC 86434 FULL DESC: 5/29-6/30 PI SERVICES INVOICE: ACCOUNT TOTAL 10,969.80 LEGAL SERVICES 10610 06020 86414 2025 12 INV A 357.60 03-26 MAY25-LEGAL-SELECTB 054200 STITZEL INVOICE: 92858 FULL DESC: MAY25-LEGAL-SELECTBOARD ACCOUNT TOTAL 357.60 AUDITS 10610 06100 2026 2 INV A 750.00 03-26 PROGRESS BILL STAND 033637 KITTELL BRANAGAN & S 86465 FULL DESC: PROGRESS BILL STAND. AUDIT FY24-25 INVOICE: 98457 ACCOUNT TOTAL 750.00 10610 06220 MAINTENANCE CONTRACTS JUNE DUO MFA CONTRA 054400 SYMOUEST GROUP INC. 86415 2025 12 INV A 114.00 03-26 FULL DESC: JUNE DUO MFA CONTRACT INVOICE: 2020402 131.00 03-26 JUNE BACKUP CONTRAC 0 2025 12 INV A 054400 SYMOUEST GROUP INC. 86416 INVOICE: 2020577 FULL DESC: JUNE BACKUP CONTRACT JUNE MEDR CONTRACT 171.00 03-26 054400 SYMQUEST GROUP INC. 86417 0 2025 12 INV A INVOICE: 2020992 FULL DESC: JUNE MEDR CONTRACT 054400 SYMQUEST GROUP INC. 86418 0 2025 12 INV A 333.00 03-26 JUNE M3650FFICE CON FULL DESC: JUNE M3650FFICE CONTRACT INVOICE: 2020293 237.60 03-26 7/20-8/19 COPIER (2 054400 SYMQUEST GROUP INC. 86569 0 2026 2 INV A FULL DESC: 7/20-8/19 COPIER (2) CONTRACT INVOICE: 2017652 986.60 ACCOUNT TOTAL 986.60 HEALTH ADMIN/FEES 10610 06380 JUN25 HRA ADMIN FEE 2025 12 INV A 12.70 03-26 010037 COMBINED SERVICES, L 86370

FULL DESC: JUN25 HRA ADMIN FEE

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INVOICE LIST BY GL ACCOUNT apinvgla

YEAR/PERIOD: 2025/1 TO 2 ACCOUNT/VENDOR	DOCUMENT		•			WARRANT	CHECK	DESCRIPTION
057050 UNITED STATES TREASU	86335	FULL DESC:	0 2025 2025HRA TX FOR	12 INV P CY2024 FORM		03-26	100470	2025HRA TX FOR CY20
			ACCOUNT	TOTAL	72.14			
10610 08040			STREET LIG	HTS				
041616 NFLD ELEC DEPT INVOICE:	86504	PHIL DECC.	0 2026 7/18-LIGHTS ON	2 INV A	149.78	03-26		7/18-LIGHTS ON COMM
041616 NFLD ELEC DEPT	86505	FULL DESC:		2 INV A	31.82	03-26		7/18-LIGHTS-NORTH/W
INVOICE:		FULL DESC:	7/18-LIGHTS-NOR					.,
041616 NFLD ELEC DEPT	86506		0 2026	2 INV A	16.09	03-26		7/18-TRAFFIC LIGHT
INVOICE:		FULL DESC:	7/18-TRAFFIC LI	GHT				
041616 NFLD ELEC DEPT	86507				120.41	03-26		7/18-WALL STREET FL
INVOICE: 041616 NFLD ELEC DEPT	0.6500	FULL DESC:	7/18-WALL STREE					B (40 more) on 1 more
INVOICE:	86508	יווות הפפרי	0 2026 7/18-TOWN ST LIC		1,395.50	03-26		7/18-TOWN ST LIGHTS
invoici.		PUBL DESC.	//10-10MN 51 DI					
					1,713.60			
			ACCOUNT	TOTAL	1,713.60			
			ORG 10610	TOTAL	14,849.74			
10620		PLANNING/	ZONTNO					
10620 07010		FIMMING	TELEPHONE					
042768 TDS TELECOM	86571		0 2026	2 INV A	33.44	03-26		8/4-PHONE 802485541
INVOICE:		FULL DESC:	8/4-PHONE 80248					, , , , , , , , , , , , , , , , , , , ,
			ACCOUNT	TOTAL	33.44			
10620 07020			POSTAGE					
042896 NFLD TOWN GEN FUND	86511		0 2026	2 INV A	80.77	03-26		JUL 25 POSTAGE
INVOICE:		FULL DESC:	JUL 25 POSTAGE					
			ACCOUNT	TOTAL	80.77			
10620 07050			OFFICE SUP	PLIES				
055824 TRANS-VIDEO	86575			2 INV A	12.54	03-26		AUG25 INTERNET MUN
INVOICE:		FULL DESC:	AUG25 INTERNET	MUN BLD				
			ACCOUNT	TOTAL	12.54			
10620 07170			ADVERTISING	S/LEGAL NOTI	CES			
055184 TIMES ARGUS	86573			2 INV A	113.44	03-26		7/12DRB MEETING 000
INVOICE: 163320		FULL DESC:	7/12DRB MEETING	00001613				
			ACCOUNT	TOTAL	113.44			
			ORG 10620	TOTAL	240.19			

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INVOICE LIST BY GL ACCOUNT

YEAR/PERIOD: 2025/1 TO ACCOUNT/VENDOR	•	ER PO YEAR/PR	TYP S	WARRANT CHECK	DESCRIPTION
10645 10645 07010 042768 TDS TELECOM INVOICE:	86571	TELEPHONE  0 2026  8/4-PHONE 802485		77 03-26	8/4-PHONE 802485541
		ACCOUNT '	TOTAL 35.	77	
10645 07050 055824 TRANS-VIDEO INVOICE:	86575 FULL DESC	OFFICE SUPP 0 2026 : AUG25 INTERNET !	2 INV A 12.	54 03-26	AUG25 INTERNET MUN
		ACCOUNT '	TOTAL 12.	54	
10645 07070 021684 BUSINESS CREDIT CA INVOICE:		0 2025 1	GS/SUBSCRIPTIONS 2 INV A 194.: USINESS GUIDE DOMAIN/PRI	21 03-26 VACY	6/16-HOSTGATOR-BUSI
		ACCOUNT :	TOTAL 194.	21	
		ORG 10645	TOTAL 242.	52	
FUND 010 T	TOWN GENERAL FUND		TOTAL: 94,753.	======================================	

INVOICE LIST BY GL ACCOUNT

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ACCOUNT/VENDOR	DOCUMENT	VOUCHER	PO YEAR/PR	TYP S		WARRANT	CHECK	DESCRIPTION
36042		CIP - TO	WN HIGHWAY					
36042 09187			SIDEWALK-VIN	NE ST				
041616 NFLD ELEC DEPT	86391		0 2025 12	A VMI	14,614.91	03-26		POLE REPLACEMENT-VI
INVOICE:		FULL DESC:	POLE REPLACEMENT-	-VINE ST SII	DEWLK			
			ACCOUNT 1	TOTAL	14,614.91			
36042 092404			BRIDGE-COVER	RED SLAUGHTE	ERHOUSE			
060143 VERMONT HEAVY TIMBER INVOICE: 955877	86595	FULL DESC:	0 2026 2 SLAUGHTERHOUSE BE	NO A R-DEPOSIT	40,000.00	03-26		SLAUGHTERHOUSE BR-D
			ACCOUNT I	TOTAL	40,000.00			
36042 09243			BRIDGES-MAIN	I ST				
058000 VT AGCY TRANS.	86422		0 2025 12	NV A	2,459.90	03-26		MAY25-MAIN ST BRIDG
INVOICE:		FULL DESC:	MAY25-MAIN ST BRI	DGE60				
058000 VT AGCY TRANS.	86423		0 2025 12		1,402.41	03-26		JUNE25 MAIN ST BRID
INVOICE:		FULL DESC:	JUNE25 MAIN ST BR					
					3,862.31			
			ACCOUNT T	OTAL	3,862.31			
36042 920025			TURKEY HILL	RD REGRAVEL	<u>.</u>			
047248 PIKE INDUSTRIES	86407		0 2025 12	INV A	39,211.56	03-26		2041.25TONS 1.5"CRU
INVOICE:		FULL DESC:	2041.25TONS 1.5"C	RUSHED STON	NE TURKEY HILL 6	/9-11		
047248 PIKE INDUSTRIES	86408		0 2025 12	CRM A	-1,224.47	03-26		CRDT 127.55TONS 1.5
INVOICE: 1331086		FULL DESC:	CRDT 127.55TONS 1			· ·		
047248 PIKE INDUSTRIES INVOICE: 1332591	86409	PHILI DECC.	0 2025 12		2,531.87	03-26		127.55TONS 1.5"CRUS
INVOICE: 1332591		FOLL DESC:	127.55TONS 1.5"CR		TURKEIHILL 6/9			
					40,518.96			
			ACCOUNT T	OTAL	40,518.96			
			ORG 36042 T	OTAL	98,996.18			
36052		CIP - GRO	OUNDS/PARKS/FACILI					
36052 09372 056208 TROMBLY'S GREEN	86420		FROM GARDEN 0 2025 12		587.73	03-26		MAY/JUN25 FLOWERS-G
INVOICE: 893587		FULL DESC:	MAY/JUN25 FLOWERS		507.73	UJ-2U		PERI/CONZO FLOWERS-G
			ACCOUNT T	OTAL	587.73			
			ORG 36052 T	OTAL	587.73			

FUND 360 TOWN C.I.P. FUND TOTAL: 99,583.91

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INVOICE LIST BY GL ACCOUNT tlaw

YEAR/PERIOD: 2025/1 TO 2026/2 WARRANT CHECK DESCRIPTION YEAR/PR TYP S ACCOUNT/VENDOR DOCUMENT VOUCHER PO 51000 ELECTRIC - BALANCE SHEET 51000 14210 CUSTOMER ACCNT RECEIVABLE 010117 NORTHFIELD MUNICIPAL 86439 0 2026 2 INV A 796.80 03-26 MESTAS TRUST APPLY INVOICE: 86439 FULL DESC: MESTAS TRUST APPLY TO TAXES ACCOUNT TOTAL 796.80 SALES TAX PAYABLE 51000 23612 2,631.63 03-26 0 2026 2 INV A SALES TAX JULY 25 059376 VT. DEPT. OF TAXES 86582 FULL DESC: SALES TAX JULY 25 INVOICE: ACCOUNT TOTAL 2,631.63 51000 23615 ENERGY EFF CHARGE PAID 039875 NECA VEEU 86584 0 2026 2 INV A 23,984.57 03-26 EEC JULY 2025 FULL DESC: EEC JULY 2025 INVOICE: ACCOUNT TOTAL 23.984.57 SANDERS-LOAN BILLED CUSTOMER 51000 23620 0 2026 2 INV A 11,815.97 03-26 JUL 2025 CABOT LOAN 061456 VT PUBLIC POWER SUPP 86588 FULL DESC: JUL 2025 CABOT LOAN PAYMENT INVOICE: ACCOUNT TOTAL 11,815.97 51000 COBRA .87 03-26 100470 2025HRA TX FOR CY20 0 2025 12 INV P 057050 UNITED STATES TREASU 86335 FULL DESC: 2025HRA TX FOR CY2024 FORM720 INVOICE: ACCOUNT TOTAL .87 U/G N MAIN 15-BRIDGE PREPARE 51000 36715 0 2025 12 INV A 110.00 03-26 JUNE-CONDUITS-C1 VT 025240 DUFRESNE GROUP 86437 FULL DESC: JUNE-CONDUITS-C1 VTRANS INVOICE: 19912 ACCOUNT TOTAL 110.00 SERVICES 51000 36910 2025 12 INV A 1,259.66 03-26 NEW SRVC-48MILL ST 030352 GREEN MTN. POWER 86425 FULL DESC: NEW SRVC-48MILL ST GARAGE CUSTOMER685.16 INVOICE: 45948 NEW U/G SERVICE-FAI 0 2025 12 INV A 876.25 03-26 030352 GREEN MTN. POWER 86428 FULL DESC: NEW U/G SERVICE-FAIRGROUNDS INVOICE: 45943

ACCOUNT TOTAL

ORG 51000 TOTAL

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2,135.91

2,135.91

41,475.75

51047 59710

030352 GREEN MTN. POWER 86431

INVOICE: 45925

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INVOICE LIST BY GL ACCOUNT

YEAR/PERIOD: 2025/1 TO 2 ACCOUNT/VENDOR	026/2 DOCUMENT	VOUCHER	PO	YEAR/PR	TYP S		WARRANT	CHECK	DESCRIPTION
51001		ELECTRIC	- REVI	ENUE					
51001 41915			1	TRANSCO NET	SETTLEMENT CRI	EDITS			
061456 VT PUBLIC POWER SUPP INVOICE:	86424	FULL DESC:	0 JUNE I		2 INV A	-22,555.19	03-26		JUNE POWER BILL
				ACCOUNT '	TOTAL	-22,555.19			
			ord	3 51001 °	TOTAL	-22,555.19			
51047		ELECTRIC	DEPART	MENT					
51047 40815			F	TUEL GROSS	RECEIPTS TAX				
059376 VT. DEPT. OF TAXES INVOICE:	86583	FULL DESC:	0 FUEL 1		2 INV A 25	1,604.36	03-26		FUEL TAX JULY 2025
				ACCOUNT !	TOTAL	1,604.36			
51047 40816			F	LOT PAYME	NT				
042896 NFLD TOWN GEN FUND INVOICE:	86510	FULL DESC:	0 AUG 25		2 INV A	7,990.00	03-26		AUG 25 PILOT
				ACCOUNT 1	LATO	7,990.00			
51047 55510			P	URCHASED PO	OWER				
061456 VT PUBLIC POWER SUPP	86424		0			209,793.89	03-26		JUNE POWER BILL
INVOICE:		FULL DESC:	JUNE P	OWER BILL					
				ACCOUNT 1	COTAL	209,793.89			
51047 58110			P	LANT-SUPPLI	ES/SM TOOLS/EQ	UIP			
021684 BUSINESS CREDIT CARD			0	2025 12		189.98	03-26		DIGITAL CLAMP METER
INVOICE:		FULL DESC:	DIGITA	L CLAMP MET	TERS-2				
				ACCOUNT 1	COTAL	189.98			
51047 59310			0	VERHEAD MAI	INT				
030352 GREEN MTN. POWER	86426		0	2025 12	INV A	1,268.47	03-26		DC/RC-35COLE AVE-2
INVOICE: 45947		FULL DESC:	DC/RC-		2 TRIPS CUST 2	00.00			
030352 GREEN MTN. POWER	86427		0	2025 12		876.25	03-26		BLANKET-SRVC LINE 1
INVOICE: 45945 030352 GREEN MTN. POWER		FULL DESC:	BLANKE 0		189JARVIS LN	670.74	03-26		DC/RC-1124UNION-UPG
INVOICE: 45938	86429	FULL DESC:		2025 12 1124UNION-U	PGRADE-CUST100		VJ - 20		DO, NO IIZTONION-UPG
	86430	<del></del>	0	2025 12		591.88	03-26		DC/RC-77TERRACE-MET
INVOICE: 45936		FULL DESC:	DC/RC-	77TERRACE-M	ETER BOX CUST				
						3,407.34			

ACCOUNT TOTAL

METER MAINTENANCE

0

FULL DESC: JUNE METER SRVCS

3,407.34

2025 12 INV A 174.96 03-26 JUNE METER SRVCS

INVOICE: 2020992

INVOICE: 2020293

INVOICE: 2018290

INVOICE: 2017652

054400 SYMOUEST GROUP INC. 86418

054400 SYMOUEST GROUP INC. 86568

054400 SYMQUEST GROUP INC. 86569

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INVOICE LIST BY GL ACCOUNT

YEAR/PERIOD: 2025/1 TO 2026/2 ACCOUNT/VENDOR DOCUMENT VOUCHER PO YEAR/PR TYP S WARRANT CHECK DESCRIPTION ______ ACCOUNT TOTAL 174.96 TELEPHONE 51047 92111 010495 VERIZON WIRELESS 0 2026 2 INV A 23.14 03-26 6/17-7/16 CELL PHON 86581 INVOICE: 6118698477 FULL DESC: 6/17-7/16 CELL PHONE 2026 2 INV A 137.11 03-26 8/4-PHONE 802485541 042768 TDS TELECOM 86571 0 INVOICE: FULL DESC: 8/4-PHONE 8024855411 042768 TDS TELECOM 86572 0 2026 2 INV A 51.71 03-26 8/4-SOLAR BONEHILL8 INVOICE: FULL DESC: 8/4-SOLAR BONEHILL8024854903 86529 0 2026 2 INV A 12.50 03-26 AUG 25 CELL PHONE 052051 RUSSO JAMES INVOICE: FULL DESC: AUG 25 CELL PHONE ACCOUNT TOTAL 224.46 51047 92112 POSTAGE 754.06 03-26 JUL 25 POSTAGE 042896 NFLD TOWN GEN FUND 86511 0 2026 2 INV A INVOICE: FULL DESC: JUL 25 POSTAGE ACCOUNT TOTAL 754.06 51047 92114 OFFICE SUPPLIES 2026 2 INV A 424.60 03-26 UTILITY BILLS 030475 GROSSMAN MARKETING 86463 INVOICE: FULL DESC: UTILITY BILLS 2026 2 INV A 49.35 03-26 6 CASES 8.5X11 COPY 0 035892 MAGEE OFFICE PLUS 86471 FULL DESC: 6 CASES 8.5X11 COPY PAPER TNVOTCE: 2026 2 INV A 21.57 03-26 AUG25 INTERNET MUN 055824 TRANS-VIDEO 86575 0 FULL DESC: AUG25 INTERNET MUN BLD INVOICE: ACCOUNT TOTAL 495.52 MAINTENANCE CONTRACT COMP 51047 92119 57.00 03-26 JUNE DUO MFA CONTRA 2025 12 INV A 054400 SYMQUEST GROUP INC. 86415 0 FULL DESC: JUNE DUO MFA CONTRACT INVOICE: 2020402 JUNE BACKUP CONTRAC 65.50 03-26 054400 SYMQUEST GROUP INC. 86416 0 2025 12 INV A FULL DESC: JUNE BACKUP CONTRACT INVOICE: 2020577 0 2025 12 INV A 85.50 03-26 JUNE MEDR CONTRACT 054400 SYMQUEST GROUP INC. 86417

FULL DESC: JUNE MEDR CONTRACT

FULL DESC: JUNE M3650FFICE CONTRACT

FULL DESC: 7/25-8/24 PRINTER CONTRACT

FULL DESC: 7/20-8/19 COPIER (2) CONTRACT

0 2025 12 INV A

0 2026 2 INV A

0 2026 2 INV A

474 41

166.50 03-26

38.71 03-26

61.20 03-26

JUNE M3650FFICE CON

7/25-8/24 PRINTER C

7/20-8/19 COPIER (2

021684 BUSINESS CREDIT CARD 86432

INVOICE:

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TOWN OF NORTHFIELD

INVOICE LIST BY GL ACCOUNT

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ACCOUNT/VENDOR	DOCUMENT	VOUCHER	PO YEAR/PR TYP S	WARRAN	T CHECK DE	ESCRIPTION
			ACCOUNT TOTAL	474.41		
51047 92310			LEGAL			
048400 PRIMMER PIPER EGGLES INVOICE:	86410	FULL DESC:	0 2025 12 INV A JUNE25-ELEC RATE CASE	93.00 03-26	JU	NE25-ELEC RATE CA
			ACCOUNT TOTAL	93.00		
51047 92312			AUDIT/CPA			
033637 KITTELL BRANAGAN & S	86465			375.00 03-26	PR	OGRESS BILL STAND
INVOICE: 98457		FULL DESC:	PROGRESS BILL STAND. AUDIT FY	24-25		
			ACCOUNT TOTAL	375.00		
51047 92318			VPPSA-NON POWER FEES			
061456 VT PUBLIC POWER SUPP INVOICE:	86424	FULL DESC:	0 2025 12 INV A JUNE POWER BILL	13,485.83 03-26	ວນ	NE POWER BILL
			ACCOUNT TOTAL	13,485.83		
51047 92322			RES REGULATORY COST			
061456 VT PUBLIC POWER SUPP	86587		0 2026 2 INV A	10,350.78 03-26	RE	S AUGUST 25
INVOICE:		FULL DESC:	RES AUGUST 25			
			ACCOUNT TOTAL	10,350.78		
51047 92324			GIS MAPPING			
061456 VT PUBLIC POWER SUPP	86586		0 2026 2 INV A	1,532.90 03-26	GI	S AUGUST 25
INVOICE:		FULL DESC:	GIS AUGUST 25			
			ACCOUNT TOTAL	1,532.90		
51047 92338			HEALTH ADMIN/FEES			
057050 UNITED STATES TREASU	86335		0 2025 12 INV P	7.02 03-26	100470 20	25HRA TX FOR CY20
INVOICE:		FULL DESC:	2025HRA TX FOR CY2024 FORM720			
			ACCOUNT TOTAL	7.02		
51047 93015			ELECTRIC			
041616 NFLD ELEC DEPT			0 2026 2 INV A	73.29 03-26	7/	18-KING STREET SU
INVOICE:		FULL DESC:	7/18-KING STREET SUB		- /	
041616 NFLD ELEC DEPT INVOICE:	86488	FULL DESC:	0 2026 2 INV A 7/18-NU SUBSTATION	24.10 03-26	7/	18-NU SUBSTATION
				97.39		
			ACCOUNT TOTAL	97.39		
51047 93025			SCHOOL/TRAINING			
			201100, 114141410			

0

2025 12 CRM A

FULL DESC: CREDIT-METERING CLASS-LEMIEUX

-550.00 03-26

CREDIT-METERING CLA

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FUND 510 ELECTRIC FUND

INVOICE LIST BY GL ACCOUNT

YEAR/PERIOD: 2025/1 TO 2026/2 ACCOUNT/VENDOR DOCUMENT VOUCHER PO YEAR/PR TYP S WARRANT CHECK DESCRIPTION _____ 021684 BUSINESS CREDIT CARD 86433 2025 12 CRM A -550.00 03-26 CREDIT-METERING CLA INVOICE: FULL DESC: CREDIT-METERING CLASS-JENSEN -1.100.00 ACCOUNT TOTAL -1,100.00 51047 93311 GASOLINE 113.64 03-26 JUNE 25 GAS/DIESEL 042896 NFLD TOWN GEN FUND 86399 0 2025 12 INV A INVOICE: FULL DESC: JUNE 25 GAS/DIESEL 174.05 03-26 MAY 25 GAS/DIESEL 042896 NFLD TOWN GEN FUND 86400 0 2025 12 INV A FULL DESC: MAY 25 GAS/DIESEL 73.48 03-26 042896 NFLD TOWN GEN FUND 86401 0 2025 12 INV A APRIL25 GAS/DIESEL INVOICE: FULL DESC: APRIL25 GAS/DIESEL 361.17 10.317 GALS GAS 7/9 053596 SO. VILLAGE 86545 0 2026 2 INV A FULL DESC: 10.317 GALS GAS 7/9-CHEVY TRAILBLAZER INVOICE: 7844 0 2026 2 INV A 17.30 03-26 10.816 GALS GAS 7/1 053596 SO. VILLAGE 86547 FULL DESC: 10.816 GALS GAS 7/14 TRAILBLAZER INVOICE: 604 0 2026 2 INV A 25.856 GALS GAS 18C 41.35 03-26 053596 SO. VILLAGE 86549 FULL DESC: 25.856 GALS GAS 18CHEVY 7/14 INVOICE: 804 0 2026 2 INV A 11.278 GALS GAS 7/2 053596 SO. VILLAGE 86552 22.55 03-26 INVOICE: 5793 FULL DESC: 11.278 GALS GAS 7/22 TRAILBLAZER 053596 SO. VILLAGE 86555 0 2026 2 INV A 49.64 03-26 32.032 GALS GAS 18C INVOICE: 7392 FULL DESC: 32.032 GALS GAS 18CHEVY 7/24 ACCOUNT TOTAL 508.51 ORG 51047 TOTAL 250,459,41 

TOTAL:

269,379.97

054400 SYMQUEST GROUP INC. 86418

054400 SYMQUEST GROUP INC. 86568

054400 SYMOUEST GROUP INC. 86569

INVOICE: 2020293

INVOICE: 2018290

INVOICE: 2017652

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INVOICE LIST BY GL ACCOUNT

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JUNE M3650FFICE CON

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7/20-8/19 COPIER (2

YEAR/PERIOD: 2025/1 TO 2026/2 ACCOUNT/VENDOR DOCUMENT VOUCHER PO YEAR/PR TYP S WARRANT CHECK DESCRIPTION ------53000 WATER - BALANCE SHEET 01331 53000 048144 PRESCOTT, E. J. 86526 0 2026 2 INV A 1,348.88 03-26 2 METERS-NU DORMS INVOICE: 6508161 FULL DESC: 2 METERS-NU DORMS ACCOUNT TOTAL 1,348.88 53000 02051 COBRA INSURANCE 2025 12 INV P 057050 UNITED STATES TREASU 86335 0 1.56 03-26 100470 2025HRA TX FOR CY20 INVOICE: FULL DESC: 2025HRA TX FOR CY2024 FORM720 ACCOUNT TOTAL 1.56 ORG 53000 TOTAL 1,350.44 53045 WATER DEPARTMENT 53045 06010 PROFESSIONAL SERVICES 014078 BEATTY, ROSE E. 86369 2025 12 INV A 0 360.00 03-26 TREE TAPPING INSPEC INVOICE: 2456 FULL DESC: TREE TAPPING INSPECTION ACCOUNT TOTAL 360.00 53045 06100 AUDITS 033637 KITTELL BRANAGAN & S 86465 0 2026 2 INV A 217.50 03-26 PROGRESS BILL STAND FULL DESC: PROGRESS BILL STAND. AUDIT FY24-25 INVOICE: 98457 ACCOUNT TOTAL 217.50 53045 06220 MAINTENANCE CONTRACTS 054400 SYMQUEST GROUP INC. 86415 0 2025 12 INV A 33.06 03-26 JUNE DUO MFA CONTRA INVOICE: 2020402 FULL DESC: JUNE DUO MFA CONTRACT 054400 SYMQUEST GROUP INC. 86416 n 2025 12 INV A 37.99 03-26 JUNE BACKUP CONTRAC INVOICE: 2020577 FULL DESC: JUNE BACKUP CONTRACT 054400 SYMQUEST GROUP INC. 86417 0 2025 12 INV A 49.59 03-26 JUNE MEDR CONTRACT INVOICE: 2020992 FULL DESC: JUNE MEDR CONTRACT

275.66

96.57 03-26

22.45 03-26

36.00 03-26

ACCOUNT TOTAL 275.66

HEALTH ADMIN/FEES 53045 06380 2025 12 INV P 057050 UNITED STATES TREASU 86335 0 5.92 03-26 100470 2025HRA TX FOR CY20 INVOICE: FULL DESC: 2025HRA TX FOR CY2024 FORM720

0 2025 12 INV A

0 2026 2 INV A

0 2026 2 INV A

FULL DESC: JUNE M3650FFICE CONTRACT

FULL DESC: 7/25-8/24 PRINTER CONTRACT

FULL DESC: 7/20-8/19 COPIER (2) CONTRACT

ACCOUNT TOTAL 5.92 08/07/2025 11:17 | TOWN OF NORTHFIELD | P 29
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YEAR/PERIOD: 2025/1 TO 2026/2

YEAR/PERIOD: 2025/1 TO								
ACCOUNT/VENDOR	DOCUMEN	T VOUCHE	R PO YEAR/I	PR TYP S		WARRANT	CHECK	DESCRIPTION
53045 06510			TESTING					
026230 ENDYNE, INC	86460		0 2026	2 INV A	25.00	03-26		7/16-COLIFORM TEST
INVOICE: 540116		FULL DESC:	7/16-COLIFORM T	EST				
			ACCOUNT	TOTAL	25.00			
53045 07010			TELEPHONE					
010495 VERIZON WIRELESS	86581			2 INV A	34.19	03-26		6/17-7/16 CELL PHON
INVOICE: 6118698477		FULL DESC:	6/17-7/16 CELL	PHONE				
042768 TDS TELECOM	86571			2 INV A	150.48	03-26		8/4-PHONE 802485541
INVOICE:		FULL DESC:	8/4-PHONE 80248	55411				
052051 RUSSO JAMES	86529		0 2026	2 INV A	22 50	03-26		AUG 25 CELL PHONE
INVOICE:	86529	FULL DESC:	AUG 25 CELL PHO		22.50	03-20		AUG 25 CEEE FROME
invoici.		TOLL DIDE.						
<u> </u>			ACCOUNT	TOTAL	207.17			
53045 07020			POSTAGE					
042896 NFLD TOWN GEN FUND	86511			2 INV A	347.18	03-26		JUL 25 POSTAGE
INVOICE:		FULL DESC:	JUL 25 POSTAGE					
			ACCOUNT	TOTAL.	347.18			
			110000111	1011-				
53045 07050			OFFICE SUP	PLIES				
030475 GROSSMAN MARKETING	86463		0 2026	2 INV A	246.27	03-26		UTILITY BILLS
INVOICE:		FULL DESC:	UTILITY BILLS					
035892 MAGEE OFFICE PLUS	86471	DITT DEGG.	0 2026 6 CASES 8.5X11	2 INV A	28.36	03-26		6 CASES 8.5X11 COPY
INVOICE:		FULL DESC:	6 CASES 8.5XII	COPI PAPER				
055824 TRANS-VIDEO	86575		0 2026	2 INV A	8.66	03-26		AUG25 INTERNET MUN
INVOICE:		FULL DESC:	AUG25 INTERNET	MUN BLD				
055824 TRANS-VIDEO	86578		0 2026	2 INV A	26.97	03-26		AUG25-INTERNET-W/S
INVOICE:		FULL DESC:	AUG25-INTERNET-	w/s				
					35.63			
			ACCOUNT	TOTAL	310.26			
			ACCOONT	TOTAL	510.20			
53045 07060			OFFICE EQU	IPMENT/MAINT	ENANCE			
021684 BUSINESS CREDIT CARD	86455		0 2026	2 INV A	194.39	03-26		CANON COLOR PRINTER
INVOICE:		FULL DESC:	CANON COLOR PRI	NTER-W/S				
			ACCOUNT	TOTAL	194.39			
			PILOT PAYM	ביאוייי				
53045 07282 042896 NFLD TOWN GEN FUND	86510			2 INV A	1,560.00	03-26		AUG 25 PILOT
1NVOICE:	20210	FULL DESC:	AUG 25 PILOT		2,200.00			
11110101								
			ACCOUNT	TOTAL	1,560.00			

INVOICE: 532352

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YEAR/PERIOD: 2025/1 TO 2 ACCOUNT/VENDOR	DOCUMENT		PO YEAR/PR TYP S		WARRANT CHECK	DESCRIPTION
53045 08010			ELECTRICITY			
041616 NFLD ELEC DEPT	86489		0 2026 2 INV A	16.09	03-26	7/18-WATER PUMP VAU
INVOICE:		FULL DESC:	7/18-WATER PUMP VAULT(GARVEY)			
041616 NFLD ELEC DEPT	86490		0 2026 2 INV A	18.81	03-26	7/18-CHENEY FARM VA
INVOICE:		FULL DESC:	7/18-CHENEY FARM VAULT			
				34.90		
			ACCOUNT TOTAL	34.90		
53045 08013			ELECTRIC-SOLAR			
052905 SENIOR RENEWABLES, I	86539		0 2026 2 INV A	3,170.56	03-26	BULLRUN SOLAR-JULY
INVOICE: 190		FULL DESC:	BULLRUN SOLAR-JULY			
			ACCOUNT TOTAL	3,170.56		
53045 08070			GASOLINE/DIESEL			
042896 NFLD TOWN GEN FUND	86399		0 2025 12 INV A	117.96	03-26	JUNE 25 GAS/DIESEL
INVOICE:		FULL DESC:	JUNE 25 GAS/DIESEL			
042896 NFLD TOWN GEN FUND	86400		0 2025 12 INV A	201.37	03-26	MAY 25 GAS/DIESEL
INVOICE:		FULL DESC:	MAY 25 GAS/DIESEL			
042896 NFLD TOWN GEN FUND	86401		0 2025 12 INV A	141.76	03-26	APRIL25 GAS/DIESEL
INVOICE:		FULL DESC:	APRIL25 GAS/DIESEL			
				461.09		
053596 SO. VILLAGE	86545		0 2026 2 INV A	9.57	03-26	10.317 GALS GAS 7/9
INVOICE: 7844		FULL DESC:	10.317 GALS GAS 7/9-CHEVY TRAIL	BLAZER		
053596 SO. VILLAGE	86547		0 2026 2 INV A	10.03	03-26	10.816 GALS GAS 7/1
INVOICE: 604		FULL DESC:	10.816 GALS GAS 7/14 TRAILBLAZE			
053596 SO. VILLAGE	86549		0 2026 2 INV A	41.36	03-26	25.856 GALS GAS 18C
INVOICE: 804	0.6550	FULL DESC:	25.856 GALS GAS 18CHEVY 7/14	12.00	02.06	11 050 0315 030 5/0
053596 SO. VILLAGE INVOICE: 5793	86552	pill becc.	0 2026 2 INV A 11.278 GALS GAS 7/22 TRAILBLAZE	13.08	03-26	11.278 GALS GAS 7/2
053596 SO. VILLAGE	86555	FULL DESC.	0 2026 2 INV A		03-26	32.032 GALS GAS 18C
INVOICE: 7392	00333	FULL DESC:	32.032 GALS GAS 18CHEVY 7/24	49.03	03-20	32.032 GALB GAB 10C
				123.67		
			ACCOUNT TOTAL	584.76		
53045 08100			CHEMICALS			
011024 ALLEN ENGIN	86442		0 2026 2 INV A	417.50	03-26	100GALS LIQ CHLORIN
INVOICE:		FULL DESC:	100GALS LIQ CHLORINE-7/15			
			ACCOUNT TOTAL	417.50		
53045 08250			EQUIPMENT MAINTENANCE			
052611 SANEL NAPA	86531		0 2026 2 INV A	2.94	03-26	ADAPTER-HYDRANT FLU
TATIOT CO. FRONCO		BUILT DECC	ADADMED HWDDANN BILICHED			

FULL DESC: ADAPTER-HYDRANT FLUSHER

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FUND 530 WATER FUND

INVOICE LIST BY GL ACCOUNT

YEAR/PERIOD: 2025/1 TO 2026/2 YEAR/PR TYP S WARRANT CHECK DESCRIPTION ACCOUNT/VENDOR DOCUMENT VOUCHER PO 2.94 ACCOUNT TOTAL 53045 08300 DEPARTMENT SUPPLIES PROPANE TANK-HANDHE 4.19 03-26 010128 ACE HARDWARE 2025 12 INV A 86338 FULL DESC: PROPANE TANK-HANDHELD TORCH W/S INVOICE: DRILL BIT-W/S 0 2025 12 INV A 31.19 03-26 010128 ACE HARDWARE 86344 FULL DESC: DRILL BIT-W/S INVOICE: 010128 ACE HARDWARE ALUM SHOVEL-WATER-H 86356 0 2025 12 INV A 36.99 03-26 FULL DESC: ALUM SHOVEL-WATER-HYDRANTS INVOICE: _____ 72.37 048144 PRESCOTT, E. J. 2026 2 INV A 339.56 03-26 COUPLINGS/TUBE STIF 86525 0 INVOICE: 6512819 FULL DESC: COUPLINGS/TUBE STIFFENER-WTR STOCK CONNECTORS-W/ 86533 0 2026 2 INV A 17.40 03-26 052611 SANEL NAPA FULL DESC: STOCK CONNECTORS-W/S INVOICE: 532461 COTT PIN, CARB CHOK 0 2026 2 INV A 4.31 03-26 052611 SANEL NAPA 86536 INVOICE: 532624 FULL DESC: COTT PIN, CARB CHOKE CLEANER _____ 21.71 ACCOUNT TOTAL 433.64 EQUIPMENT/TOOL PURCHASE 53045 08460 2025 12 INV A 22.31 03-26 4 1/8 HOLE SAW-W/S 010128 ACE HARDWARE 86337 FULL DESC: 4 1/8 HOLE SAW-W/S TOOLS INVOICE: 22.31 ACCOUNT TOTAL 8,169.69 ORG 53045 TOTAL

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TOTAL:

9,520.13

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INVOICE LIST BY GL ACCOUNT

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ACCOUNT/VENDOR	DOCUMENT	VOUCHER	PO YEAR/PR TYP S	WARRAI	NT CHECK DESCRIPTION
55000 55000 01331 048144 PRESCOTT, E. J. INVOICE: 6508161			BALANCE SHEET  METERS  0 2026 2 INV A 2 METERS-NU DORMS	899.26 03-26	2 METERS-NU DORMS
INVOICE. USUUISI		FOUL DESC:	ACCOUNT TOTAL	899.26	
55000 01562			EQUIP REBUILDS-PLANT		
012380 AQUA-AEROBIC SYSTEMS INVOICE: 1048095		FULL DESC:	0 2025 12 INV A SBR MOTOR-PARTS/KIT	12,343.93 03-26	SBR MOTOR-PARTS/KI
033830 LCS CONTROLS, INC. INVOICE: 14835		FULL DESC:	0 2026 2 INV A REPLACE MOTOR STARTER-SBR	1,397.00 03-26 MIXER	REPLACE MOTOR STAF
036890 MAYO CRANE RENTAL INVOICE: 1768		FULL DESC:	0 2026 2 INV A CRANE RENTAL-4HRS-SBR MOTO	740.00 03-26 R-7/10	CRANE RENTAL-4HRS-
			ACCOUNT TOTAL	14,480.93	
55000 02051 057050 UNITED STATES TREASU INVOICE:		FULL DESC:	COBRA INSURANCE  0 2025 12 INV P  2025HRA TX FOR CY2024 FORM		100470 2025HRA TX FOR CY2
			ACCOUNT TOTAL	1.04	
			ORG 55000 TOTAL	15,381.23	
55046		SEWER DE	PARTMENT		
55046 06100			AUDITS		
033637 KITTELL BRANAGAN & S INVOICE: 98457		FINI. DESC.	0 2026 2 INV A PROGRESS BILL STAND. AUDIT	157.50 03-26	PROGRESS BILL STAN
J0107		2000.	ACCOUNT TOTAL		
			ACCOUNT TOTAL	157.50	
55046 06220			MAINTENANCE CONTRACTS		
054400 SYMQUEST GROUP INC.			MAINTENANCE CONTRACTS 0 2025 12 INV A		JUNE DUO MFA CONTR
054400 SYMQUEST GROUP INC. INVOICE: 2020402		FULL DESC:	MAINTENANCE CONTRACTS 0 2025 12 INV A JUNE DUO MFA CONTRACT	23.94 03-26	
054400 SYMQUEST GROUP INC. INVOICE: 2020402 054400 SYMQUEST GROUP INC.	86416		MAINTENANCE CONTRACTS  0 2025 12 INV A  JUNE DUO MFA CONTRACT  0 2025 12 INV A		
054400 SYMQUEST GROUP INC. INVOICE: 2020402 054400 SYMQUEST GROUP INC. INVOICE: 2020577	86416		MAINTENANCE CONTRACTS  0 2025 12 INV A  JUNE DUO MFA CONTRACT  0 2025 12 INV A  JUNE BACKUP CONTRACT	23.94 03-26 27.51 03-26	JUNE BACKUP CONTRA
054400 SYMQUEST GROUP INC. INVOICE: 2020402 054400 SYMQUEST GROUP INC.	86416	FULL DESC:	MAINTENANCE CONTRACTS  0 2025 12 INV A  JUNE DUO MFA CONTRACT  0 2025 12 INV A  JUNE BACKUP CONTRACT	23.94 03-26 27.51 03-26	JUNE BACKUP CONTRA
054400 SYMQUEST GROUP INC. INVOICE: 2020402 054400 SYMQUEST GROUP INC. INVOICE: 2020577 054400 SYMQUEST GROUP INC.	86416 86417	FULL DESC:	MAINTENANCE CONTRACTS  0 2025 12 INV A  JUNE DUO MFA CONTRACT  0 2025 12 INV A  JUNE BACKUP CONTRACT  0 2025 12 INV A  JUNE MEDR CONTRACT	23.94 03-26 27.51 03-26 35.91 03-26	JUNE BACKUP CONTRACT
054400 SYMQUEST GROUP INC. INVOICE: 2020402 054400 SYMQUEST GROUP INC. INVOICE: 2020577 054400 SYMQUEST GROUP INC. INVOICE: 2020992	86416 86417 86418	FULL DESC:	MAINTENANCE CONTRACTS  0 2025 12 INV A  JUNE DUO MFA CONTRACT  0 2025 12 INV A  JUNE BACKUP CONTRACT  0 2025 12 INV A  JUNE MEDR CONTRACT	23.94 03-26 27.51 03-26 35.91 03-26	JUNE BACKUP CONTRACT
054400 SYMQUEST GROUP INC. INVOICE: 2020402 054400 SYMQUEST GROUP INC. INVOICE: 2020577 054400 SYMQUEST GROUP INC. INVOICE: 2020992 054400 SYMQUEST GROUP INC.	86416 86417 86418	FULL DESC:	MAINTENANCE CONTRACTS  0 2025 12 INV A  JUNE DUO MFA CONTRACT  0 2025 12 INV A  JUNE BACKUP CONTRACT  0 2025 12 INV A  JUNE MEDR CONTRACT  0 2025 12 INV A	23.94 03-26 27.51 03-26 35.91 03-26	JUNE BACKUP CONTRACT  JUNE M3650FFICE CC
054400 SYMQUEST GROUP INC. INVOICE: 2020402 054400 SYMQUEST GROUP INC. INVOICE: 2020577 054400 SYMQUEST GROUP INC. INVOICE: 2020992 054400 SYMQUEST GROUP INC. INVOICE: 2020293	86416 86417 86418 86568	FULL DESC: FULL DESC:	MAINTENANCE CONTRACTS  0 2025 12 INV A  JUNE DUO MFA CONTRACT  0 2025 12 INV A  JUNE BACKUP CONTRACT  0 2025 12 INV A  JUNE MEDR CONTRACT  0 2025 12 INV A  JUNE M3650FFICE CONTRACT	23.94 03-26 27.51 03-26 35.91 03-26 69.93 03-26 16.25 03-26	JUNE BACKUP CONTRACT  JUNE M3650FFICE CO
054400 SYMQUEST GROUP INC. INVOICE: 2020402 054400 SYMQUEST GROUP INC. INVOICE: 2020577 054400 SYMQUEST GROUP INC. INVOICE: 2020992 054400 SYMQUEST GROUP INC. INVOICE: 2020293 054400 SYMQUEST GROUP INC.	86416 86417 86418 86568	FULL DESC: FULL DESC: FULL DESC:	MAINTENANCE CONTRACTS  0 2025 12 INV A  JUNE DUO MFA CONTRACT  0 2025 12 INV A  JUNE BACKUP CONTRACT  0 2025 12 INV A  JUNE MEDR CONTRACT  0 2025 12 INV A  JUNE M3650FFICE CONTRACT  0 2026 2 INV A	23.94 03-26 27.51 03-26 35.91 03-26 69.93 03-26 16.25 03-26 25.20 03-26	JUNE BACKUP CONTRACT  JUNE M3650FFICE CO  7/25-8/24 PRINTER

198.74

ACCOUNT TOTAL 198.74

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INVOICE LIST BY GL ACCOUNT apinvgla

YEAR/PERIOD: 2025/1 TO 2 ACCOUNT/VENDOR	DOCUMENT	VOUCHER		WARRANT	CHECK DESCRIPTION
55046 06380 057050 UNITED STATES TREASU INVOICE:	86335	FULL DESC:	HEALTH ADMIN/FEES  0 2025 12 INV P  2025HRA TX FOR CY2024 FORM720	3.96 03-26	100470 2025HRA TX FOR CY20
			ACCOUNT TOTAL	3.96	
55046 06500 026264 ENGLOBE CORP INVOICE:	86371	FULL DESC:	SLUDGE MANAGEMENT 0 2025 12 INV A 66.87 TONS-WW BIOSOLID-JUNE	11,035.56 03-26	66.87 TONS-WW BIOSO
			ACCOUNT TOTAL	11,035.56	
55046 06510 026230 ENDYNE, INC INVOICE: 539872	86459	FULL DESC:	TESTING-SAMPLING 0 2026 2 INV A 7/2-WW	215.00 03-26	7/2-WW
			ACCOUNT TOTAL	215.00	
55046 07010 010495 VERIZON WIRELESS INVOICE: 6118698477	86581	FULL DESC:	TELEPHONE  0 2026 2 INV A 6/17-7/16 CELL PHONE	23.10 03-26	6/17-7/16 CELL PHON
042768 TDS TELECOM INVOICE:	86571	FULL DESC:	0 2026 2 INV A 8/4-PHONE 8024855411	58.62 03-26	8/4-PHONE 802485541
052051 RUSSO JAMES INVOICE:	86529	FULL DESC:	0 2026 2 INV A AUG 25 CELL PHONE	15.00 03-26	AUG 25 CELL PHONE
			ACCOUNT TOTAL	96.72	
55046 07020 042896 NFLD TOWN GEN FUND INVOICE:	86511	FULL DESC:	POSTAGE 0 2026 2 INV A JUL 25 POSTAGE	368.06 03-26	JUL 25 POSTAGE
			ACCOUNT TOTAL	368.06	
55046 07050 030475 GROSSMAN MARKETING INVOICE:	86463	FULL DESC:	OFFICE SUPPLIES 0 2026 2 INV A UTILITY BILLS	178.33 03-26	UTILITY BILLS
035892 MAGEE OFFICE PLUS INVOICE:	86471	FULL DESC:	0 2026 2 INV A 6 CASES 8.5X11 COPY PAPER	20.46 03-26	6 CASES 8.5X11 COPY
055824 TRANS-VIDEO	86575		0 2026 2 INV A	5.78 03-26	AUG25 INTERNET MUN
: INVOICE: 055824 TRANS-VIDEO INVOICE:	86578		AUG25 INTERNET MUN BLD  0 2026 2 INV A  AUG25-INTERNET-W/S	17.98 03-26	AUG25-INTERNET-W/S
				23.76	
			ACCOUNT TOTAL	222.55	

INVOICE LIST BY GL ACCOUNT

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YEAR/PERIOD: 2025/1 TO 2026/2

ACCOUNT/VENDOR	DOCUMENT	VOUCHER	PO YEAR/PR	TYP S		WARRANT	CHECK	DESCRIPTION
55046 07060				MENT/MAINTENANCE				
021684 BUSINESS CREDIT CARD			0 2026 2		129.60	03-26		CANON COLOR PRINTER
INVOICE:	FU	LL DESC:	CANON COLOR PRINT	ER-W/S				
			ACCOUNT T	OTAL	129.60			
55046 07070			DUES/MEETING	s/subscriptions				
021684 BUSINESS CREDIT CARD	86452		0 2026 2	INV A	275.00	03-26		SWR LICENSE RENEW-J
INVOICE:	FU	LL DESC:	SWR LICENSE RENEW	-JR				
021684 BUSINESS CREDIT CARD	86453		0 2026 2	INV A	275.00	03-26		SWR LICENSE RENEW-J
INVOICE:		LL DESC:	SWR LICENSE RENEW	-JENSEN				
021684 BUSINESS CREDIT CARD			0 2026 2		275.00	03-26		SWR LICENSE RENEW-P
INVOICE:	FU	LL DESC:	SWR LICENSE RENEW	-PDEMASI				
					825.00			
					023,00			
			ACCOUNT T	OTAL	825.00			
55046 07282			PILOT PAYMEN	r				
042896 NFLD TOWN GEN FUND	86510		0 2026 2	INV A	3,936.00	03-26		AUG 25 PILOT
INVOICE:	FU	LL DESC:	AUG 25 PILOT					
			ACCOUNT TO	OTAL	3,936.00			
55046 07350			LEASE AGREEM	ENTS				
018320 CV PROPERTIES	86458		0 2026 2		100.00	03-26		8/2025-7/2026 PIPE
INVOICE: 9500275404	FU	LL DESC:	8/2025-7/2026 PIP	E XING 887473				
			ACCOUNT TO	OTAL	100.00			
55046 08010			ELECTRICITY					
041616 NFLD ELEC DEPT	86491		0 2026 2	INV A	27.25	03-26		7/18-JARVIS LANE
INVOICE:	FU	LL DESC:	7/18-JARVIS LANE					
			ACCOUNT TO	ז מושכ	27.25			
			ACCOON! IC	JIAL	27.25			
55046 08013			ELECTRIC-SOLA	AR.				
052905 SENIOR RENEWABLES, L	86539		0 2026 2	INV A	5,665.85	03-26		BULLRUN SOLAR-JULY
INVOICE: 190	FUI	LL DESC:	BULLRUN SOLAR-JUL!	T.				
			ACCOUNT TO	ንሞል ፣	5,665.85			
			ACCOONT	, IAL	3,003.03			
55046 08030			WATER					
043552 NORTHFIELD	86512		0 2026 2	INV A	1,981.83	03-26		7/18-SEWER PLANT
INVOICE:	FUI	LL DESC:	7/18-SEWER PLANT					
			· ACCOUNT TO	ייים.	1,981.83			
			ACCOUNT IC	ريميا	1,501.03			
55046 08070			GASOLINE/DIES	SEL				
042896 NFLD TOWN GEN FUND	86399		0 2025 12	INV A	296.62	03-26		JUNE 25 GAS/DIESEL
INVOICE:	FUI	LL DESC:	JUNE 25 GAS/DIESEI	ı				

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INVOICE LIST BY GL ACCOUNT

YEAR/PERIOD: 2025/1 TO 2 ACCOUNT/VENDOR	DOCUMENT	VOUCHER	PO YEAR/PR	TYP S	WARRANT CHECK	DESCRIPTION
042896 NFLD TOWN GEN FUND	86400	FULL DESC:	0 2025 12 MAY 25 GAS/DIESEL		03-26	MAY 25 GAS/DIESEL
042896 NFLD TOWN GEN FUND	86401			INV A 276.74	03-26	APRIL25 GAS/DIESEL
INVOICE:		FULL DESC:	APRIL25 GAS/DIESE	L		
				815.51		
053596 SO. VILLAGE	86545		0 2026 2	TNT/ A 6 93	03-26	10.317 GALS GAS 7/9
INVOICE: 7844	00343	FILL DESC:		/9-CHEVY TRAILBLAZER	03 20	10,017 011110 0110 1,72
053596 SO. VILLAGE	86547	TOBB DEDC.	0 2026 2		03-26	10.816 GALS GAS 7/1
INVOICE: 604		FULL DESC:	10.816 GALS GAS 7			
053596 SO. VILLAGE	86552		0 2026 2		03-26	11.278 GALS GAS 7/2
INVOICE: 5793		FULL DESC:	11.278 GALS GAS 7	/22 TRAILBLAZER		
053596 SO. VILLAGE	86561		0 2026 2	INV A 152.97	03-26	47.818 GALS GAS 7/3
INVOICE: 1736		FULL DESC:	47.818 GALS GAS 7	/31-24CHEVY		
				176.64		
			ACCOUNT TO	OTAL 992.15		
55046 08180			LINE MAINTEN	ANCE		
010128 ACE HARDWARE	86345		0 2025 12		03-26	1PVC EXP-CHEMICAL L
INVOICE:		FULL DESC:	1PVC EXP-CHEMICAL	LINES-CHLORINE ANALYZER		
010128 ACE HARDWARE	86346		0 2025 12	INV A 7.96	03-26	3/4 90 PVC-CHEMICAL
INVOICE:		FULL DESC:	3/4 90 PVC-CHEMICA	AL LINES-CHLORINE ANALYZE	R	
010128 ACE HARDWARE	86347		0 2025 12	INV A 5.56	03-26	3/4 COUPLING-CHLORI
INVOICE:		FULL DESC:	3/4 COUPLING-CHLO	RINE ANALYZER		
010128 ACE HARDWARE	86348		0 2025 12	INV A 4.99	03-26	LB EXPANSION COUPLI
INVOICE:		FULL DESC:	LB EXPANSION COUP	LING-CHLORINE ANALYZER		
010128 ACE HARDWARE	86349		0 2025 12	INV A 1.99	03-26	3/4 90 PVC EXPANSIO
INVOICE:		FULL DESC:	3/4 90 PVC EXPANS	ION-CHLORINE ANALYZER		
010128 ACE HARDWARE	86350		0 2025 12	INV A 29.98	03-26	3/4 PVC CONDUIT-CHL
INVOICE:		FULL DESC:	3/4 PVC CONDUIT-C	HLORINE ANALYZER		
010128 ACE HARDWARE	86351		0 2025 12	INV A 15.98	03-26	3/4 LB EXPANSION CO
INVOICE:		FULL DESC:	3/4 LB EXPANSION (	COUPLING-CHLORINE ANALYZE		
010128 ACE HARDWARE	86352		0 2025 12	2	03-26	3/4 90 PVC-CHLORINE
INVOICE:		FULL DESC:	3/4 90 PVC-CHLORII			
010128 ACE HARDWARE	86353		0 2025 12		03-26	3/4 COUPLING-CHLORI
INVOICE:		FULL DESC:	3/4 COUPLING-CHLO			0 / 4 mm / 0 Description City
010128 ACE HARDWARE	86354		0 2025 12		03-26	3/4X1/8 BUSHING-CHL
INVOICE:		FULL DESC:	3/4X1/8 BUSHING-CE		00.06	DUG MARID GUI OFTNE
010128 ACE HARDWARE	86355		0 2025 12		03-26	PVC WATER-CHLORINE
INVOICE:		FULL DESC:	PVC WATER-CHLORINI	E ANALYZER		
				112.57		
			ACCOUNT TO	OTAL 112.57		
			EQUIPMENT MAI	TNTENANCE		
55046 08250	86534		0 2026 2		03-26	CONNECTOR-SLUDGE PU
052611 SANEL NAPA	00334	FILL DESC.	CONNECTOR-SLUDGE 1			
INVOICE: 532466		TODE DESC:	COMMENTAL DEPOSE			

08/07/2025 11:17 | TOWN OF NORTHFIELD

FUND 550 SEWER FUND

INVOICE LIST BY GL ACCOUNT

P 36 apinvgla

YEAR/PERIOD: 2025/1 TO 2026/2 ACCOUNT/VENDOR DOCUMENT VOUCHER PO YEAR/PR TYP S WARRANT CHECK DESCRIPTION ACCOUNT TOTAL 4.41 55046 08300 DEPARTMENT SUPPLIES 2.80 03-26 010128 ACE HARDWARE 86338 2025 12 INV A PROPANE TANK-HANDHE FULL DESC: PROPANE TANK-HANDHELD TORCH W/S INVOICE: 010128 ACE HARDWARE 86344 0 2025 12 INV A 20.80 03-26 DRILL BIT-W/S INVOICE: FULL DESC: DRILL BIT-W/S 23.60 021684 BUSINESS CREDIT CARD 86456 0 2026 2 INV A 21.98 03-26 WEDGE ANCHORS/SCREW INVOICE: FULL DESC: WEDGE ANCHORS/SCREWS KIT-SWR 86533 2026 2 INV A 052611 SANEL NAPA 0 11.60 03-26 STOCK CONNECTORS-W/ INVOICE: 532461 FULL DESC: STOCK CONNECTORS-W/S 052611 SANEL NAPA 86536 0 2026 2 INV A 2.87 03-26 COTT PIN, CARB CHOK INVOICE: 532624 FULL DESC: COTT PIN, CARB CHOKE CLEANER ACCOUNT TOTAL 60.05 55046 08460 EQUIPMENT/TOOL PURCHASE 010128 ACE HARDWARE 86337 2025 12 INV A 0 14.88 03-26 4 1/8 HOLE SAW-W/S INVOICE: FULL DESC: 4 1/8 HOLE SAW-W/S TOOLS ACCOUNT TOTAL 14.88

ORG 55046 TOTAL

TOTAL:

26,147.68

41.528.91

^{**} END OF REPORT - Generated by Tanya Law **

tlaw

INVOICE LIST BY GL ACCOUNT

|P 1 apinvgla

YEAR/PERIOD: 2026/1 TACCOUNT/VENDOR		er po year/pr typ s	WARRANT	CHECK DESCRIPTION
10140 10140 05152 039617 MVP-HRA INVOICE:	86314	LERK/TREASURER  HRA  0 2026 1 DIR P  JULY 8,2025 HRA CLAIMS CK	260.96 03-26A	3369 JULY 8,2025 HRA CLA
		ACCOUNT TOTAL	260.96	
		ORG 10140 TOTAL	260.96	
10420	HIGHWA	C DEPT		
10420 05152		HRA		
039617 MVP-HRA	86314		102.72 03-26A	3369 JULY 8,2025 HRA CLA
INVOICE:	FULL DESC	JULY 8,2025 HRA CLAIMS CK		
		ACCOUNT TOTAL	102.72	
		ORG 10420 TOTAL	102.72	
				=======================================
FUND 010	TOWN GENERAL FUND	TOTAL:	363.68	
=======================================		.======================================		

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INVOICE LIST BY GL ACCOUNT tlaw

P 1 |apinvgla

YEAR/PERIOD: 202	6/1 TO 2026/2		
ACCOUNT/VENDOR	DOCUMENT VOUCHER	PO YEAR/PR TYP S	WARRANT CHECK DESCRIPTION
10140	TOWN CLE	RK/TREASURER	
10140 05152		HRA	
039617 MVP-HRA	86315	0 2026 1 DIR P	23.14 03-26B 3370 JULY 15,2025 HRA CL
INVOICE:	FULL DESC:	JULY 15,2025 HRA CLAIMS CARD	
		ACCOUNT TOTAL	23.14
		ORG 10140 TOTAL	23.14
10420	HIGHWAY	DEPT	
10420 05152		HRA	
039617 MVP-HRA	86315	0 2026 1 DIR P	15.00 03-26B 3370 JULY 15,2025 HRA CL
INVOICE:	FULL DESC:	JULY 15,2025 HRA CLAIMS CARD	
		ACCOUNT TOTAL	15.00
		ORG 10420 TOTAL	15.00
**************			
FUND	010 TOWN GENERAL FUND	TOTAL:	38.14
=======================================			

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| P 1 apinvgla

08/07/2025 11:18 | TOWN OF NORTHFIELD

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INVOICE LIST BY GL ACCOUNT

YEAR/PERIOD: 2026/1 ACCOUNT/VENDOR		ER PO YEAR/PR TYP S	WARRANT	CHECK DESCRIPTION
10140 10140 05152	TOWN C	LERK/TREASURER HRA		
039617 MVP-HRA INVOICE:	86316 FULL DESC	0 2026 1 DIR P : JULY 15, 2025 HRA CLAIMS CK	269.73 03-26C	3371 JULY 15, 2025 HRA C
		ACCOUNT TOTAL	269.73	
		ORG 10140 TOTAL	269.73	
10230	ACCOUN	ring		
10230 05152		HRA		
039617 MVP-HRA	86316	0 2026 1 DIR P	273.11 03-26C	3371 JULY 15, 2025 HRA C
INVOICE:	FULL DESC	: JULY 15, 2025 HRA CLAIMS CK		
		ACCOUNT TOTAL	273.11	
		ORG 10230 TOTAL	273.11	
	======================================			
FUND 010	TOWN GENERAL FUND	TOTAL:	542.84	

tlaw

INVOICE LIST BY GL ACCOUNT

|P 2 apinvgla

YEAR/PERIOD: 2026/1 TO 2026/2

ACCOUNT/VENDOR DOCUMENT VOUCHER PO YEAR/PR TYP S WARRANT CHECK DESCRIPTION

51047 ELECTRIC DEPARTMENT

51047 05152

039617 MVP-HRA

86316

0 2026 1 DIR P 149.34 03-26C 3371 JULY 15, 2025 HRA C

INVOICE: FULL DESC: JULY 15, 2025 HRA CLAIMS CK

ACCOUNT TOTAL

149.34

ORG 51047 TOTAL

149.34

TOTAL: 

FUND 510 ELECTRIC FUND

149.34

tlaw | INVOICE LIST BY GL ACCOUNT

| P 3 apinvgla

YEAR/PERIOD: 2026/1 TO 2026/2

ACCOUNT/VENDOR DOCUMENT VOUCHER PO YEAR/PR TYP S

WARRANT CHECK DESCRIPTION

53045

53045 05152

WATER DEPARTMENT

039617 MVP-HRA 86316

INVOICE:

U 2026 1 DIR P 51.34 03-26C 3371 JULY 15, 2025 HRA C FULL DESC: JULY 15, 2025 HRA CLAIMS CK

ACCOUNT TOTAL

51.34

ORG 53045 TOTAL 51.34

_______

FUND 530 WATER FUND

TOTAL: 51.34

tlaw

INVOICE LIST BY GL ACCOUNT

P 4 apinvgla

YEAR/PERIOD: 2026/1 TO 2026/2

ACCOUNT/VENDOR DOCUMENT VOUCHER PO YEAR/PR TYP S WARRANT CHECK DESCRIPTION

55046 SEWER DEPARTMENT

55046 05152

039617 MVP-HRA 86316

0 2026 1 DIR P 32.67 03-26C 3371 JULY 15, 2025 HRA C FULL DESC: JULY 15, 2025 HRA CLAIMS CK INVOICE:

> ACCOUNT TOTAL 32.67

> > ORG 55046 TOTAL 32.67

FUND 550 SEWER FUND TOTAL:

** END OF REPORT - Generated by Tanya Law **

INVOICE LIST BY GL ACCOUNT tlaw

YEAR/PERIOD: 2026/1 TO 2026/2 WARRANT CHECK DESCRIPTION ACCOUNT/VENDOR DOCUMENT VOUCHER PO YEAR/PR TYP S _____ ACCOUNTING 10230 05152 HRA 0 2026 1 DIR P .78 03-26D 3372 JULY 22,2025 HRA CL 039617 MVP-HRA 86317 FULL DESC: JULY 22,2025 HRA CLAIMS CARD INVOICE: ACCOUNT TOTAL .78 ORG 10230 TOTAL .78 HIGHWAY DEPT 10420 05152 HRA 10420 0 2026 1 DIR P 1.64 03-26D 3372 JULY 22,2025 HRA CL 86317 039617 MVP-HRA INVOICE: FULL DESC: JULY 22,2025 HRA CLAIMS CARD ACCOUNT TOTAL 1.64 1.64 ORG 10420 TOTAL ECONOMIC DEVELOPMENT 10645 10645 05152 0 2026 1 DIR P 039617 MVP-HRA 86317 3.32 03-26D 3372 JULY 22,2025 HRA CL INVOICE: FULL DESC: JULY 22,2025 HRA CLAIMS CARD ACCOUNT TOTAL 3.32 ORG 10645 TOTAL 3.32 5.74 FUND 010 TOWN GENERAL FUND TOTAL:

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tlaw INVOICE LIST BY GL ACCOUNT P 1 apinvgla

YEAR/PERIOD: 2026/1 TO 2026/2

ACCOUNT/VENDOR DOCUMENT VOUCHER PO YEAR/PR TYP S WARRANT CHECK DESCRIPTION 

10420 HIGHWAY DEPT

10420 05152 HRA

039617 MVP-HRA 86318 0 2026 1 DIR P 84.00 03-26E 3373 JULY 22,2025 HRA CL

INVOICE: FULL DESC: JULY 22,2025 HRA CLAIMS CK

> ACCOUNT TOTAL 84.00

ORG 10420 TOTAL 84.00

FUND 010 TOWN GENERAL FUND TOTAL: 84.00

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INVOICE LIST BY GL ACCOUNT

P 1 apinvgla

YEAR/PERIOD: 2026/1 TO 2026/2

DOCUMENT VOUCHER PO YEAR/PR TYP S WARRANT CHECK DESCRIPTION ACCOUNT/VENDOR

______

10230

tlaw

ACCOUNTING

10230 05152

039617 MVP-HRA 86336

HRA 0 2026 1 DIR P 806.03 03-26F 3374 JULY 29, 2025 HRA C

INVOICE:

FULL DESC: JULY 29, 2025 HRA CLAIMS CK

ACCOUNT TOTAL

806.03

ORG 10230 TOTAL

806.03

______

FUND 010 TOWN GENERAL FUND 

TOTAL:

806.03

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#### GENERAL LEDGER DISTRIBUTION JOURNAL: BIWEEKLY

WARRANT 022526

PAY PERIOD 07/07/2025 to 07/20/2025

CHECK DATE 07/25/2025

YEAR 2026 PERIOD 1 EXPENDITURE ENTRIES SHORT DESC 07/25/25PR GL EFF DATE 07/25/2025 REFERENCE 022526 REFERENCE2 1022526

SHORT DESC 07/	725/25PR	TOWN MANAGER TOWN CLERK/TREASURER ACCOUNTING ACCOU	REFE	RENCE2 1022526
ORG OBJE	ECT PROJECT  TOD 1  TOD	DRGANTZATTON TITLE	ACCOUNT DESCRIPTION	EXPENDITIBLE
YEAR 2026 PERI	ron 1	ORGANIZATION TITLE	CL CCC	DATE 07/25/2025
10130 0502	20	TOWN MANACED	ADDOTATED.	DATE 07/23/2023
10130 0505	.υ Λ	TOWN MANAGER	APPOINTED	2,384.73
10130 0505	50 - 4	TOWN MANAGER	CLERICAL	1,324.35
10130 0515	04	TOWN MANAGER	HEALTH INSURANCE PREMIUM	951.10
10130 0515	00	TOWN MANAGER	DENTAL INSURANCE	40.62
10130 0515	08	TOWN MANAGER	LIFE/DISABILITY INSURANCE	87.46
10130 0517	70	TOWN MANAGER	FICA	265.43
10130 0517	75	TOWN MANAGER	CHILD CARE CONTRIB TAX	14.00
10130 0518	30	TOWN MANAGER	RETIREMENT-VMERS	239.10
10140 0501	10	TOWN CLERK/TREASURER	ELECTED	2,766.41
10140 0501	12	TOWN CLERK/TREASURER	ELECTED TREASURER	212.00
10140 0502	20	TOWN CLERK/TREASURER	APPOINTED	1,889.25
10140 0515	54	TOWN CLERK/TREASURER	HEALTH INSURANCE PREMIUM	2,024.24
10140 0515	56	TOWN CLERK/TREASURER	DENTAL INSURANCE	98.97
10140 0515	58	TOWN CLERK/TREASURER	LIFE/DISABILITY INSURANCE	122.79
10140 0517	70	TOWN CLERK/TREASURER	FICA	333.30
10140 0517	75	TOWN CLERK/TREASURER	CHILD CARE CONTRIB TAX	17.37
10140 0518	30	TOWN CLERK/TREASURER	RETTREMENT-VMERS	279 34
10230 0505	50	ACCOUNTING	CLERTCAL	2 217 31
10230 0515	54	ACCOUNTING	HEALTH INSURANCE PREMIUM	420 84
10230 0515	56	ACCOUNTING	DENTAL THEILDANCE	10 80
10230 0515	58	ACCOUNTING	I TEE /DISABILITY THEHRANCE	53.03
10230 0517	70	ACCOUNTING	ETCA INSURANCE	161 50
10230 0517	75	ACCOUNTING	CUTIN CARE CONTRIB TAV	2 65
10230 0518	SO.	ACCOUNTING	DETTDEMENT_VMEDC	160.75
10260 0501	10	I TETEDE	ELECTED - VMERS	360.00
10260 0507	70	1 TETEDE	DADT_TIME	702.24
10260 0517	70	LIGITAGE	FACTORE	702.24
10260 0517	75	LISTERS	CUILD CARE CONTRIB TAY	4.67
10330 0503	20	LIDIERS	CHILD CARE CONTRIB TAX	2 000 00
10330 0504	10	POLICE DEPARTMENT	SUPERVISOR	3,000.00
10330 0505	10 10	POLICE DEPARTMENT	OFFICERS	3,9/3.11
10330 0503	1U	POLICE DEPARTMENT	CLERICAL	3,1/3.60
10330 0508 10330 0515	30	POLICE DEPARTMENT	OVERTIME	2,000.27
10330 0515	04 - c	PULICE DEPARTMENT	HEALTH INSURANCE PREMIUM	2,129.97
	00	POLICE DEPARTMENT	DENTAL INSURANCE	123.45
10330 0515	08	POLICE DEPARTMENT	LIFE/DISABILITY INSURANCE	217.48
10330 0517	70	POLICE DEPARTMENT	FICA	959,62
10330 0517	75	POLICE DEPARTMENT	CHILD CARE CONTRIB TAX	48.67
10330 0518	30	POLICE DEPARTMENT	RETIREMENT-VMERS	1,352.26
10340 0503	30	AMBULANCE DEPARTMENT	SUPERVISOR	3,024.00
10340 0507	70	AMBULANCE DEPARTMENT	PART-TIME	5,280.75
10340 0507	72	AMBULANCE DEPARTMENT	RUN PAY	1,150.00
10340 0507	73	AMBULANCE DEPARTMENT	TRAINING PAY	284.68
10340 0508	33	AMBULANCE DEPARTMENT	OT - HALF RATE ONLY	187.64
10340 0509	90	AMBULANCE DEPARTMENT	STANDBY/ON CALL	1.109.50
10340 0509	91	AMBULANCE DEPARTMENT	WEEKEND SUPERVISOR	250.00
10340 0511	10	AMBULANCE DEPARTMENT	NON EMERGENCY TRANSFERS	87.75
10340 0511	11	AMBULANCE DEPARTMENT	TRANSFER CREW-PD SHIFT	558.00



# GENERAL LEDGER DISTRIBUTION JOURNAL: BIWEEKLY

WARRANT 022526

PAY PERIOD 07/07/2025 to 07/20/2025

CHECK DATE 07/25/2025

YEAR 2026 PERIOD 1 EXPENDITURE ENTRIES SHORT DESC 07/25/25PR GL EFF DATE 07/25/2025 REFERENCE 022526 REFERENCE2 1022526

5110111	01/13/1	23110		REFEREN	CE2 1022320
ORG	OBJECT	PROJECT	ORGANIZATION TITLE	ACCOUNT DESCRIPTION	
10340	05151		AMBULANCE DEPARTMENT	EMPLOYEE HEALTH BUYOUT DENTAL INSURANCE LIFE/DISABILITY INSURANCE FICA	500.00
10340	05156		AMBULANCE DEPARTMENT	DENTAL INSURANCE	63.02
10340	05158		AMBULANCE DEPARTMENT	LITEF/DISABILITY INSURANCE	78.96
10340	05170		AMBULANCE DEPARTMENT	FTCA	950.83
10340	05175			CHILD CARE CONTRIB TAX	52.95
10340	05180		AMBIN ANCE DEPARTMENT	RETTREMENT_VMEPS	228.38
10420	05040		HTGHWAY DEPT	TECHNICAL	14 044 18
10420	05080		HIGHWAY DEPT	OVERTIME	182 16
10420	05151		AMBULANCE DEPARTMENT AMBULANCE DEPARTMENT HIGHWAY DEPT GROUNDS PEPT GROUNDS PEPT	EMPLOYEE HEALTH BUYOUT	500.00
10420	05154		HTGHWAY DEPT	HEALTH INCHPANCE DEMIN	2 621 79
10420	05156		HIGHWAY DEPT	DENTAL THIS DANCE	185 66
10420	05158		HIGHWAY DEPT	LIFE OTSARTITY THEIRANCE	321 13
10420	05170		HIGHWAY DEPT	ETCA ETCA	1 103 10
10420	05175		HIGHWAY DEPT	CHILD CARE CONTRIR TAY	58 18
10420	05180		HIGHWAY DEPT	PETTPEMENT_VMEPS	997.66
10520	05040		GROUNDS/PARKS/FACILITIES	TECHNICAL	1 000 41
10520	05080		GROUNDS/PARKS/FACILITIES	OVERTIME	1,000,41
10520	05154		GROUNDS/PARKS/FACILITIES	DEALTH INCHDANCE DREMIN	212 28
10520	05156		GROUNDS/PARKS/FACILITIES	DENTAL INSURANCE PREMIUM	10.04
10520	05158		GROUNDS/PARKS/FACILITIES	I TEE ATCADTI TTV TAICHDANCE	24 09
10520	05170		GROUNDS/PARKS/FACILITIES	ETCA	73 01
10520	05175		GROUNDS/PARKS/FACILITIES	CHILD CADE CONTRIDED TAY	3.91
10520	05180		CROUNDS /PARKS /EACTL TTTES	DETTREMENT_VMEDS	73 89
10550	05030		POOL POOL POOL POOL POOL PLANNING/ZONING PLANNING/ZONING PLANNING/ZONING PLANNING/ZONING PLANNING/ZONING ECONOMIC DEVELOPMENT	POOL DIRECTOR	2 066 40
10550	05070		POOL	PART-TIME GUARDS	8 801 00
10550	05170		POOL	ETCA	831 39
10550	05175		POOL	CHILD CARE CONTRIR TAY	47 81
10620	05020		PLANNING/ZONING	ZONTNG ADMINISTRATOR	1 026 80
10620	05170		PLANNING/ZONING	ETCA	78 55
10620	05175		PLANNING/ZONING	CHILD CARE CONTRIR TAX	4 52
10645	05051		ECONOMIC DEVELOPMENT	ECONOMIC DEVEL COOPDINATO	3 114 02
10645	05154		ECONOMIC DEVELOPMENT	HEALTH INSUPANCE DEMILIM	113 34
10645	05156		ECONOMIC DEVELOPMENT	DENTAL THEODOXICE	10 80
10645	05170		ECONOMIC DEVELOPMENT	ETCA INSURANCE	738 77
10645	05175		ECONOMIC DEVELOPMENT	CUTID CADE CONTOTO TAY	12 46
10645	05180		ECONOMIC DEVELORMENT	DETTDEMENT_VMEDS	225 77
10015	03200		ECONOMIC DEVELOPMENT	RETIREMENT-VMERS	223.11
				FOND FOTALS	61,225,92
51047	05151		CLECTRIC DEPARTMENT	ENDLOYEE HEALTH DUNGLE	
51047	05154		ELECTRIC DEPARTMENT	EMPLOYEE HEALTH BUYOUT	200.00
51047	05156		ELECTRIC DEPARTMENT	DENTAL INSURANCE PREMIUM	1,902.54
51047	05158		ELECTRIC DEPARTMENT	DENIAL INSURANCE	116.01
51047	05170		ELECIKIC DEPARTMENT	FILE OISURILLIA INSORUNCE	160.72
51047	05175		ELECIKIC DEPARTMENT	FICA	599.58
51047	05180		ELECIKIC DEPARTMENT	CHILD CAKE CONTRIB TAX	31.62
51047	90210		ELECTRIC DEPARTMENT	KEIIKEMENI-VMEKS	451.42
51047	92010		ELECIKIC DEPARTMENT	MINITOTOAL MANAGED	433.02 928.58
24047	22010		ELECTRIC DEPARTMENT	EMPLOYEE HEALTH BUYOUT HEALTH INSURANCE PREMIUM DENTAL INSURANCE LIFE/DISABILITY INSURANCE FICA CHILD CARE CONTRIB TAX RETIREMENT-VMERS METER READING MUNICIPAL MANAGER	370.30

Report generated: 07/22/2025 17:25 User: tlaw

Program ID:

prjournl



#### GENERAL LEDGER DISTRIBUTION JOURNAL: BIWEEKLY

WARRANT 022526

PAY PERIOD 07/07/2025 to 07/20/2025

CHECK DATE 07/25/2025

YEAR 2026 PERIOD 1 EXPENDITURE ENTRIES

GL EFF DATE 07/25/2025 REFERENCE 022526

SHORT DESC 07/25/	² 5PR		REFERENCE2	1022526
ORG OBJECT 51047 92012 51047 92013 51047 92014 51047 92016 51047 92018 51047 92019	PROJECT	ORGANIZATION TITLE ELECTRIC DEPARTMENT	ACCOUNT DESCRIPTION CLERICAL LABOR OVERTIME LABOR SUPERINTENDENT ASSISTANT TECHNICAL LABOR STAND-BY FUND TOTALS	1,811.68 206.00 892.60 2,579.08 1,222.96 45.00
53045         05020           53045         05030           53045         05042           53045         05080           53045         05090           53045         05151           53045         05154           53045         05156           53045         05170           53045         05170           53045         05170           53045         05175           53045         05175           53045         05180		WATER DEPARTMENT	APPOINTED SUPERVISOR TECHNICAL/ADMIN/CLERICAL OVERTIME STANDBY/ON CALL EMPLOYEE HEALTH BUYOUT HEALTH INSURANCE PREMIUM DENTAL INSURANCE LIFE/DISABILITY INSURANCE FICA CHILD CARE CONTRIB TAX RETIREMENT-VMERS	527.60 1,606.68 5,491.95 374.76 153.00 480.00 1,442.04 126.63 169.03 632.49 32.91 557.03
\$5046 05020 \$5046 05030 \$5046 05042 \$5046 05080 \$5046 05151 \$5046 05154 \$5046 05156 \$5046 05158 \$5046 05170 \$5046 05175 \$5046 05175 \$5046 05175		SEWER DEPARTMENT	APPOINTED SUPERVISOR TECHNICAL/ADMIN/CLERICAL OVERTIME STANDBY/ON CALL EMPLOYEE HEALTH BUYOUT HEALTH INSURANCE PREMIUM DENTAL INSURANCE LIFE/DISABILITY INSURANCE FICA CHILD CARE CONTRIB TAX RETIREMENT-VMERS FUND TOTALS	379.87 1,071.12 3,645.38 1,337.10 102.00 320.00 1,007.87 95.45 129.09 504.85 26.14 450.94 9,069.81

Report generated: 07/22/2025 17:25 User: tlaw Program ID: prjournl

OBJECT PROJECT



# GENERAL LEDGER DISTRIBUTION JOURNAL: MISC

WARRANT M02526

ORG

10330

10330

10330

PAY PERIOD 07/07/2025 to 07/20/2025

CHECK DATE 07/25/2025

YEAR 2026 PERIOD 1 EXPENDITURE ENTRIES SHORT DESC 7/25/25MPR

YEAR 2026 PERIOD 1

05154

05156

05158

GL EFF DATE 07/25/2025 REFERENCE M02526 REFERENCE2 2M02526

ORGANIZATION TITLE	ACCOUNT DESCRIPTION	EXPENDITURE
POLICE DEPARTMENT POLICE DEPARTMENT POLICE DEPARTMENT	GL EFF DAT HEALTH INSURANCE PREMIUM DENTAL INSURANCE LIFE/DISABILITY INSURANCE	E 07/25/2025 884.84 62.50 70.22
	FUND TOTALS	1,017.56
	GRAND TOTALS	1,017,56

Report generated: 07/23/2025 14:41

User: Program ID:

prjournl



# GENERAL LEDGER DISTRIBUTION JOURNAL: BIWEEKLY

WARRANT 032526

PAY PERIOD 07/21/2025 to 08/03/2025

CHECK DATE 08/08/2025

YEAR 2026 PERIOD 2 EXPENDITURE ENTRIES SHORT DESC 08/08/25PR GL EFF DATE 08/08/2025 REFERENCE 032526 REFERENCE2 1032526

SHORT DESC	08/08/25	PR		REF	ERENCE2 1032526
ORG	ОВЈЕСТ	PROJECT 2	TOWN MANAGER TOWN CLERK/TREASURER ACCOUNTING ACCOUNTING ACCOUNTING ACCOUNTING ACCOUNTING ACCOUNTING ACCOUNTING TOWN TOWN TOWN TOWN TOWN TOWN TOWN TOWN	ACCOUNT DESCRIPTION	EXPENDITURE
YEAR 2026	PERTOD	2		GI FE	E DATE 08/08/2025
10130	05020	_	TOWN MANAGER	APPOINTED	2 384 75
10130	05050		TOWN MANAGER	CLERTCAL	1 324 36
10130	05154		TOWN MANAGER	HEALTH INSURANCE PREMIUM	951 10
10130	05156		TOWN MANAGER	DENTAL INSURANCE	40.62
10130	05170		TOWN MANAGER	FICA	265 43
10130	05175		TOWN MANAGER	CHILD CARE CONTRIR TAY	14 00
10130	05180		TOWN MANAGER	RETTREMENT~VMERS	239 10
10140	05010		TOWN CLERK/TREASURER	FLECTED	2 766 40
10140	05012		TOWN CLERK/TREASURER	ELECTED TREASURER	217 00
10140	05020		TOWN CLERK/TREASURER	APPOINTED	1 889 75
10140	05154		TOWN CLERK/TREASURER	HEALTH INSURANCE PREMIUM	2 024 24
10140	05156		TOWN CLERK/TREASURER	DENTAL INSURANCE	08 07
10140	05170		TOWN CLERK/TREASURER	FTCA	333.30
10140	05175		TOWN CLERK/TREASURER	CHTID CARE CONTRIR TAX	17 37
10140	05180		TOWN CLERK/TREASURER	RETTREMENT-VMERS	279 34
10230	05050		ACCOUNTING	CI FRICAL	2 429 82
10230	05080		ACCOUNTING	OVERTIME	195 46
10230	05154		ACCOUNTING	HEALTH INSURANCE PREMIUM	420 84
10230	05156		ACCOUNTING	DENTAL INSURANCE	19.90
10230	05170		ACCOUNTING	FTCA	192.78
10230	05175		ACCOUNTING	CHTLD CARE CONTRIB TAX	10.32
10230	05180		ACCOUNTING	RETIREMENT-VMFRS	190.33
10260	05010		LISTERS	ELECTED	432.00
10260	05070		LISTERS	PART-TIME	585 20
10260	05170		LISTERS	FICA	77.81
10260	05175		LISTERS	CHILD CARE CONTRIB TAX	4 47
10320	05070		ETRE DEPARTMENT	PART-TIME	518.37
10320	05170		FIRE DEPARTMENT	FTCA	39.66
10320	05175		FIRE DEPARTMENT	CHILD CARE CONTRIB TAX	2.23
10320	05180		FIRE DEPARTMENT	RETTREMENT-VMERS	11.18
10330	05030		POLICE DEPARTMENT	SUPERVISOR	3.888.00
10330	05040		POLICE DEPARTMENT	OFFICERS	3,972,36
10330	05050		POLICE DEPARTMENT	CLERICAL	2.873.60
10330	05080		POLICE DEPARTMENT	OVERTIME	1.965.18
10330	05154		POLICE DEPARTMENT	HEALTH INSURANCE PREMIUM	3,014,83
10330	05156		POLICE DEPARTMENT	DENTAL INSURANCE	185.95
10330	05170		POLICE DEPARTMENT	FICA	933.93
10330	05175		POLICE DEPARTMENT	CHILD CARE CONTRIB TAX	47.22
10330	05180		POLICE DEPARTMENT	RETIREMENT-VMERS	1,348.10
10340	05030		AMBULANCE DEPARTMENT	SUPERVISOR	3,024.00
10340	05070		AMBULANCE DEPARTMENT	PART-TIME	5,645.63
10340	05072		AMBULANCE DEPARTMENT	RUN PAY	1,306.32
10340	05083		AMBULANCE DEPARTMENT	OT - HALF RATE ONLY	53.67
10340	05090		AMBULANCE DEPARTMENT	STANDBY/ON CALL	1,081.50
10340	05091		AMBULANCE DEPARTMENT	WEEKEND SUPERVISOR	250.00
10340	05110		AMBULANCE DEPARTMENT	NON EMERGENCY TRANSFERS	164.25
10340	05111		AMBULANCE DEPARTMENT	TRANSFER CREW-PD SHIFT	543.75



#### **GENERAL LEDGER DISTRIBUTION JOURNAL: BIWEEKLY**

WARRANT 032526

PAY PERIOD 07/21/2025 to 08/03/2025

CHECK DATE 08/08/2025

YEAR 2026 PERIOD 2 EXPENDITURE ENTRIES SHORT DESC 08/08/25PR GL EFF DATE 08/08/2025 REFERENCE 032526 REFERENCE2 1032526

ORG	OBJECT	PROJECT	ORGANIZATION TITLE	ACCOUNT DESCRIPTION	EXPENDITURE
10340	05156		AMBULANCE DEPARTMENT	DENTAL INSURANCE	63.02
10340	05170		AMBULANCE DEPARTMENT	FICA	923.05
10340	05175		AMBULANCE DEPARTMENT	CHILD CARE CONTRIB TAX	51.43
10340	05180		AMBULANCE DEPARTMENT	RETIREMENT-VMERS	219.24
10420	05040		HIGHWAY DEPT	TECHNICAL	13.969.99
10420	05080		HIGHWAY DEPT	OVERTIME	91.08
10420	05154		HIGHWAY DEPT	HEALTH INSURANCE PREMIUM	2.616.31
10420	05156		HIGHWAY DEPT	DENTAL INSURANCE	184.67
10420	05170		HIGHWAY DEPT	FICA	1.052.31
10420	05175		HIGHWAY DEPT	CHTLD CARE CONTRIB TAX	55.35
10420	05180		HIGHWAY DEPT	RETTREMENT-VMERS	985.68
10520	05040		GROUNDS/PARKS/FACILITIES	TECHNICAL	1,000.41
10520	05154		GROUNDS/PARKS/FACILITIES	HEALTH INSURANCE PREMIUM	210.42
10520	05156		GROUNDS/PARKS/FACTL TTTES	DENTAL INSURANCE	9 95
10520	05170		GROUNDS/PARKS/FACTLITIES	FTCA	72.52
10520	05175		GROUNDS/PARKS/FACTLITTES	CHILD CARE CONTRIB TAX	3 88
10520	05180		GROUNDS/PARKS/FACTLITTES	RETTREMENT-VMERS	72.53
10550	05030		POOL	POOL DIRECTOR	2 066 40
10550	05070		POOL	PART-TIME GUARDS	8 464 25
10550	05080		P001	OVERTIME	38 25
10550	05170		P001	FTCΔ	808 53
10550	05175		POOL	CHILD CARE CONTRIR TAX	46 51
10620	05020		PLANNING/ZONING	ZONING ADMINISTRATOR	1 026 80
10620	05170		PLANNING/ZONING	ETCA	78 55
10620	05175		PLANNING/ZONING	CHILD CAPE CONTERE TAY	10.55
10645	05051		ECONOMIC DEVELOPMENT	ECONOMIC DEVEL COOPDINATO	3 016 00
10645	05154		ECONOMIC DEVELOPMENT	HEALTH INSUDANCE DREMTUM	413 34
10645	05156		ECONOMIC DEVELOPMENT	DENTAL INSURANCE	10 00
10645	05170		ECONOMIC DEVELOPMENT	ETCA	230.73
10645	05175		ECONOMIC DEVELOPMENT	CUTIO CADE CONTOTO TAY	12.06
10645	05180		ECONOMIC DEVELOPMENT	DETTDEMENT_VMEDE	218 67
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51047	05175		ELECTRIC DEPARTMENT	CHILD CARE CONTRIR TAY	24 83
51047	05180		ELECTRIC DEPARTMENT	DETTDEMENT_VMEDS	145 17
51047	90210		ELECTRIC DEPARTMENT	METED DEADING	433.02
51047	92010		ELECTRIC DEPARTMENT	MINITOTONI MANACED	028 58
51047	92012		ELECTRIC DEPARTMENT	CLEDICAL LARAD	1 854 87
51047	92013		ELECTRIC DEPARTMENT	OVERTIME I AROR	1,034.07 64.70
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ORG OBJECT	PROJECT	ORGANIZATION TITLE	ACCOUNT DESCRIPTION FUND TOTALS	9,682.07
53045         05020           53045         05030           53045         05042           53045         05080           53045         05090           53045         05154           53045         05156           53045         05170           53045         05175           53045         05175           53045         05180		WATER DEPARTMENT	APPOINTED SUPERVISOR TECHNICAL/ADMIN/CLERICAL OVERTIME STANDBY/ON CALL HEALTH INSURANCE PREMIUM DENTAL INSURANCE FICA CHILD CARE CONTRIB TAX RETIREMENT-VMERS	527.60 1,606.68 5,544.63 235.73 153.00 1,383.74 126.46 590.30 30.58 550.78
55046 05020 55046 05030 55046 05080 55046 05090 55046 05154 55046 05156 55046 05170 55046 05175 55046 05175 55046 05180		SEWER DEPARTMENT	APPOINTED SUPERVISOR TECHNICAL/ADMIN/CLERICAL OVERTIME STANDBY/ON CALL HEALTH INSURANCE PREMIUM DENTAL INSURANCE FICA CHILD CARE CONTRIB TAX RETIREMENT-VMERS FUNDSTORALS GRAND TOTALS	379.87 1,071.12 3,680.06 1,010.28 102.00 1,110.15 99.10 456.02 23.62 429.75 8,361.97

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# TOWN OF NORTHFIELD, VERMONT TOWN FOREST STEWARDSHIP COMMITTEE Minutes of July 15, 2025

#### I. ROLL CALL

Ginny, Russ, Bill, Jeremy, Andrew, Ray came late.

Sam Schonberg from the public

II. PUBLIC PARTICIPATION (SCHEDULED): None.

III. APPROVAL OF MINUTES: June 17, 2025

IV. AGENDA UPDATES OR ADDITIONS

#### **V. UPDATES & DISCUSSION**

- a. Introduction of New Member: Bill Dell'Isola
- **b. Shaw Outdoor Center Update**

Field past the paintball shed got mowed a few weeks ago.

Mowing scheduled for August for the rest of the property.

Possible mulching around the paintball field tbd

2 more weeks of summer programming

Rook week is 8/16

Jeremy and Andrew anticipate getting in front of some of the cadre before the school year gets going

# c. Vermont Youth Conservation Corps (VYCC) Work update

Jeremy gives update that VYCC is finished with the trail bypass. He says they built well defined drainage. Renaturalization efforts were made to conceal the old section. Possible plans to move the butternut tree sign. VYCC has started working on clearing the beaver pond vista view. With remaining funds, two benches and a sign will be put in at the beaver pond vista. VYCC will be directed back to Garvey to clean up some additional drainage. Total project work completed - tree work on Garvey Hill, butternut junction reroute, beaver pond vista, and drainage work on Garvey.

### d. Cheney Field Parking

Ginny pointed out that we did not have an official vote on parking in Cheney Field after water tank project wraps up.

Mobility task force chair has requested to speak at the next NCC meeting Jeremy gives the floor to Russ in order to discuss the impacts of parking in the field

Recap - study done by VOREC/Ridge and Rivers looking for possible spots for parking for the town forest

DB&K did the study. They determined that street parking nor parking in the field would be viable.

They did note that accessibility to the Town Forest was an issue.

Jeremy reminds us that our directive is to protect the field environment. He hopes that the field will be returned to its original state after the construction is done.

What happens if we add a parking lot to the field. How does this help a person with accessibility issues enjoy the town forest?

Do we have to make ADA compliant trails? Should we?

The road is not wide enough for two cars to pass.

There are already issues with people misusing the field to have campfires.

There are questions about how this would change the way Norwich uses the field.

Bill adds perspective - this would impact conservation values of the forest. There would be no going back after this structure is put in place, and a disruption to forest habitat blocks.

Bill asks how ongoing maintenance would be funded.

Public participation - Sam Schonberg - indigo bunting - this person tried to take their elderly mom up to see these nests in the field. They recognized that the logistical and financial costs would be prohibitive. They were not able to make it up there to see. Is it fair to have this resource that some residents cannot utilize?

There is legal parking on Byam with restrictions of 250 ft from the gate on the public road.

Ginny reminds us that we have a town forest without any parking and does not think this is fair or equitable.

Bill asks what the NCC thinks about this. NCC has informed the Select Board that they are not in favor.

The Select Board advised the citizen to discuss with the NCC. They are on the agenda for the NCC meeting this month.

**Motion** - TFSC's stance is no parking in the field. We recognize it's not fair that we have this public resource that is not accessible. We support ongoing discussions to improve accessibility in the Town Forest. Ray puts motion forward - Bill seconds - 3-0-2 - passes.

#### e. Town Forest Plan

Robert Nelson is trying to update the old Town Forest Plan. He has done an inventory and has what he needs to put the plan together. Having this plan will be critical to ongoing efforts for easements and funding. Last plan was put together in 2010. We will keep trying to get an update.

# VI. PUBLIC PARTICIPATION (UNSCHEDULED)

Sam is interested in being involved in the disc golf course if the opportunity exists.

Andrew recaps the situation up till now. Andrew has an intern that may be working on this project. Andrew offers to connect with Sam via email.

#### **VII. OTHER BUSINESS**

Discussion about Lybrand. Norwich is still pursuing FEMA funding.

Ray asks what the mechanism is to have more community trail maintenance and construction. Jeremy says we would need to do more homework on how this is working in other jurisdictions.

#### **Future Agenda Items**

Ongoing trail workdays.

List of projects for VYCC or just general project for community workdays.

- Mowing/weed eating
- Water bars
- Dustin's Pasture site walk
- Moving the Paine mtn mile markers
- On Clark there are some 6x6s that could be cleaned up or turned into a bridge
- Old signage inventory
- Clean up tree with barbed wire
- Hawk watch vista clearing for student volunteer day
- VYCC invasive control?

#### VIII. ADJOURNMENT

Russ motions to adjourn - Ray 2nd - 5-0-0

Minutes Northfield Conservation Commission July 23,2025

- 1. Roll Call: David, Mariela, Nigel, Russ, Debbie, Suz, Jeremy & Ruth Members of the public: Laura Hill-Eubanks, Mary Nadon Scott, Janan Hamm, Bill Clemmons, Tim Swartz, Gerard Lavarnway
- 2. No updates to agenda
- 3. Public Participation scheduled:
  - A. Cheney Field Access/parking discussion

Members of the public, including representatives from the Accessibility, Walkability, and Pedestrian Safety Task Force and the commission offered feedback on the idea that a heavy equipment staging area related to the water tank project could remain post-construction and serve as an accessible parking lot for Cheney Field and Town Forest.

Suz and Jeremy presented a number of questions that require answers prior to any development of access or parking in Cheney Field:

- · Permit needed
- Need for an engineered plan, including what else is needed besides the surface (signage, a way to keep vehicles from entering the rest of the town forest, etc.)
- Timeline for the decision to be made in regards to the contractor
- Road crew feedback
- Water dept feedback
- What happens after parking? Accessible trail? USFS standards?

David proposed to draft a communication to the Select Board detailing questions raised in this discussion. 2nd by Russ. The motion passed, Jeremy abstaining.

There was general agreement that NCC supports improved access for the town forest and working with the Walkability Accessibility Safety Group was a step to address this issue. David proposed that NCC schedule meetings with the Walkability, Accessibility Group to begin a work group process to discuss Town Forest Accessibility. 2nd by Suz. Unanimous.

4. Minutes of the June 25, 2025 meeting were approved on a motion by Russ, 2nd by Jeremy. Unanimous.

#### 5. Discussion

- A. Cheney Field Restoration: David summarized the role of NCC as serving to advise the Select Board using our experience and knowledge. Members expressed concern that the information provided by Town Manager regarding the contract language was insufficient to conclude whether the damage done to the field from the road would be restored by the contractor. David agreed to convey the NCC's concerns to the Select Board.
- B. Clean Water Workshop and Reconnecting with Rivers Cohort Meeting: The cohort includes Barre, Winooski and Northfield. Idea to have speakers with river science knowledge was offered.
- C. Upcoming Riverwalk Events: Appreciation expressed to Janan for organizing river walks and agreement that NCC would like to help support future walks and related activities to strengthen community connection to the Dog River.

# D. Upcoming Meetings

- 1. Berlin Conservation Commission re: Shared Northfield/Berlin Conservation Opportunities on September 3, at 4:30 Berlin Town Offices
- 2. Meeting with the Mad River Valley Conservation Commission re: Shared Mad River Valley/Northfield Conservation Opportunities to be scheduled
- 3. Jens Hilke, VT Fish and Wildlife re: Vermont Conservation Design Priorities in the Northfield Range August 1, at 11:00 a.m.

- 6. Updates: Postponed
  - a. Climate Smart School Yards Grant
  - b. VYCC Youth Trails Improvement Project
  - c. Town Forest Stewardship Committee
- 7. Public Participation Unscheduled: none
- 8. The meeting was adjourned at 8:20 on a motion by Nigel, 2nd by Ruth.

#### CENTRAL VERMONT REGIONAL PLANNING COMMISSION EMERGENCY MUTUAL AID AGREEMENT FOR THE PUBLIC WORKS DEPARTMENTS OF ITS MEMBER MUNICIPALITIES

This Mutual Aid Agreement (the "Agreement") is entered into between the Central Vermont Regional Planning Commission ("CVRPC") and by and among each member municipality that voluntarily executes and adopts the terms and conditions contained herein.

WHEREAS, the Vermont Supreme Court has held and adopted the position that "It is a general and undisputed proposition of law that a municipal corporation possesses and can exercise the following powers, and no others: First, those granted in express words; second, those necessarily or fairly implied in or incident to the powers expressly granted; third, those essential to the accomplishment of the declared objects and purposes of the corporation—not simply convenient, but indispensable." Valcour v. Vill. of Morrisville, 104 Vt. 119, 158 A. 83, 85 (1932), citing Dillon, John, The Law of Municipal Corporations (5th Ed.) par. 237; and

WHEREAS, that upon the adoption of bylaws specifying the process for entering into, method of withdrawal from, and method of terminating service agreements with municipalities, the Vermont Legislature has granted express authority for regional planning commissions to "promote cooperative agreements and coordinate, implement, and administer service agreements among municipalities, including arrangements and action with respect to planning, community development, joint purchasing, intermunicipal services, infrastructure, and related activities...." 24 V.S.A. § 4345b(c); and

WHEREAS, the member municipalities of the CVRPC (collectively the "Parties") may voluntarily agree to participate in mutual aid and public works assistance activities conducted pursuant to 24 V.S.A. § 4345b(d)(2); and

WHEREAS, the CVRPC has duly adopted bylaws pertaining to the creation of intermunicipal service agreements pursuant to 24 V.S.A. § 4345b(a) and (b); and

WHEREAS, the Parties recognize that they are vulnerable to a variety of potential, natural and man-made disasters that impact vital public works resources including hurricanes, flooding and extreme winter conditions that in the past have caused severe disruption of essential public works services and severe property damage to public roads, utilities and other public works property; and;

WHEREAS, owning and maintaining all the resources needed to respond to extreme, unexpected and high-demand incidents is cost-prohibitive for most municipalities and entering into a mutual aid agreement provides economic and logistical efficiencies to support any gaps in resources and capabilities; and

WHEREAS, the Parties to this Agreement recognize the benefits of mutual aid in protecting the public, health, safety and welfare and fostering a sense of goodwill and community within a specific geographic region and therefore desire to provide mutual aid and assistance to one another during times of disaster and other types of public works emergencies; and

WHEREAS, the Parties recognize that having this mutual aid agreement and related guidelines is essential to ensuring a consistent, coordinated, and timely response in providing mutual aid; and

NOW, THEREFORE, the Parties hereto agree as follows:

#### **SECTION 1: PURPOSE**

The Agreement set forth below, is established to provide a means for public works related entities that are controlled by the CVRPC member municipalities, that are in need of mutual aid assistance, to be able to request and receive such aid and assistance in a timely manner from the participating member municipalities including but not limited to personnel, equipment, materials and any other services that may be reasonably necessary to respond to an emergency. The purpose of this Agreement is to formalize the regional mutual aid program. This Agreement to render aid is expressly not contingent upon a declaration of a major disaster or emergency by the federal government or upon receiving federal funds.

#### **SECTION 2: DEFINITIONS**

- **A.** Aid and Assistance includes, but is not limited to, personnel, equipment, administrative services, infrastructure, supplies and materials necessary to respond to a request for mutual aid.
- **B.** Aiding Official means a person who is designated by the Aiding Party to determine whether and to what extent the Aiding Party should provide Public Works Assistance to a Requesting Party.
- C. Aiding Party means a Constituent Municipal entity that furnishes, equipment, services, personnel or any other Public Works assistance to a Requesting Party.
- D. Agreement refers to this Agreement for public works emergency services. The Central Vermont Region municipalities may become a party to this Agreement upon ratification of this Agreement by the CVRPC and ratification by the legislative body of the Constituent Municipality that is a party to this Agreement. Each Constituent Municipality that ratifies this Agreement, understands that the Agreement contains all Constituent Municipal entities at the time of ratification, and any other eligible municipality in the future.

- E. Constituent Municipality Any municipality located in the Central Vermont Regional Planning Commission service area in Vermont that is a party to this Agreement.
- F. **Disaster** any natural, mechanical, human-made, technological, or civil emergency that threatens to cause damages of a severity and scale that exceeds the maximum capabilities of a Constituent Municipality.
- G. Emergency an event or imminent potential for such an event, either natural or human caused, that results in or may result in, injury or harm to the residences of the Constituent Municipality, or damage to or loss of property.
- Mutual Aid Resource List A list maintained by each Constituent Municipality of the public works equipment, personnel and any other resources available for the provision of aid and assistance if needed by another Constituent Municipality.
- I. Period of Assistance the period of time beginning when the Aiding Party assists the Requesting party by providing equipment, personnel, supplies or any other Public Works Assistance and ending when all Public Works Assistance returns to the regular duties of the Aiding Party.
- J. Public Works Assistance means equipment and personnel including, but not limited to; professional engineers, licensed staff, non-licensed personnel who are employed by a Constituent Municipality and used for activities in response to a disaster or emergency, related to roadways, water, stormwater, wastewater and any other public works program.
- K. Requesting Official means any person who is designated by the Requesting Party to request Public Works Assistance from a participating Aiding Party.
- L. Requesting Party means a Constituent Municipal entity that requests, equipment, services, personnel or any other Public Works assistance from an Aiding Party.

#### **SECTION 3: PROCEDURES**

- A. Operations Oversight The CVRPC shall be responsible for overseeingthis Agreement and help to facilitate communications between the Constituent Municipalities. The CVRPC will also help to facilitate policies and procedures to guide requests for aid and assistance as set forth below.
- B. Request for Aid When a Requesting Party has been impacted by or is in imminent danger of a disaster or emergency, it may request Aid and Assistance from an Aiding Party, by making a verbal request, followed by a written request, to the Aiding Party, within three business days after aid is

needed or contemplated to be needed. An Aid Request Form shall be an addendum, but not an amendment to or modification of this Agreement. Requests should be made by and to the Aiding Party's authorized Aiding Official. A potentially Aiding Party, should not provide aid on its own without first confirming the need for assistance through the communication of the Aiding Official and Requesting Official to ensure that the type of aid being provided is necessary and needed. The provision of aid by an Aiding Party is entirely discretionary under this Agreement and the ultimate decision as to whether to render aid to a Requesting party shall be at the discretion of the Aiding Official in consultation with the legislative body of the Constituent Municipality if possible.

- C. Designation of Officials Each Constituent Municipality shall designate an Aiding Official and Requesting Official and at least one alternate Aiding Official and Requesting Official. Each Constituent Municipality shall be responsible for maintaining its own contact list of all Aiding and Requesting Officials and alternate Officials, along with all means of contact including, but not limited to cell phones, telephones, electronic mail and physical addresses and take reasonable steps to ensure that all Constituent Municipalities have the most current list. The CVRPC shall help develop the template of the contact list and annually aid in its distribution after having been provided by the Constituent Municipalities. Said list shall be an addendum, but not an amendment to or modification of this Agreement. The Requesting Officials and the Aiding Officials may be the same person in each municipality (i.e. a director of public works or Road Commissioner).
- D. Information Needed Request for Aid and Assistance The Requesting Official shall provide, at minimum, to the Aiding Official and CVRPC (for informational purposes only): 1) a description of the disaster or emergency prompting the request; 2) what type of specific assistance is needed; 3) a description of the infrastructure impacted and the specific work needed to repair the infrastructure; and 4) an estimate of the type of public works assistance needed and the period of time it will be needed for. It is further recommended that the Requesting Official propose a plan for meeting with the Aiding Official to discuss the scope of the aid and for the Requesting Official to familiarize him or herself with the personnel and equipment of the Aiding Party (similar in nature to a pre-construction meeting). The Aiding Party shall then provide an estimate to the Requesting Party of expected costs for the scope of work requested and needed.
- E. Supervision and Control It is the intention of this Agreement that supervision and control of personnel will be structured in accordance with Federal Emergency Management Agency's (FEMA) Incident Command System (ICS) of the National Incident Management System (NIMS), and that if the emergency/disaster is multi-jurisdictional, a Unified Command will be employed when practical.

- 1. When any personnel or equipment is deployed under the terms of this agreement, the Aiding Official shall meet with the Requesting Official. Orders by the Requesting Official will be given to the Aiding Official who will then give orders or direction to their personnel. The Aiding Official shall maintain reasonable contact with the Requesting Official as long as the Aiding Party is providing Public Works Assistance. The personnel of the Aiding Party may only be under the direct control of the Requesting party by a written mutual agreement.
- 2. In all instances and at all times, the Requesting Official or a designee thereof, shall have the right and responsibility to ensure that all personnel from the Aiding Party are asked to perform only those tasks or operations that are consistent with their training and are in accordance with their home protocols and accepted safe practices.
- 3. Personnel from the Aiding Party shall continue with the assigned tasks until the Requesting Party releases said personnel and equipment or until the Aiding Party recalls said personnel and equipment. No recall by an Aiding Party shall occur until, if reasonable given the facts and circumstances, the Aiding Official discusses the need for recall with the Requesting Official.
- 4. Each Aiding Party shall operate in accordance with the protocols of its Constituent Municipality, and all Aiding Party personnel shall act within the scope of his or her own training and certification or under the supervision of a person with the appropriate training and certification. Aiding Party personnel shall not be required to perform in a way that is inconsistent with the practices of their Constituent Municipality protocols or inconsistent with safe practices.
- 5. The Aiding Official shall be responsible for maintaining all records for time, materials and equipment provided to the Requesting Party; be responsible for the operation and maintenance of equipment provided by the Aiding Party; and report work process to the Requesting Party.
- F. Mutual Aid Resource List NIMS typed public works resources are included in the annual local emergency plan for each Constituent Municipality. The CVRPC shall annually distribute a list of the NIMS typed public works resources for all Constituent Municipalities. All original and updated NIMS typed public works resource lists shall be considered an addendum to, but not a modification of this Agreement.
- G. Funds Payable By Each Municipality the Constituent Municipalities agree that the funds, coming in the form of the amount of services provided by each Constituent Municipality shall be based on the resources available to them at the time aid and assistance is made by a Requesting Party in accordance with Section 4 Part A.

# **SECTION 4: REQUESTS FOR REIMBURSEMENT**

- A. Procedures for Reimbursement Unless the Aiding Party and the Requesting Party agree to a different structure in writing, the Requesting Party shall be ultimately responsible for the reimbursement of the Aiding Party's costs incurred under this Agreement.
  - 1. Within 30 days of the return of all personnel and equipment of the Aiding Party to the Constituent Municipality's homework station, the Aiding Municipality may submit to the Requesting Party, an invoice of all charges related to the aid provided pursuant to this Agreement. The invoice provided by the Aiding Party shall be paid within 30 days of receipt.
  - 2. All invoices generated by the Aiding Party shall be provided to the Requesting Party.
  - 3. Invoices by the Aiding Party shall follow the following standards.
    - a. Personnel. Charges for personnel shall be in accordance with the standard practices of the Aiding Party, including wages, salaries, contributions for insurance and retirement and personnel from the Aiding Party shall continue to accumulate seniority at the rate of the Aiding Party.
    - b. Equipment. Charges for equipment supplied by the Assisting Party, shall be reimbursed at the rental rate established for the same or substantially similar equipment by the regulations of the Federal Emergency Management Agency (i.e., current FEMA Schedule of Equipment Rates), or at any other rate agreed to by the Aiding Party and Requesting Party in writing. Rent for equipment includes the cost of fuel and other consumable supplies, maintenance, service, repairs and ordinary wear and tear.
    - c. Transportation. The Aiding Party shall transport needed personnel and equipment by reasonable and customary means and in accordance with the Aiding Party's usual transportation and travel payment schedule. If such a schedule is unavailable, transportation charges shall be the reasonable and customary rates for such transportation.
    - d. Materials and Ancillary Expenses. Charges for materials and ancillary expenses such as consumable supplies, related to the provision of aid pursuant to this agreement shall be the reasonable and actual costs incurred by the Aiding Municipality.

4. The Aiding Party may invoice the Requesting Party for all expenses incurred during the Period of Assistance. All invoices shall be submitted by the Aiding Official to the Requesting Official. The invoices shall clearly delineate the time and expenses associated with personnel, equipment, transportation and any materials or ancillary expenses. Any question or dispute about an invoice from an Aiding Party shall first be discussed between the Requesting Official and the Aiding Official. If the Parties are still unable to reconcile an invoice, then they shall follow the next sequential procedures of the Dispute Resolution section of this Agreement.

#### **SECTION 5: INSURANCE AND LIABILITY**

- A. Insurance Each Constituent Municipality shall bear the risk of its own actions, as it does with its day-to-day operations. The Aiding Party shall be responsible for providing insurance to the fullest extent possible, including but not limited to workman's compensation insurance, general liability insurance, excess liability insurance, and any other types of insurance coverage in amounts recommended by the Vermont League of Cities and Towns, Property and Casualty Intermunicipal Fund (VLCT-PACIF). Such insurance shall cover damage or injury to person, property or equipment owned or provided by an Aiding Party to the extent the damage or injury may have occurred while rendering aid to a Requesting Party.
- B. Indemnification To the extent allowed by law, each Requesting Partyagrees to indemnify and hold harmless any Aiding Party and its employees, officers, administrators, elected officials and agents from any claim relating to cost, damage or injury of any description to any person or property caused by or through the action of any Aiding Municipality while rendering aid pursuant to his Agreement. Acts of gross negligence, willful misconduct, malfeasance, and/or criminal/illegal behavior are exempt from indemnification.
- C. Liability No Constituent Municipality shall have any liability to any other Constituent Municipality by reason of their inability or lack of desire to respond to a request for aid.

#### SECTION 6: TERM, MODIFICATION AND PERIODIC REVIEW

- A. Term This Agreement shall be in effect for one (1) year from the date signed by the initial Constituent Municipality. Thereafter, this Agreement shall be renewed for additional one year terms on an annual basis in conjunction with the local emergency plan.
- B. Termination Any Constituent Municipality may voluntarily terminate and withdraw from its participation in this Agreement at any time by a Requesting or Aiding Official giving written notification to the designated Requesting or Aiding

Officials of all other Constituent Municipalities to this Agreement. Electronic mail communications shall be considered written notification for purposes of this Agreement. Termination and withdrawal shall not be effective until sixty (60) days after written notification has been sent. Withdrawal by a Constituent Municipality shall not impact the liability or obligation incurred by the Constituent Municipality under this Agreement prior to the date of termination.

- C. Modification Pursuant to 24 V.S.A. § 4345b(d)(4) any modification or amendment to this Agreement shall not become effective unless approved by the CVRPC and the legislative body of all the municipalities who are a party to this Agreement. The CVRPC shall assist in coordinating any modifications or amendments to this Agreement.
- **D. Periodic Review** On a biennial basis, the designated Aiding and Requesting Officials shall meet to review the terms of this Agreement and make any suggestions as to alterations or modifications if needed base on past performance. The CVRPC shall coordinate all meetings under this section.

#### **SECTION 7: MISCELLANEOUS PROVISIONS**

- A. Dispute Resolution In respect to any dispute that arises pursuant to this agreement the Parties shall first make a good faith effort to work out differences among themselves. Should informal discussions between the Parties fail, then the Parties shall engage the services of a mutually agreed upon third party mediator. The costs of this third party mediator shall be split evenly between the Parties. Should attempts at mediation though a third party mediator fail, then any Party may seek redress in any Vermont Court of competent jurisdiction.
- B. Severability Should any clause, portion, section, provision or any other part of this Agreement be held invalid by a court of competent jurisdiction, such judgment shall not affect, impair or invalidate any other portion of the Agreement. The remaining portions of this Agreement shall remain in full force and effect without regard to the provisions that have been invalidated.
- C. Execution of Counterparts This agreement may be signed in any number of counterparts with the same effect as if the signatures thereto and hereto were upon the same instrument.

NOW THEREFORE, both the Central Vermont Regional Planning Commission through its duly authorized representative has executed this agreement and all counterparts thereto.

Photographic copies shall be considered valid counterparts.

Each of the Constituent Municipalities so desiring, have caused this Agreement to be executed by a duly authorized representative, after a vote allowing that duly authorized representative to execute this Agreement by the Constituent Municipality's governing

legislative body.

Adopted by the Board of Commissioners: January 14, 2025.

Gerald D'Amico, Chair CVRPC Board of Commissioners

Photographic copies shall be considered valid counterparts.

Each of the Constituent Municipalities so desiring, have caused this Agreement to be executed by a duly authorized representative, after a vote allowing that duly authorized representative to execute this Agreement by the Constituent Municipality's governing legislative body.

The following municipalities have elected to participate in the Central Vermont Regional Public Works Mutual Aid Agreement for 2025. Copies of signature pages are on file at the Central Vermont Regional Planning Commission.

2025 Central Vermont Regional Public Works Mutual Aid Agreement Participating Municipalities: Listed on next page.

# Municipalities

	Plainfield	
Barre City		
	Roxbury	_
Barre Town	ROADUTY	
Berlin	Waitsfield	
Derim		
·	Warren	
Cabot		
	Washington	_
Calais	,,,,,,,,,,,,,,,,,,,,,,,,,,,,,,,,,,,,,,,	
		_
Duxbury	Waterbury	
×		
7 . 7	Williamstown	
East Montpelier		
	Worcester	_
Fayston		
	Woodbury	_
Middlesex	Woodbary	
Montpelier		
Montponer		
Moretown		
Northfield		
Orange		

# CENTRAL VERMONT REGIONAL PLANNING COMMISSION PUBLIC WORKS MUTUAL AID AGREEMENT AID REQUEST FORM

To be completed by the Requesting Official.

Incident Name: Briefly describe the nature of the disaster or emergency prompting the aid request.  Damages and Needed Repairs: Briefly describe the infrastructure impacted and the specific work needed to repair the infrastructure.  Specific Assistance Needed: Briefly describe what type of assistance (personnel, equipment, materials) is needed.
Specific work needed to repair the infrastructure.  Specific Assistance Needed: Briefly describe what type of assistance (personnel.
<b>Specific Assistance Needed:</b> Briefly describe what type of assistance (personnel, equipment, materials) is needed.
<b>Cost Estimate and Schedule:</b> Provide an estimate for the needed assistance and period of time it will be needed for (start and end dates).
Plan for Meeting with Aiding Official to Review Project Scope (Optional): Briefly describe, if needed, the Requesting Official's plan for meeting with the Aiding Official to review the scope of work and for the Requesting Official to familiarize him/herself with the personnel and equipment of the Aiding Party.
Requesting Official Signature:
Date: Time:
To be completed by the Aiding Official.
Request: Approved Denied (Reason)
Resource Deployed: Date: Time:
Cost Estimate:
Aiding Official Signature:
Date: Time:

#### DESIGNATED OFFICIALS BY TOWN

Municipality	Name	Phone - Primary	Phone - Alternate	Email
Barre City				
Requesting Official – Primary				
Requesting Official - Alternate				
Aiding Official - Primary				
Aiding Official - Alternate				
Barre Town				
11				<del>16-1</del>
		-		
3erlin				
	<del> </del>	<del> </del>		
Cabot				
		_		
Calais	-			
Duxbury				
	-			
last Montpelier				

#### DESIGNATED OFFICIALS BY TOWN

	~~~		
		,	

DESIGNATED OFFICIALS BY TOWN

140			
lainfield			
oxbury	 		
oxbury	 		
Vaitsfield			
arren			
		-	
		 	
/ashington			
asungton	 +		
/illiamstown			
/oodbury			

DESIGNATED OFFICIALS BY TOWN

Vorcester			
~ 1 hr 1			

NIMS TYPED PUBLIC WORKS RESOURCES BY TOWN FOR 2022

	Town 1	
Marine Vessel		
Firefighting, Brush Patrol Engine		
Fire Engine (Pumper)		
Firefighting Crew Transport		
Hand Crew		
Water Tender (Tanker)		
Air Compressor		
Generator		
Grader		Miles
Hydraulic Excavator, Medium Mass Excavation		
Street Sweeper		
Snow Blower (Track Mounted)		
Track Skid Steer		
Track Loader		
Trailer, Equipment Tag Trailer		
Truck, On-Road Dump		
Truck, Plow		
Water Pumps, De-Watering		
Water Truck		
Wheel Loader, Backhoe		
Wheel Loader, Small		
Wheel Loader, Medium		
Wheel Loader, Large		
Wood Chipper		

TOWN OF NORTHFIELD AMBULANCE ABATEMENTS

Nama	Balanca	Date of
Name	Balance	Service
	\$41.00	04/02/20
	\$133.10	04/13/20
	\$136.54	05/01/20
	\$22.90	05/11/20
	\$109.89	05/13/20
	\$127.78	05/20/20
	\$946.50	05/21/20
	\$118.52	05/25/20
	\$147.60	05/31/20
	\$922.70	06/11/20
	\$250.00	06/14/20
	\$135.31	07/03/20
	\$250.00	07/03/20
	\$124.78	07/06/20
	\$250.00	07/09/20
	\$1,441.90	07/22/20
	\$988.00	07/27/20
	\$215.84	08/01/20
	\$853.70	08/02/20
	\$98.35	08/12/20
	\$250.00	08/12/20
	\$107.82	08/14/20
	\$89.94	08/25/20
	\$100.00	08/26/20
	\$250.00	08/28/20
	\$100.00	09/01/20
	\$129.61	09/04/20
	\$72.47	09/07/20
	\$993.10	09/14/20
	\$242.32	09/29/20
	\$170.37	09/30/20
	\$108.05	10/07/20
	\$140.20	10/21/20
	\$83.28	10/25/20
	\$250.00	10/25/20
	\$217.60	10/28/20
	\$22.47	10/28/20

TOWN OF NORTHFIELD AMBULANCE ABATEMENTS

Name	Balance	Date of Service
	\$208.32	11/09/20
	\$977.80	11/10/20
	\$904.50	11/12/20
	\$894.50	11/24/20
	\$996.50	11/28/20
	\$123.62	11/29/20
	\$984.60	12/05/20
	\$1,013.00	12/11/20
	\$281.10	12/31/20
	\$1,062.30	01/06/21
	\$198.02	01/27/21
	\$232.58	01/29/21
	\$83.10	02/11/21
	\$199.54	02/19/21
	\$109.93	02/19/22
	\$942.10	02/23/23
	\$122.69	02/23/23
•	\$943.80	02/23/2:
	\$83.10	03/05/2:
	\$931.90	03/11/2:
	\$83.10	03/15/2:
	\$250.00	03/15/2:
	\$906.12	03/18/2:
	\$122.23	03/31/21
	\$250.00	04/04/21
	\$223.81	04/04/21
	\$250.00	04/21/21
	\$56.24	04/26/21
	\$122.46	04/27/21
	\$250.00	05/11/21
	\$127.08	05/11/21
	\$250.00	05/12/21
	\$1,106.70	05/24/21
	\$238.80	05/26/21
	\$19.14	06/13/21
	\$250.00	06/14/21
	\$100.00	06/27/21

TOWN OF NORTHFIELD AMBULANCE ABATEMENTS

lame	Balance	Date of Service
ianic		
	\$100.00	06/29/2
	\$989.00	07/05/2
	\$100.00	07/08/2
	\$42.34	07/28/2
	\$108.09	08/16/2
	\$108.55	08/20/2
	\$523.00	08/23/2
	\$1,048.70	08/23/2
	\$268.64	08/24/2
	\$899.93	08/29/2
	\$996.00	09/02/2
	\$239.58	09/05/2
	\$250.00	09/17/2
	\$272.82	09/19/2
	675.00	09/25/2
	\$1,725.90	10/04/2
	\$329.60	10/07/2
	\$92.10	10/10/2
	\$133.10	10/18/2
	\$932.90	10/31/2
	\$66.60	11/01/2
	\$183.10	11/06/2
	\$309.30	11/10/2
	\$229.00	11/11/2
	\$136.32	11/12/2
	\$1,112.60	11/24/2
	\$725.00	01/01/2
	\$189.85	01/08/2
	\$838.57	01/12/2
	\$129.94	01/17/2
	\$996.80	01/18/2
	\$1,137.80	01/18/2
	\$275.00	01/20/2
	\$280.00	01/29/2
	\$564.40	01/30/2
	\$986.00	02/08/2
	\$1,670.40	02/20/2

TOWN OF NORTHFIELD AMBULANCE ABATEMENTS

		Date of
Name	Balance	Service
	\$280.00	02/23/2
	\$2,105.00	02/23/2
	\$128.73	03/04/2
	\$50.85	03/08/2
	\$1,116.20	03/11/2
	\$113.62	03/16/2
al .	\$1,112.60	03/17/2
	\$1,130.60	03/21/2
	\$169.04	03/22/2
	\$100.00	03/23/2
	\$43.96	03/24/2
	\$202.71	04/02/2
	\$118.28	04/06/2
	\$96.08	04/16/2
	\$130.43	04/16/2
	\$1,188.80	05/02/2
	\$100.00	05/06/2
	\$275.00	05/09/2
	\$1,280.60	05/12/2
	\$227.30	05/13/2
	1,165.40	05/16/2
	\$270.00	05/23/2
	\$1,088.60	06/08/2
	\$1,127.00	06/11/2
	\$129.94	06/16/2
	\$280.00	06/18/2
	\$115.56	07/16/2
	\$275.00	07/21/2
	\$275.00	07/22/2
	\$1,127.00	07/24/2
	\$1,170.80	07/26/2
	\$176.34	07/27/2
	\$143.15	07/29/2
	\$1,128.80	08/04/2
	\$275.00	08/12/2
	\$275.00	08/17/22
	\$998.60	08/20/22

TOWN OF NORTHFIELD AMBULANCE ABATEMENTS

Jame	Balance	Date of Service
	\$150.00	08/24/22
	\$111.08	08/24/22
	\$567.82	08/27/22
	\$150.00	08/29/22
	\$359.09	08/30/22
	\$98.22	08/31/22
	\$98.40	08/31/22
	\$143.76	09/01/22
	\$989.40	09/09/22
	\$129.94	09/10/22
	\$294.08	09/13/22
	\$137.96	09/14/22
	\$95.90	09/16/22
	\$270.00	09/23/22
	\$50.36	09/30/22
	\$412.51	09/30/22
	\$45.99	09/30/22
	\$163.64	10/06/22
	\$250.00	10/10/2
	\$78.35	10/11/22
	\$566.20	10/12/22
	\$1,062.20	10/13/22
	\$100.00	10/16/22
	\$362.56	10/21/22
	\$1,020.00	11/06/22
	\$362.43	11/07/22
	\$250.00	11/11/22
	\$19.75	11/14/22
	\$275.00	11/24/22
	\$275.00	11/26/22
	\$230.00	11/30/22
	\$275.00	12/01/22
	\$1,313.00	12/01/22
	\$143.47	12/03/22
	\$280.00	12/03/22
	\$846.00	12/04/22
	\$300.00	12/17/22

TOWN OF NORTHFIELD AMBULANCE ABATEMENTS

Name	Balance	Date of Service
	\$79.80	12/19/22
	\$964.40	12/30/22
	\$1,180.40	01/09/23
	\$116.46	01/17/23
	\$1,132.40	01/20/23
	\$250.00	01/22/23
	\$787.07	01/25/23
	\$10.00	01/25/23
	\$119.02	01/25/23
	\$105.00	01/26/23
	\$250.00	02/14/23
	\$325.00	02/19/23
	\$1,194.20	03/16/23
	\$237.52	03/25/23
	\$250.00	03/26/23
	\$250.00	03/26/23
	\$150.00	03/27/23
	\$435.23	04/01/23
	\$71.13	04/15/23
	\$226.00	04/17/23
	\$1,057.20	04/21/23
	\$139.60	05/01/23
	\$150.00	05/04/23
	\$139.35	05/07/23
	\$300.00	05/16/23
	\$139.35	05/21/23
	\$588.08	05/21/23
	\$92.61	05/30/23
	\$424.60	06/05/23
	\$139.61	06/16/23
	\$250.00	06/20/23
	\$150.00	06/23/23
	\$150.00	07/01/23
	\$290.00	07/01/23
	\$1,287.60	07/03/23
	\$126.94	07/03/23
	\$122.98	07/04/23

TOWN OF NORTHFIELD AMBULANCE ABATEMENTS

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		\$150.00	11/26/23

TOWN OF NORTHFIELD AMBULANCE ABATEMENTS

At collection over one year, deceased, or bankruptcy.

Name		Balance	Date of Service
		\$141.20	12/12/23
		\$139.61	12/27/23
		\$48.00	12/29/23
		\$129.05	12/29/23
		\$150.00	01/03/24
		\$150.00	01/17/24
		\$987.80	02/05/24
		\$150.00	02/09/24
	*	144.81	03/26/24
	*	137.16	06/11/24
	*	89.64	06/17/24
	*	84.31	06/30/24
	*	89.78	07/06/24
	*	88.49	11/29/24
	*	89.36	12/30/24
TOTAL ABATEMENTS		\$105,735.70	

^{*} Account included as patient is deceased and account is marked closed by the collection agency.

The Select Board hereby abates the above listed Ambulance Receivables in the amount of \$105,735.70. Dated this 12th day of August, 2025. Effective 06/30/25.

Select Board Chair	

Town Manager Report

Main Street Bridge Project

VTran's Project Manager Gary Laroche plans to attend the Board meeting to present the final plans for the Main Street Bridge project. A copy of the plans was in the Board packet's for the previous meeting.

The proposed bridge will have two-11-foot-wide vehicle traffic lanes, two-three-foot-wide buffer lanes, two-five-foot-wide bike lanes and two-seven-foot-wide sidewalks. The lighting includes a new lighting scheme with light poles and fixtures similar to the existing lights in the Downtown area.

As stated in the past, the project includes an estimated bridge closure period of 12 weeks with a vehicle and small truck traffic detour onto Water and Wall Streets. Large trucks will be detoured to a regional route including Interstate 89, Route 64 and Route 12.

The plans include a comprehensive traffic and pedestrian plan for the traffic detour period which includes numerous detour signs, sidewalk closure signs, pedestrian detour signs, temporary crosswalk markings, temporary curb ramps, pedestrian barricades, temporary improved walking surfaces, and longitudinal channelizing device.

VTrans has provided a revised cost estimate of \$13,455,783 for the bridge project, which includes engineering, right of way and construction. The project funding is 80% Federal, 15% State and 5% Town, which results in the Town's project costs at \$672,789. The Town currently has \$334,524 in the CIP for the bridge project.

Cheney Farm Post-Construction Parking and Accessibility

As discussed previously, the contractor for the Cheney Farm water tank replacement is required to restore the site upon completion of the tank project.

Below are the water tank project plan notes that detail the requirement that all disturbed grass areas be restored.

Plans – Sheet G1, Note 11 "ALL DISTURBED GRASSED AREAS SHALL BE RESTORED TO CLASS A RESTORATION UNLESS OTHERWISE SHOWN. REFER TO SPECIFICATIONS FOR ADDITIONAL INFORMATION. CONTRACTOR IS RESPONSIBLE FOR REMOVAL, CARE AND REPLANTING OF ALL PLANTING AND SHRUBS DISTURBED DURING CONSTRUCTION."

Specifications – Section 02921 "Restoration of lawns and grasses" Section 1.01.A "Finishing, topsoiling, grading, fertilizing, seeding and maintaining all seeded areas as shown on the Drawings and/or specified herein, and any other areas disturbed by the CONTRACTOR'S operations."

Any new permanent parking lot on the Cheney Farm will require conditional use approval by the DRB. No State permits would be required for a parking lot.

Ambulance Fee Abatement

The Select Board is being asked to abate past ambulance fees. All fees for abatement are over one year old, unless the person is deceased. Also, the fees on the list have been removed from the Town's accounts receivable.

The fee collection process involves the Town's outside billing agency sending the patient three billing notices and a call. Next, the invoice is placed with a collection agency and placed on a credit rating system. Please note that the past due invoice remains on the patient's credit rating after the Town abates the invoice and the Town can still accept payment.

Main Street Water Line and Cheney Farm Tank Replacement Projects

The Main Street water line contractor will continue installing new water lines with work occurring on Main Street. The contractor has nearly completed the installation of the duct bank on Main Street near the Dominos property. The contractor also plans to start installing new water lines on Prospect Street which should take several weeks.

The contractor for the water tank replacement project has completed removal of the existing tanks and site preparation for the installation of the new tanks.

Vine Street Sidewalk Project

The contractor for the Vine Street sidewalk project has completed the curbing installation and the concrete for sidewalk sections. The last remaining work is the patch paving along the curbing. The project remains on schedule for completion by August 15.

Utility Shut off Notices

In the packet is an email from a resident raising concerns about the US Postal Service's failure to deliver a utility shutoff notice. As we have all experienced, the US Postal Service in the past few years has experienced a disruption and delays in mail delivery, which is an issue that is difficult to solve. Please note that the Utility Billing Office takes extra effort and uses several steps to notify a resident of delinquent bills and impending shutoff. First the Utility Billing Office sends notices of delinquent bills which is followed by shutoff notices. Also, they email and call customers (if available) to inform them of the impeding shutoff. Next, the Utility Department employees prior to the actual shut off knock on the resident's door to make them aware of the shutoff and to provide an opportunity to pay their utility bill.

Project Tracker

					Project List	8/8/2025	
Project List	Status	Project Cost	Funding Source	Assigned	Start Date/Bid	Completion Date	Project Notes
Main St. Bridge Replacement Project	In Progress	\$8,900,000	State of VT, Municipality	VTrans and TM	11/1/2025	10/1/2026	VTrans has completed the final plans and will present to Board August 12. Project construction Spring 2026.
Main St. Water Line and Tank Project	Construction Phase	\$7,230,000	State of VT , Municipality	Engineer, TM	7/1/2024	11/15/2025	Water line contractor installing water lines. Site is ready for new tanks.
Route 12 and 12 A Sewer Expansion	Planning Phase	\$8,950,000	TBD	TM, Engineer	TBD	TBD	State approved 50% funding for study and plan update. Engineer working on update.
July Flooding, FEMA Disaster	In Progress	TBD	FEMA, State, Town	Town Staff	8/1/2023	TBD	The Town has received about 80% of the anticipated FEMA and State funding.
Cabot/Northfield Stormwater	In Progress	\$125,000	State of Vermont	TM, Consultant	10/1/2022	6/1/2026	Engineer completed plans. Engineer to bid the project,
Lovers Lane	Planning Phase	TBD	State of Vermont, Town	TM, HF, SB Comm.	7/25/2025	Fall 2025	Town received \$200,000 State grant. Awarded bid for project.
310 Water Street - FEMA Buyout	In Progress	\$285,000	FEMA, State Vermont	FEMA, State, TM	7/1/2022	TBD	FEMA and State of VT. have awarded full funding for buyout. Awarded bld for building demolition.
Wall St. Pedestrian - Design Phase	In Progress		State of Vermont	TM, Vtrans	01/1/2025	12/31/2027	Pedestrian Improvements on Wall Street to Dog River Park. Town awarded grant funds for design and construction. Project kick off meeting held 7/15/2025.
Cross Brothers Dam Project	In Progress	\$955,000	FEMA, State Vermont	VNRC, TM	10/1/2023	TBD	Engineer is preparing final plans and obtaining permits. Dam Removal scheduled for 2025.
491 Water Street - FEMA Buyout	In Progress	TBD	State of Vermont	TM,	5/1/2024	TBD	The property owner signed required documents. State processing the documents.
Historic Bridges	Scoping Phase	TBD	State of Vermont	State of Vermont	3/23/2023	TBD	The State selected four bridges in Northfield for structural analysis and rehab: Rabbit Hollow Bridge and three covered bridges on Cox Brook Road. Scoping for all bridges is underway.
Sewer Plant Permit Issues	Pending	TBD	Utility Commission	Town Manager	4/1/2023	TBD	Sewer Plant Permit Issues
Advanced Meter Infrastructure (AMI)	Planning Phase	\$950,000	State of VT and Utilities	TM, Utilities	9/1/2023	6/1/2026	Installing electric and water smart meters. Meter installation in late Summer 2025
King Street Battery Storage	Planning Phase	TBD	Developer	Developer, VPPSA	TBD	TBD	Developer needs to prepare and submit agreements to VPPSA and Town.
Riverwalk Path	Planning Phase	TBD	Town - ARPA	Committee	TBD	TBD	Dollar General donating land for path. Boundry survey completed, Deeds prepared,
Pool House Rebuild Plans	Planning Phase	\$36,000	Town- APRA	TM, SB Committee	03/1/2025	10/15/2025	Building evaulation and design plans. Architect working on project plans.
Dole Hill sump issues	Engineering Phase	TBD	Town	Engineer, TM	4/1/2024	TBD	Engineer working on engineering plan. Received preliminary engineering report.
Town Bridge 56, Highway 54	Planning Phase	\$200,000	Town	TM, Contractor	TBD	TBD	Town is adding funding to the CIP
Vine Street Pedestrain Bridge	Planning Phase	TBD	Town	TM, Contractor	TBD	TBD	Obtaining quotes
Vine and Cross Sidewalk Project	Construction Phase	\$400,000	ARPA Funds	TM, Engineer	6/15/2024	8/15/2025	Contractor has started the project. Estimated project completion date is August 15.
DEI Training	In Progress	No Cost	N/A	Board	4/26/2025		A representative of the VT office of Racial Equity Education attended 4/22 Select Board meeting







Vermont League of Cities and Towns

89 Main Street, Suite 4 Montpelier, VT 05602 PRSRT STD U.S. Postage PAID Burlington, VT Permit No. 253

Training tracks for:

- Clerks and Treasurers
- Listers and Assessors
- Highway and Road officials
- Town Managers and Administrators
- Selectboard/City Council Members

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Selectboard Northfield Town 51 S Main St Northfield VT 05663-6703

October 8

DoubleTree by Hilton South Burlington

REGISTRATION IS OPEN!



NextGen Vermont:

Navigating 21st Century Governance



October 8

DoubleTree by Hilton South Burlington

2025 Highlights include:

- Roundtable discussions with a full breakfast.
- A powerful **keynote by Tamily fer** of The Dignity Index.
- **Training tracks** tailored to arr role and multiple discussion-based sessions to share you knowledge and learn from others.
- A bustling **tradeshow**, where you can explore tools, services, and solutions to support your community.
- Lunch and awards presentation, honoring outstanding public service with VLCT's Lifetime Achievement, Municipal Service, and Legislative Service Awards.
- An end-of-day ice cream social and raffle prize drawing.



Early bird pricing ends 8/30

VLCT.ORG/TF25



TOWN OF NORTHFIELD, VERMONT HIGHWAY PLANNING & PROJECT OVERSIGHT SUBCOMMITTEE Minutes of August 1 2025

I. ROLL CALL. Select Board members Charles Morse, Merry Shernock, and John Stevens. Also present were Town Manager Jeff Schulz, Karl Bailey (Highway Foreman), Miles Jenness (Vermont Heavy Timber), Dennis Donahue, Kristy Kenyon, Stephen Korrow, Austin Nava, and David Tomczyk.

The meeting started at 8:05 a.m.

II. PUBLIC PARTICIPATION (Scheduled): None.

III. DISCUSSION

- a. Highway Projects.
 - Slaughterhouse Road Covered Bridge. Manager Schulz said he contacted Daniels Construction in April 2025 in order to obtain cost estimates for needed repairs to all the covered bridges. They did provide some recommendations and cost estimates. More recently, he was meeting with Miles Jenness from Vermont Heavy Timber regarding another project and asked him to take a look at the Slaughterhouse Road Covered Bridge. At that time, Mr. Jenness found that the bridge had significant structural problems and recommended that its maximum weight limit be reduced from 16,000 lbs. to 6,000 lbs. Manager Schulz contacted the Vermont Agency of Transportation (VTrans), which quickly dispatched bridge inspectors who agreed with this recommendation. Manager Schulz then reviewed the Town Highway budget and found there were sufficient funds to address this matter on an emergency basis. Board member Morse agrees that this is an emergency situation that requires waiving certain provisions of the municipal purchasing policy, i.e. sealed bids, etc. Mr. Jenness said there is water now running across the bridge that is further undermining its structural stability. His plan is to install temporary steel beams into the river bedrock, which would immediately return the bridge's maximum weight limit to 16,000 lbs. This emergency work would be done right after a work contract has been signed. Later this autumn, longer term repairs would be done in replacing the current rotting wooden beam supports and the steel beams would be removed. Mr. Jenness estimated the total cost of this project at \$142,000. Board member Morse said the bridge's restored 16,000 lbs. weight limit could be further increased at a later time with additional measures but that would be a discussion for another time. He added that we now have about ten (10) days of dry weather so the emergency work should be done as soon as possible. Board member Morse then noted that Board member Stevens has suggested using a used conveyor belt to prevent more water from crossing the bridge. There are other possible options. Manager Schulz said there might be some funds available from the VTrans historic structures preservation program for a project of this nature. He has already made contact about this possibility. Dennis Donahue felt that even with the improved structural stability, the covered bridge entrances are still too low and narrow for complete access for emergency vehicles, etc. He would be reluctant to put too much money into expensive repairs. Steve Korrow agrees with this, stating that a new road from Aseltine Road and Dukette Road could be built to service the area west of the bridge.

Mr. Korrow believes this covered bridge was constructed to service a slaughterhouse and small farms and was neither designed nor intended to bear heavy loads. Mr. Donahue said another possible route for a new access road could be built on his parents' property with egress at Horse Lane. Kristy Kenyon believes the current Slaughterhouse Road Covered Bridge is a community asset that draws a lot of visitors to Northfield, especially during foliage season. She suggested that the current bridge could be preserved for historic purposes while a new, modern bridge could be built nearby that could accommodate heavy traffic loads. Manager Schulz said such a replacement bridge would have to be fully engineered and this process would take a several years. He felt the best immediate solution was to provide the emergency repairs Mr. Jenness has recommended. Board member Morse doesn't see any alternative to spending money on this bridge both in the short- and long-term. The residents who need this bridge to access their homes require immediate relief. Board member Stevens agrees with this necessity. Manager Schulz then noted that under the purchasing policy, the Town Manager does have the authority to authorize spending funds for emergency bridge repairs. Board member Morse felt this action does have broad support. Motion by Board member Stevens, seconded by Board member Shernock, to authorize Manager Schulz to reach an agreement with Vermont Heavy Lumber to perform emergency stabilization work on the Slaughterhouse Road Covered Bridge at an estimated cost of \$142,000. Motion passed 3-0-0.

Mr. Jenness again indicated that the work on the bridge would start as soon as the project contract has been drafted and signed. Board member Morse believes that Mr. Jenness would be in a better position to make further recommendations for long-term repairs to the bridge once he has started on the emergency repairs and discovered all of the bridge's deficiencies. This could include raising the bridge's weight limit above 16,000 lbs. and making other upgrades that would allow for passage by emergency vehicles, delivery trucks, etc. Board member Morse said the Select Board would need to start budgeting over the next few years for these additional improvements. In the interim, making the recommended emergency repairs to this bridge is based on an important public safety concern and he hopes the work contract can be executed as soon as possible. Board member Morse also felt the municipality needs to do a better job in future in providing regular maintenance to all of its public bridges.

- IV. PUBLIC PARTICIPATION (Unscheduled). There was none.
- **V. ADJOURNMENT.** Without objection, the meeting ended at 8:53 a.m.

Respectfully submitted,

Kenneth L. McCann

Kenneth L. McCann, Acting Clerk

A video recording of this meeting is available at: https://youtu.be/8n1C_y5CrJ4

INFORMATION ONLY

From:

Mary Richter <secretgardenborzois@gmail.com>

Sent:

Friday, July 11, 2025 10:45 AM

To:

Charlie Morse

Cc:

Jeff Schulz; Douglas Reed

Subject:

Re: ~ USPS Miss-Delivers Utility Shut Off Notice ~

Yes. Main St., Northfield Post Office.

My long standing problem with them is that they deliver someone else's mail. It's not everyday by any means, but way too often.

Most recently it was the neighbor's shut off notice from the town, and just before that their most recent Trans-Video bill came here which Mark walked over to them.

When I discover someone else's shut off notice among my mail that obligates me to do something to make sure it doesn't happen again. At least that's how I feel about it. I'd be livid if my shut off notice was delivered to my neighbor.

This isn't a lack of personnel issue. This is a SLOPPY and CARELESS personnel issue.

- Mary -

On Wed, Jul 9, 2025, 17:58 Charlie Morse < cmorse@northfield.vt.us > wrote:

Doug, did you route this to Jeff?

Charlie

From: Mary Richter < secretgardenborzois@gmail.com>

Sent: Tuesday, July 8, 2025 2:53 PM

To: Jeff Schulz jschulz@northfield.vt.us; Charlie Morse cmorse@northfield.vt.us; Douglas Reed

<dreed@northfield.vt.us>; Mary Richter <secretgardenborzois@gmail.com>

Subject: ~ USPS Miss-Delivers Utility Shut Off Notice ~

Hi Jeff, Hi Charlie, Hi Doug,

I realize that you don't control the USPS but you should be aware that they can carelessly miss-deliver something as important as a utility shut office notice.

I turned my next door neighbor's (DeLary) utility shut off notice into the Electric Department yesterday so that they would know that it was delivered here by mistake in case that buys the consumer a bit of grace.

Unfortunately, I could have had it for up to two weeks because, other than personal letters or something important that I am watching for, I only open my mail every two weeks, or so.

This particular piece of DeLary's mail was discovered the night before

when I ripped it open only to find that the numbers didn't look right. That's when I spotted their name.

We've gotten a lot of this same neighbor's mail over the years, and Mark has walked it all over to their house. We're so tired of it that I brought it to the attention of the PO window clerk a few months ago telling him that this has to stop.

That clerk looked a white haired 70 year old lady in the eye and told me that I could just walk it over to them when I get their mail.

Big mistake.

"I don't get paid to deliver the mail. But you do! I'm 70 years old and Mark is 75. Neither one of us walks great. Plus, we don't get along with those people ever since Joel was really ugly because he couldn't get his way about a fence that we built. Next, they had multiple children incarcerated in federal penitentiaries for arson and drugs. We'd rather not have anything to do with them and you're not going to force us together!"

Things were better. Briefly.

I don't understand. This isn't rocket science. Sorting mail and putting it in the right box seems like something that any 12 year old kid could be trained to do in ten minutes, and they'd do it perfectly each and every time.

Trying to have a conversation about it with the local postal clerk has proven to be an utter waste of time. They run a sloppy ship and there's nothing that I can say to them that will make them straighten out what should be a simple thing.

But I did find a https://urldefense.proofpoint.com/v2/url?u=http-

3A usa.gov&d=DwlCaQ&c=euGZstcaTDllvimEN8b7jXrwqOf-

v5A CdpgnVfiiMM&r=QWTr2paJZ8C4iq61ViaMM1DtQY6Ay1p5rpam66WUH5E&m=-

Rqn4AEIONVtKU8DqiWtoKeAiYwHlbDJlT2GPnRAq8BPHRDehzD8yugniOaTlykf&s=Dk5RmqUThQFYa9poqIID7jsaQgbxOE

4QfOisanTyh4o&e= link to register formal postal complaints.

Perhaps taking a little heat from on high will remind them what a normal

level of service is. If/When you reach a similar level of frustration

with the service provided by our Northfield Post Office perhaps you will

consider filing your own formal complaint.

https://urldefense.proofpoint.com/v2/url?u=https-3A www.usa.gov postal-2Dservice-

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Thanks for your time,

Mary Richter

INFORMATION ONLY

From: SOV - Ethics Commission <SOV.EthicsCommission@vermont.gov>

Sent: Thursday, August 7, 2025 3:50 PM

To: Delaney, Peggy
Cc: Sivret, Christina

Subject: Municipal Ethics Information Session

As many of you have probably heard, the State Ethics Commission has had to suspend most municipal services due to lack of staffing.

As we chart a path forward, we would like to hear from you on how the Ethics Commission can best serve municipalities at our current resource levels. We will hold a Zoom session on August 14th from 2:30-3:30 p.m. to hear feedback and answer questions. We will hold a second Zoom session September (date TBD) for anyone who cannot make the first session.

We hope to see you there!

Topic: Municipal Ethics Informational Session

Time: Aug 14, 2025, 02:30 PM Eastern Time (US and Canada)

Join Zoom Meeting

https://us02web.zoom.us/i/83114802741?pwd=aRkrlAbXWRWbWP7QpuKQAg8kyJwxaE.1

Meeting ID: 831 1480 2741

Passcode: 456426

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